


REVISION / ISSUE:	DATE:
1. PPR SUBMITTAL	5/15/2018
2. DESIGN UPDATE	01/11/2019
3. PLANNING DIVISION SUB.	02/20/2019
4. PLANNING DIVISION REVIS.	03/20/2019
5. DESIGN UPDATE	04/10/2019
6. DESIGN UPDATE	07/16/2019
7. PLANNING DIVISION RESUB.	10/01/2019
8. PLANNING DIVISION REVIS.	11/08/2019
9. PLANNING DIV. RESUB.	04/13/2020
10. PLANNING DIV. REVIS.	06/23/2020
EXISTING & DEMO PLAN	

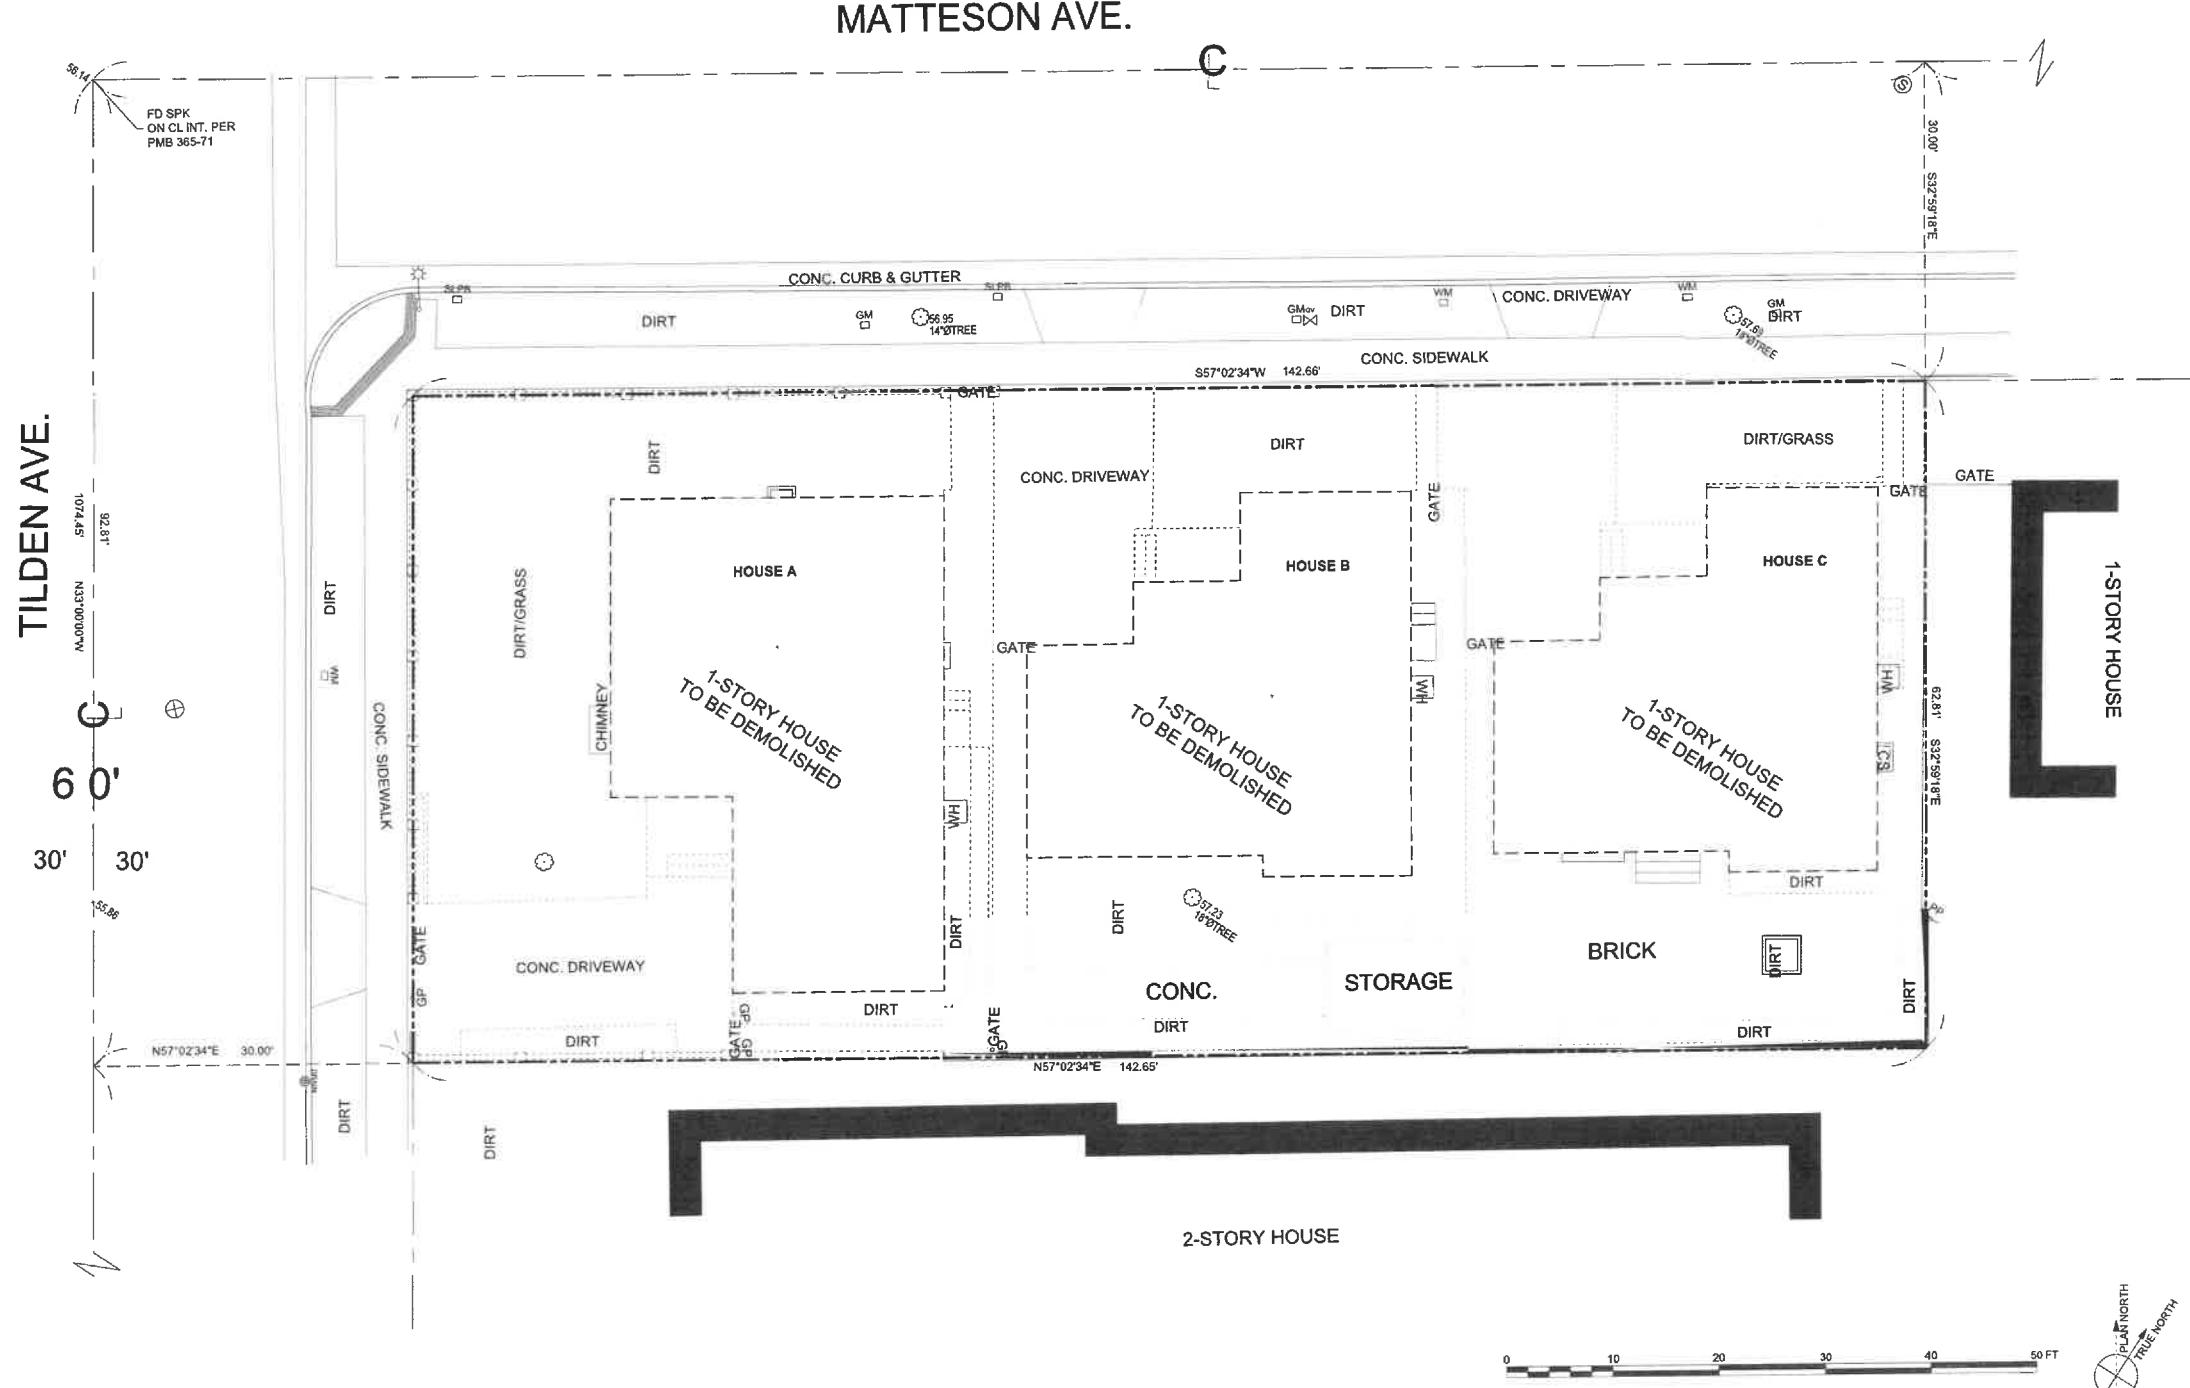

NOTES
ALL EXISTING STRUCTURES AND HARDCAPE TO BE DEMOLISHED

DEMO PLAN
Scale: 1'0" x 1'0"

1

PROJECT:
3906 TILDEN
CULVER CITY
(N) 5-UNIT CONDOMINIUM

ARCHITECT:


DesignUniversal
 ARCHITECTURE AND DESIGN
 ROBERT THIBODEAU
 624 VENICE BLVD
 VENICE, CA 90291
 PH: 310.452.8161
 FX: 310.452.8171
OWNER:
 1485 PH LLC
 380 LENOX AVE, #6J
 NEW YORK, NY 10027
 PH: 917.566.6477

CONTRACTOR:

3 HOUSE C
 Scale: 1'0" = 1'-0"

SOILS ENGINEER:
 HILLSIDE INSPECTIONS, INC.
 7622 GODDARD AVE.
 LOS ANGELES, CA 90045
 PH: 424.781.7152
 EMAIL: INFO@HILLSIDEINSPECTIONS.COM

SURVEYOR:
 M & G CIVIL ENGINEERING & LAND SURVEYING
 347 S. ROBERTSON BLVD.
 BEVERLY HILLS, CA 90211
 PH: 310.659.0874
 FX: 310.659.0845





STRUCTURAL ENGINEER:
 HKS STRUCTURAL DESIGN ENGINEERING
 1377 S BEVERLY GLEN BLVD #308
 LOS ANGELES, CA 90024
 PH: 310.497.0744
 EMAIL: HKSSTRUCTURAL @AOL.COM

CIVIL ENGINEER:
 HARVEY A. GOODMAN CIVIL ENGINEER
 834 17TH STREET UNIT 5
 SANTA MONICA, CA 90403
 PH: 310.829.1037
 FX: 310.828.5062

2 HOUSE B
 Scale: 1'0" = 1'-0"

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6. DESIGN UPDATE	07/18/2019
7. PLANNING DIVISION RESUB.	10/01/2019
8. PLANNING DIVISION REVIS.	11/08/2019
8. PLANNING DIVISION RESUB.	04/13/2020
9. PLANNING DIV. CONDITIONS	06/23/2020
10. PLANNING DIV. REVIS.	07/16/2020

EXISTING ELEVATIONS

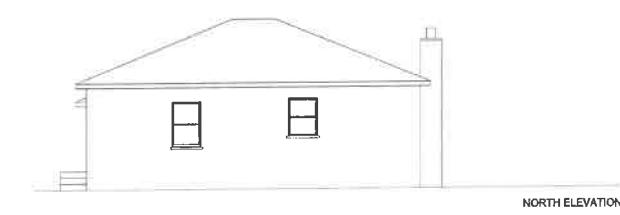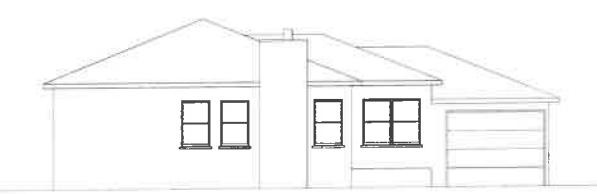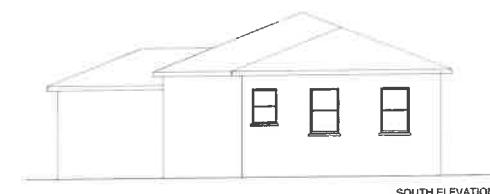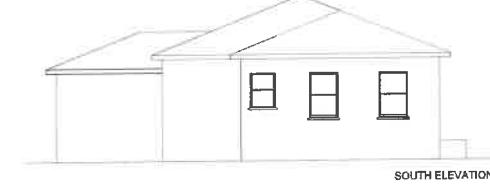

1 HOUSE A
 Scale: 1'0" = 1'-0"

DATE:
 07/16/2020 DRAWN:
 SBD SCALE:
 AS NOTED



NOTES
 ALL EXISTING STRUCTURES AND HARDSCAPE TO BE DEMOLISHED

A-0.3



DesignUniversal
ARCHITECTURE AND DESIGN

ROBERT THIBODEAU
624 VENICE BLVD
VENICE, CA 90291
PH: 310.452.8181
FX: 310.452.8171

OWNER:
1425 PH LLC
331 LENOX AVE, #6J
NEW YORK, NY 10027
PH: 917.585.6477

CONTRACTOR:

SOILS ENGINEER:
HILLSIDE INSPECTIONS, INC.
7622 GODDARD AVE
LOS ANGELES, CA 90045
PH: 424.781.7152
EMAIL: INFO@HILLSIDEINSPECTIONS.COM

SURVEYOR:
M & S CIVIL ENGINEERING & LAND SURVEYING
347 S. ROBERTSON BLVD.
BEVERLY HILLS, CA 90211
PH: 310.659.0871
FX: 310.659.0845

STRUCTURAL ENGINEER:
KMS STRUCTURAL DESIGN ENGINEERING
1377 S BEVERLY GLEN BLVD #308
LOS ANGELES, CA 90024
PH: 310.497.0744
EMAIL: KMSSTRUCTURAL@aol.com

CIVIL ENGINEER:
HARVEY A. GOODMAN CIVIL ENGINEER
834 1/2 ST ST UNIT 5
SANTA MONICA, CA 90403
PH: 310.829.1037
FX: 310.628.5062

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8. PLANNING DIVISION RESUB.	04/13/2020
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10. PLANNING DIV. REVIS.	07/16/2020



EXISTING SITE PHOTOS



DATE: 07/16/2020 DRAWN: SBD SCALE: NTS

A-0.4

SCALE 1"=30'

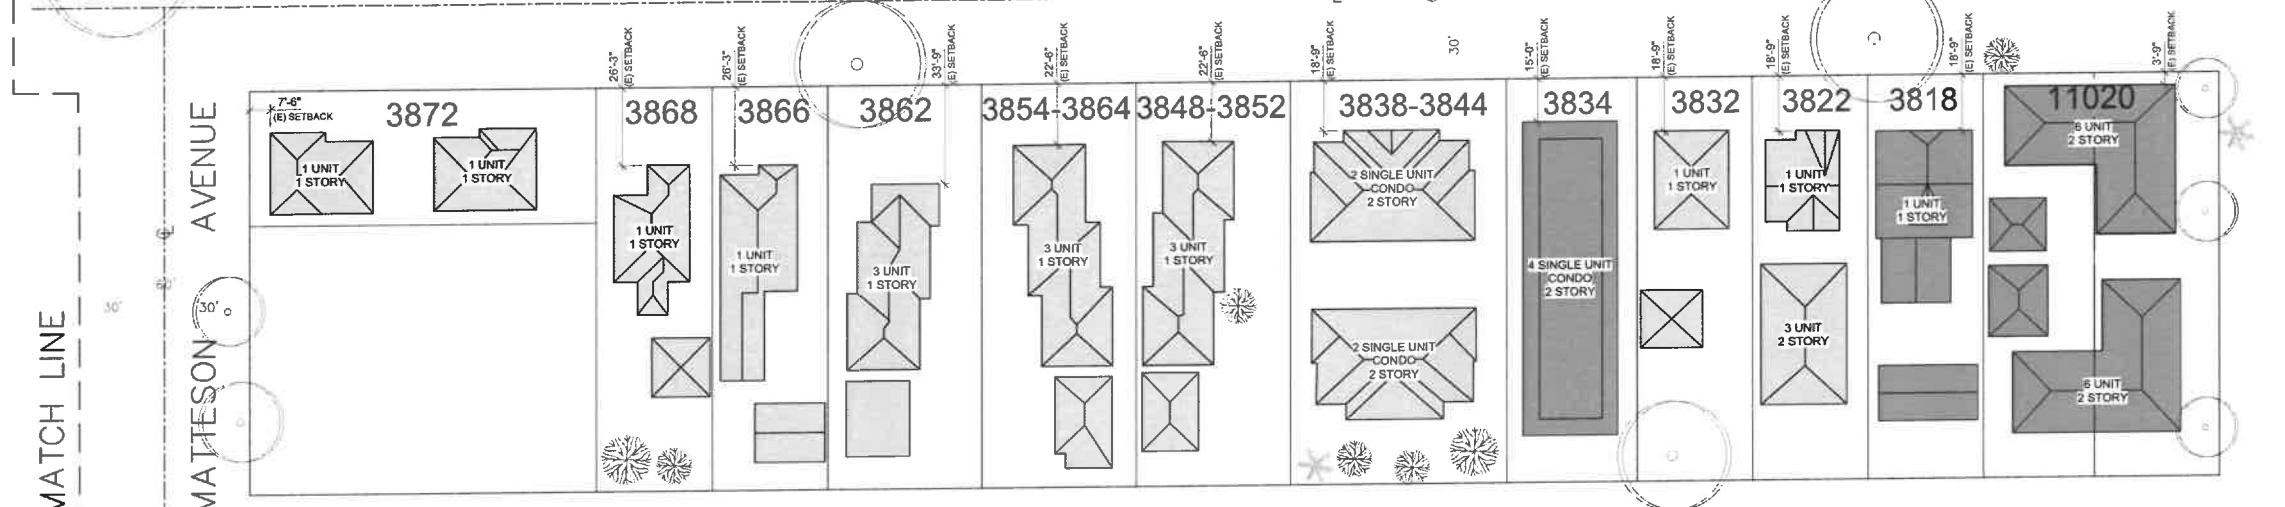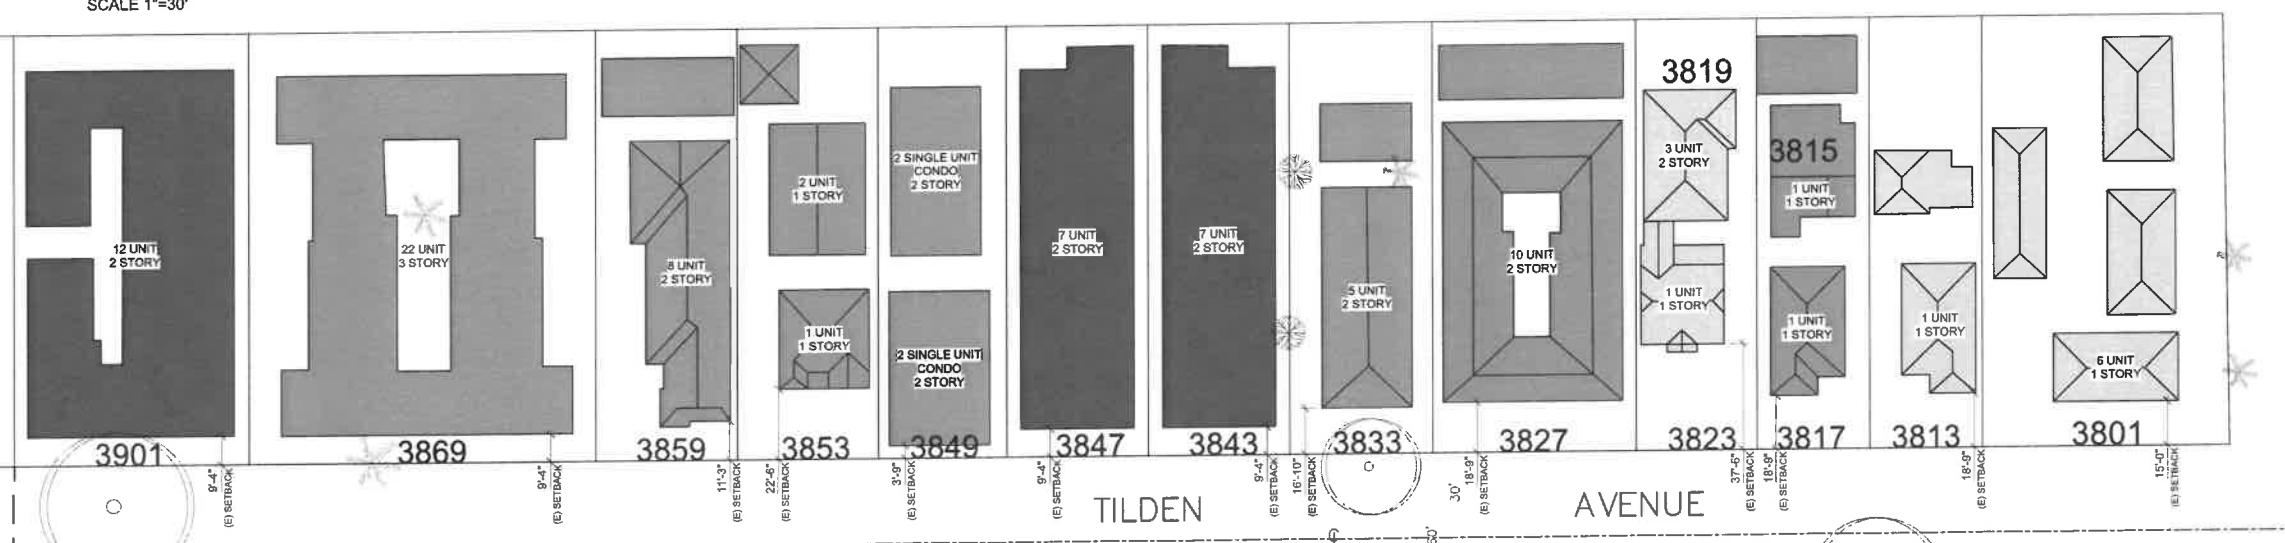

PROPERTY ADDRESS	LOT SIZE S.F.	BUILDING FOOTPRINT AREA S.F.	LOT COVERAGE RATIO S.F.	BUILDING ELEV. FT.
3801-3811 TILDEN AVE.	13295	4195	31.5%	17.94
3813 TILDEN AVE.	6080	1824	30%	15.47
3817 TILDEN AVE.	6080	3089	50.8%	15.80
3823 TILDEN AVE.	6507	2558	39.3%	18.04
3827 TILDEN AVE.	10944	6465	59.1%	24.22
3833 TILDEN AVE.	7723	3163	41%	24.31
3843 TILDEN AVE.	7600	5258	69.2%	23.41
3847 TILDEN AVE.	7600	5258	69.2%	23.78
3849 TILDEN AVE.	6933	3845	55.4%	21.29
3853 TILDEN AVE.	7600	3136	41.2%	17.40
3859 TILDEN AVE.	7600	4011	52.8%	34.10
3869 TILDEN AVE.	18667	9588	51.3%	30.22
3901 TILDEN AVE.	12587	8287	65.8%	21.54
11020 VENICE BLVD.	9033	5255	58.2%	24.24
3818 TILDEN AVE.	5851	2553	43.6%	25.19
3822 TILDEN AVE.	5852	2378	40.6%	26.69
3832 TILDEN AVE.	5822	1354	23.2%	15.97
3834 TILDEN AVE.	6570	3715	56.5%	27.90
3838-3844 TILDEN AVE.	10960	4316	39.4%	27.38
3848-3852 TILDEN AVE.	7788	2549	32.7%	17.87
3854-3860 TILDEN AVE.	7768	2632	33.8%	18.04
3866 TILDEN AVE.	7791	2269	29.1%	16.37
3866 TILDEN AVE.	5840	2187	37.4%	16.72
3868 TILDEN AVE.	5840	1527	26.1%	13.16
3874 TILDEN AVE.	5858	1972	33.6%	10.66

BLOCK SUBJECT TO TYPOLOGIES

NUMBER OF LOTS ON BLOCK	53
AVERAGE LOT COVERAGE	43.6%
PREVAILING (MOST FREQUENT)	40%
AVERAGE BUILDING HEIGHT	19.76'
PREVAILING (MOST FREQUENT)	17'-23'

NOTE:

ALL BUILDING HEIGHTS CALCULATED FROM ELEVATION OF BACK OF WALK AT MID POINT OF EACH RESPECTIVE LOT FRONTEAGE TO HIGHEST PROJECTED POINT AT ROOF.

LEGEND

AVERAGE PERCENTAGE OF LOT COVERAGE	21 - 40%
	41 - 60%
	61 - 80%

LOT 7, ROBERT JONES WALNUT GROVE TRACT, M.B. 7, PAGE 185.

HARVEY A. GOODMAN
CIVIL ENGINEER
834 17TH STREET
SANTA MONICA, CA 90403
(310)829-1037

TYPOLOGY SURVEY
3906 TILDEN AVENUE
CULVER CITY, CA 90232

LEGAL DESCRIPTION

LOT 7, ROBERT JONES WALNUT GROVE TRACT, M.B. 7, PAGE 185.

DRAWN BY:	A.Y.V.
CHECKED BY:	H. A. GOODMAN
DATE:	MAY 15, 2018
SCALE:	1" = 30'
SHEET NO.	1

PROJECT:
3906 TILDEN
CULVER CITY
(N) 5-UNIT CONDOMINIUM

ARCHITECT:
DU

DesignUniversal
ARCHITECTURE AND DESIGN

ROBERT THIBODEAU
624 VENICE BLVD
VENICE, CA 90291
PH: 310.452.8151
FX: 310.452.8171

OWNER:
1485 PH LLC
380 LENOX AVE, #8J
NEW YORK, NY 10027
PH: 917.566.6477

CONTRACTOR:

SOILS ENGINEER:
HILLSIDE INSPECTIONS, INC.
7622 GODDARD AVE
LOS ANGELES, CA 90045
PH: 424.781.7152
EMAIL: INFO@HILLSIDEINSPECTIONS.COM

SURVEYOR:
M & G CIVIL ENGINEERING & LAND SURVEYING
247 S. ROBERTSON BLVD.
BEVERLY HILLS, CA 90211
PH: 310.659.0871
FX: 310.659.0845

STRUCTURAL ENGINEER:
KMS STRUCTURAL DESIGN ENGINEERING
1377 S BEVERLY GLEN BLVD #308
LOS ANGELES, CA 90024
PH: 310.497.0744
EMAIL: KMSSTRUCTURAL@aol.com


CIVIL ENGINEER:
HARVEY A. GOODMAN CIVIL ENGINEER
834 17TH STREET UNIT 111
SANTA MONICA, CA 90403
PH: 310.829.1037
FX: 310.829.5062

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9. PLANNING DIV. RESUB.	04/13/2020
10. PLANNING DIV. REVIS.	05/22/2020

NEIGHBORHOOD PHOTOS



DATE: 07/16/2020 DRAWN: SBD SCALE: NTS

A-0.5

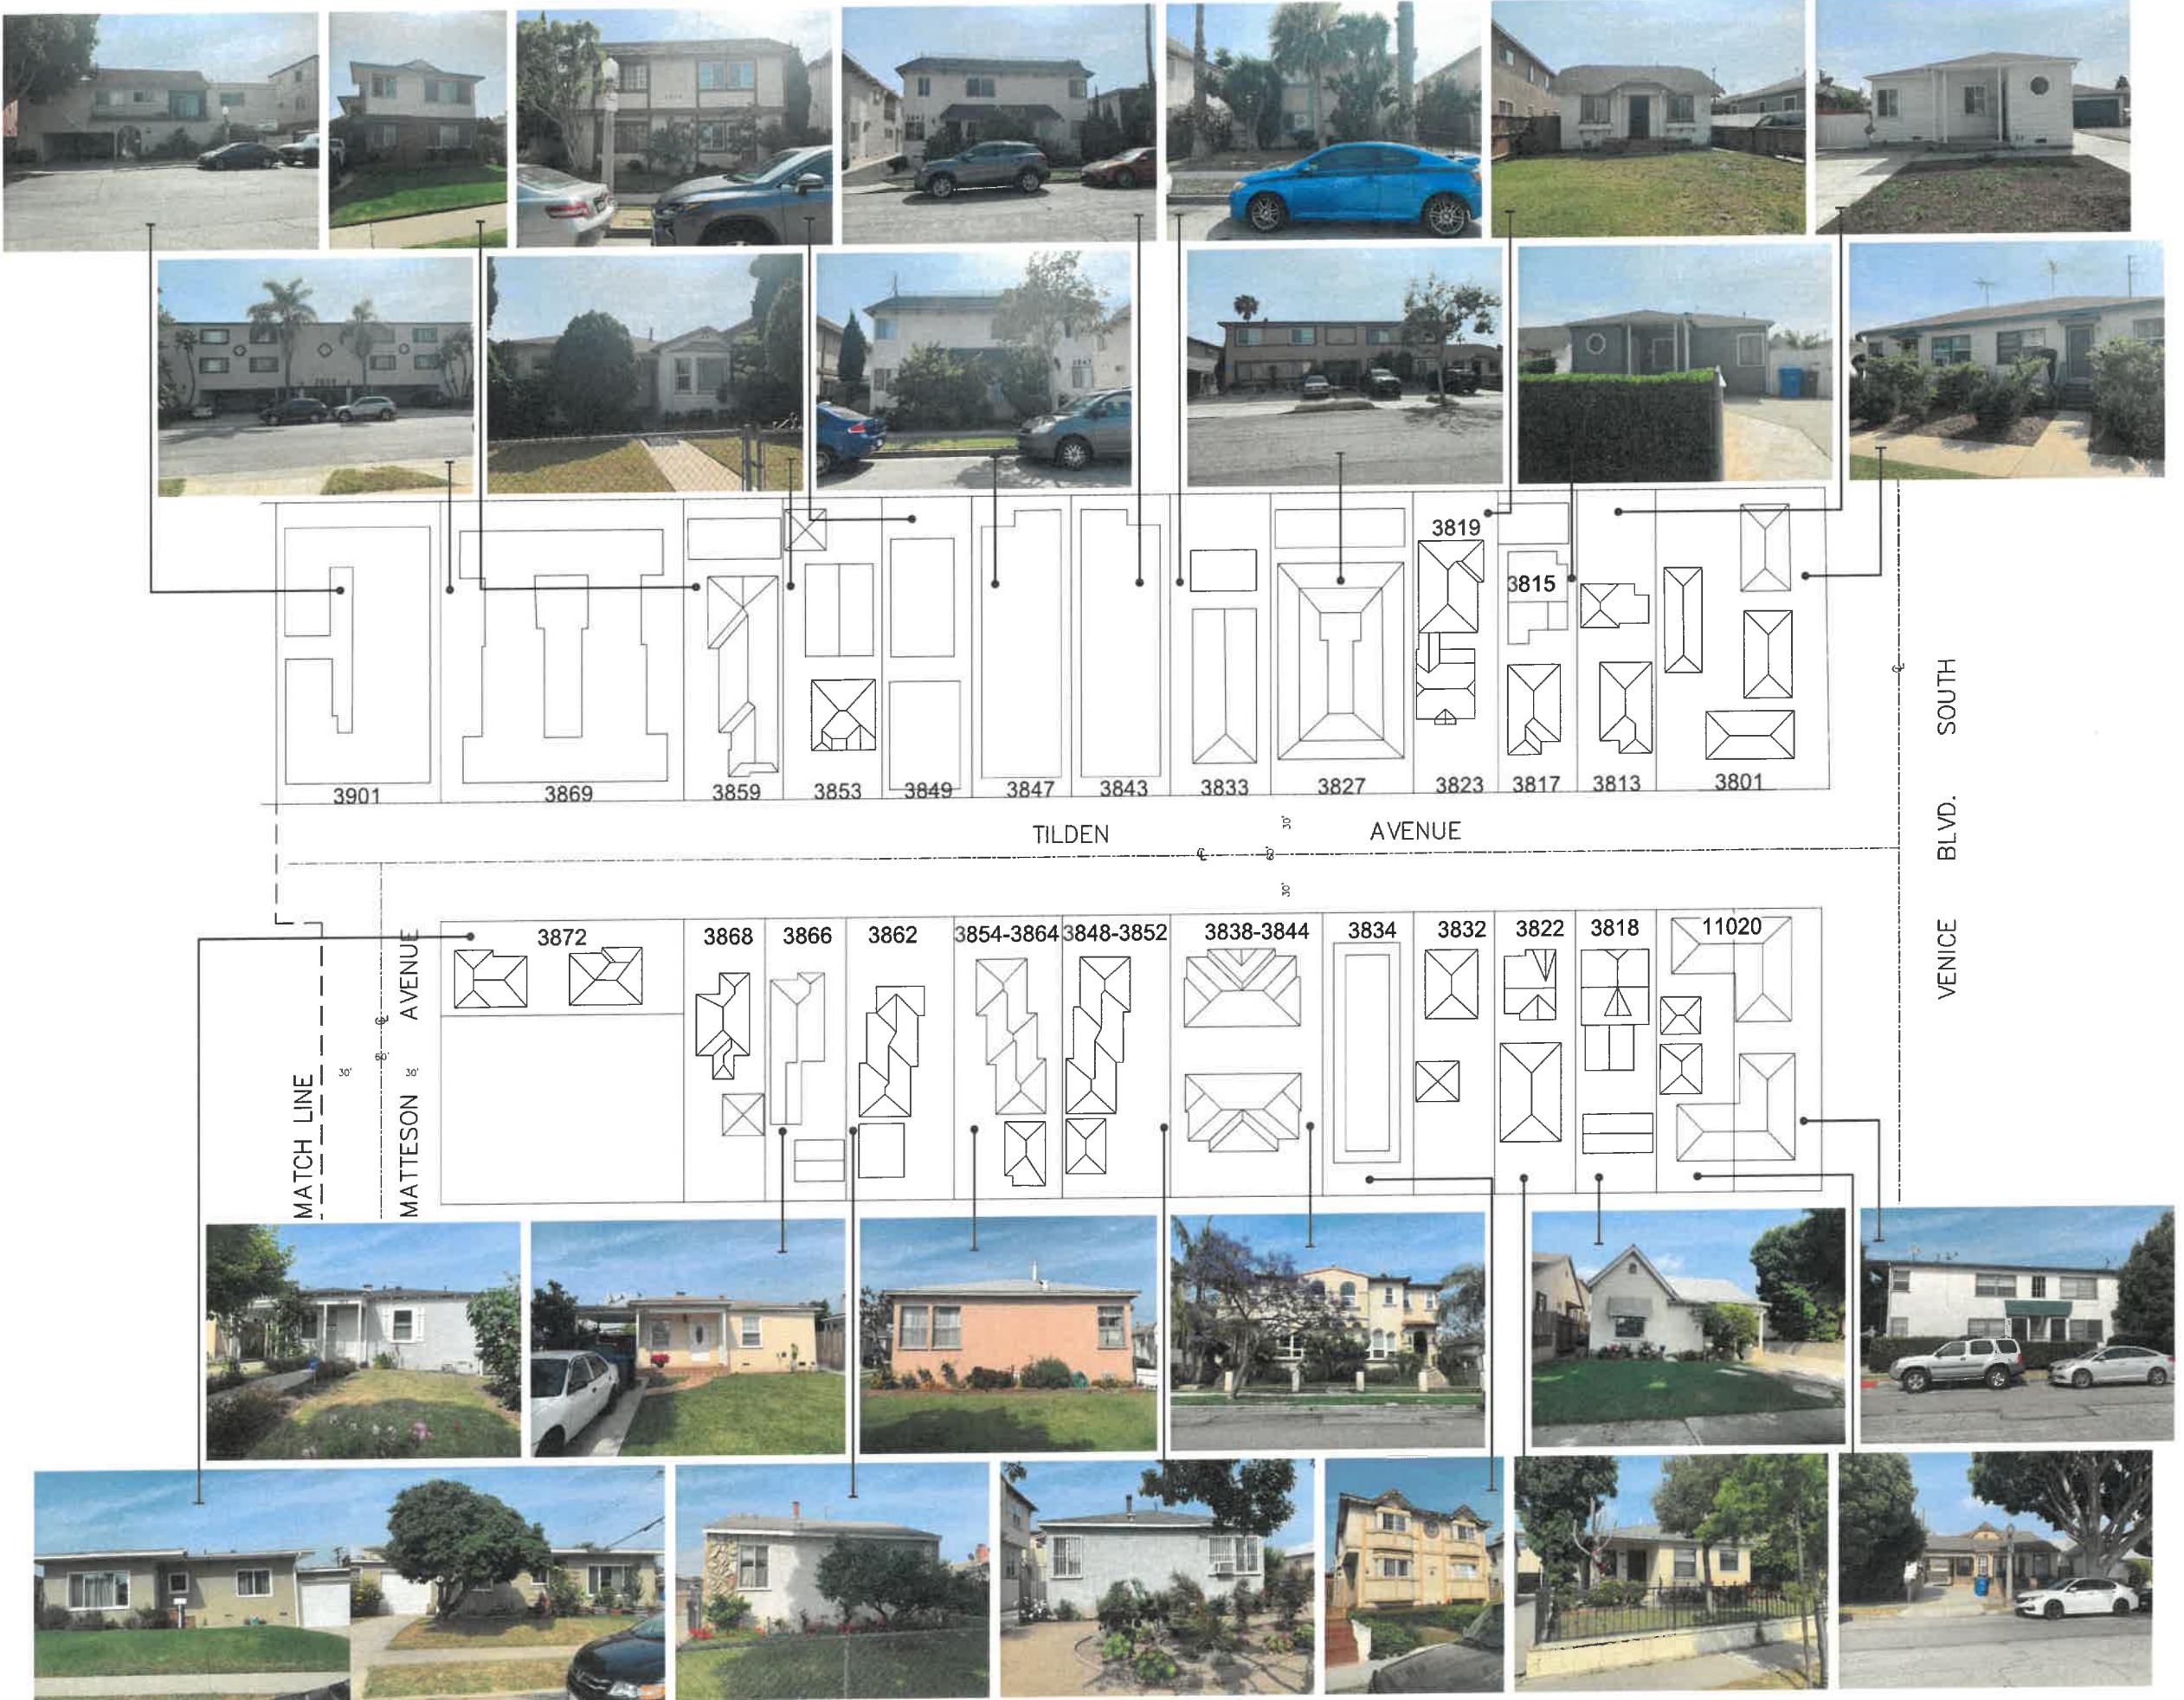



SCALE 1"=30'

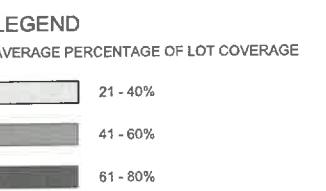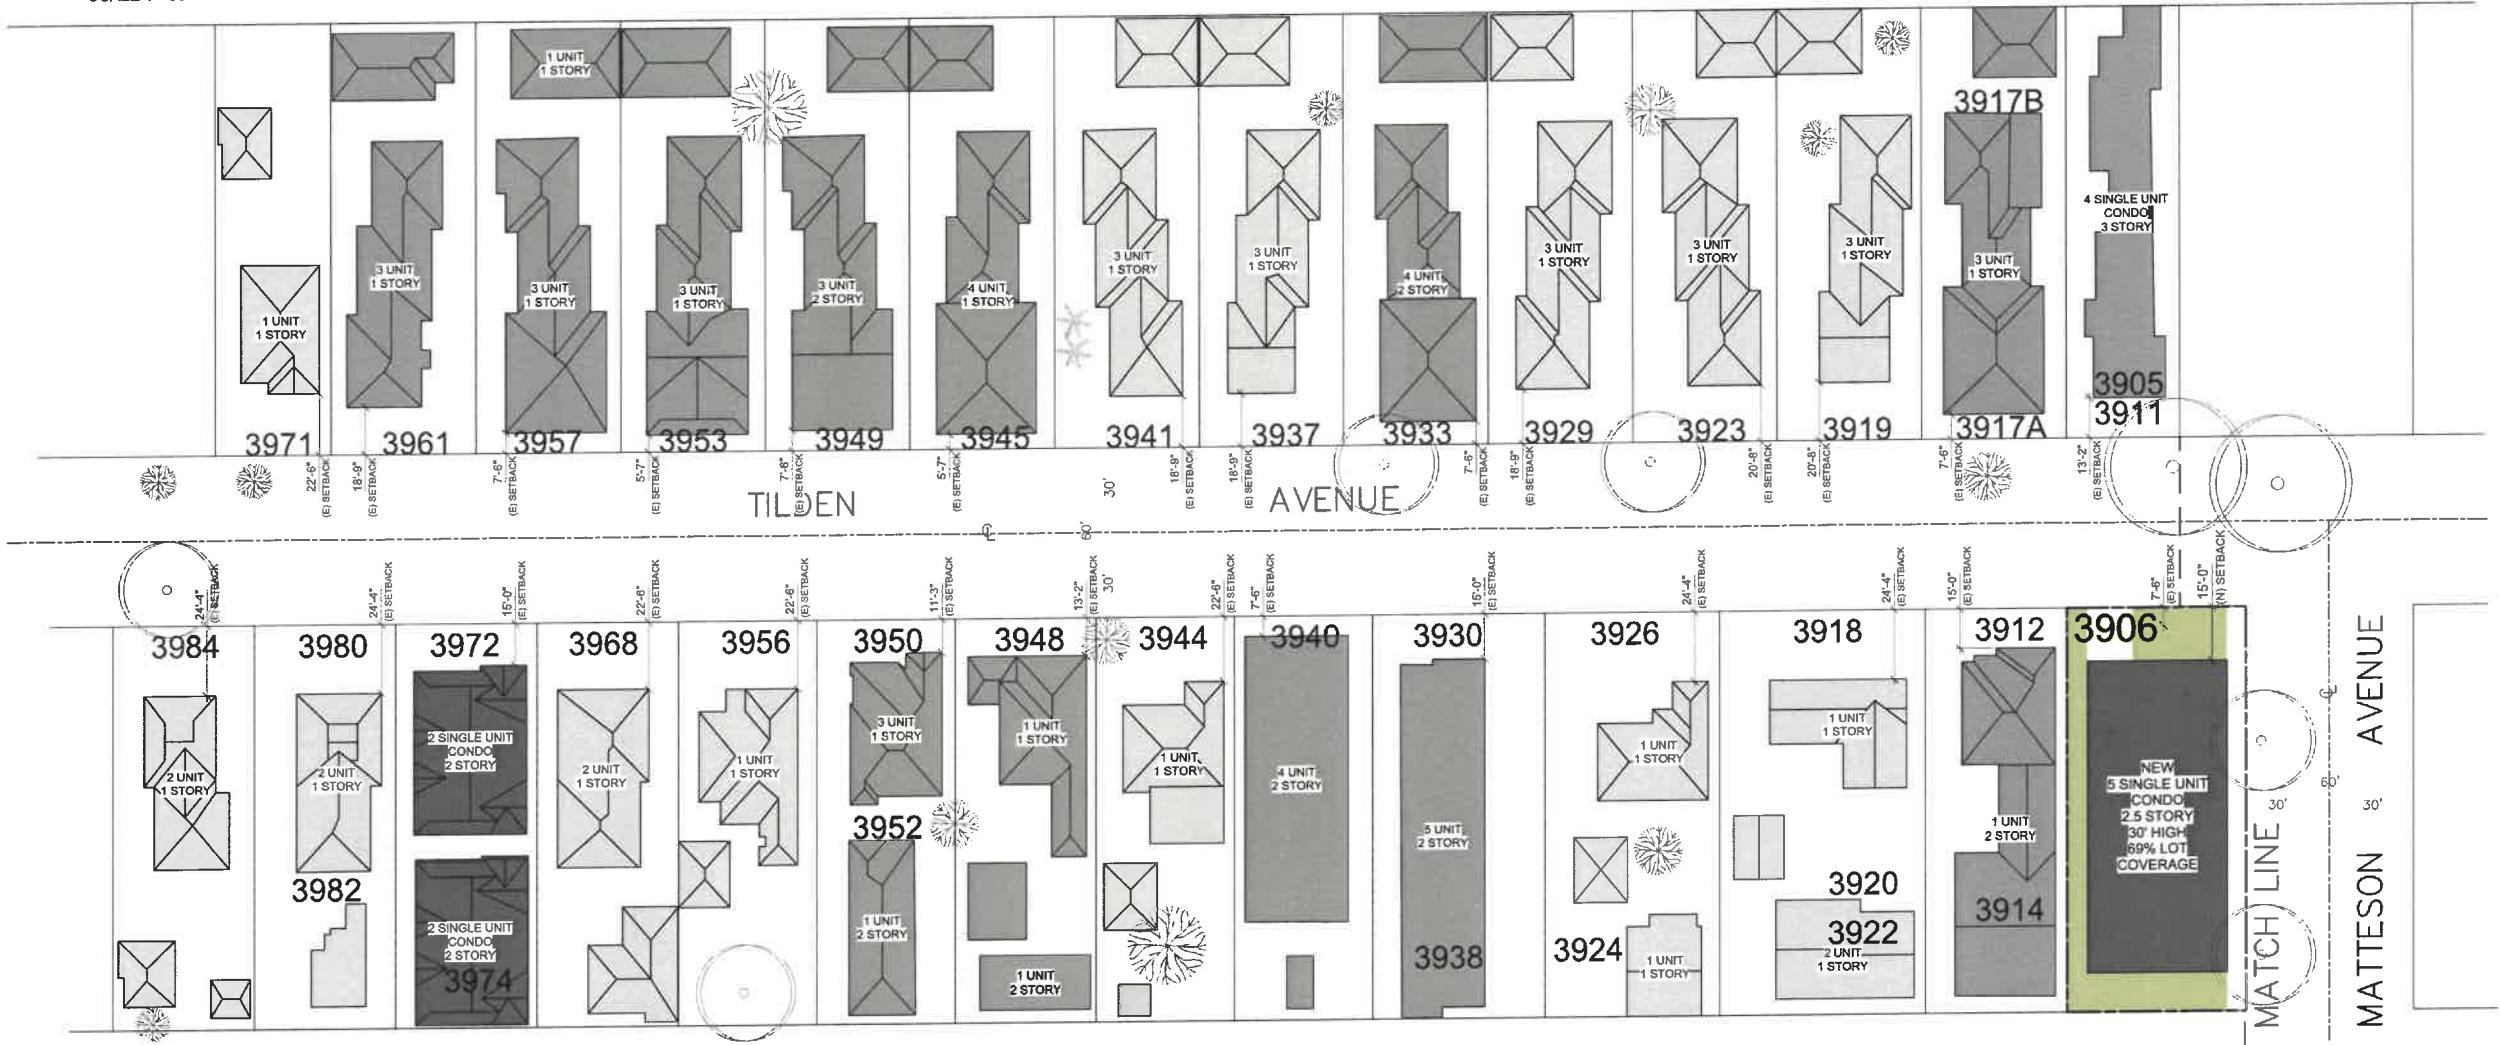

LEGAL DESCRIPTION:
LOT 7, ROBERT JONES WALNUT
GROVE TRACT, M.B., PAGE 185.

DRAWN BY:
AYV

CHECKED BY:
H. A. GOODMAN

DATE:
MAY 15, 2018

SCALE:
1" = 30'

SHEET NO.
2

HARVEY A. GOODMAN
CIVIL ENGINEER
834 17TH STREET
SANTA MONICA, CA. 90403
TEL: (310)829-1037

PROJECT:
3906 TILDEN
CULVER CITY
(N) 5-UNIT CONDOMINIUM

ARCHITECT:
DU

DesignUniversal
ARCHITECTURE AND DESIGN
ROBERT THIBODEAU
624 VENICE BLVD
VENICE, CA 90291
PH: 310.452.8161
FX: 310.452.8171

OWNER:
1485 PH LLC
380 LENOX AVE, #6J
NEW YORK, NY 10027
PH: 917.566.6477

CONTRACTOR:

SOILS ENGINEER:
HILLSIDE INSPECTIONS, INC.
7622 GODDARD AVE.
LOS ANGELES, CA 90045
PH: 424.781.7152
EMAIL: INFO@HILLSIDEINSPECTIONS.COM

SURVEYOR:
M & G CIVIL ENGINEERING & LAND SURVEYING
347 S. RUTHERFORD AVE.
BEVERLY HILLS, CA 90211
PH: 310.659.0971
FX: 310.659.0845

STRUCTURAL ENGINEER:
KMS STRUCTURAL DESIGN ENGINEERING
1077 S BEVERLY GLEN BLVD #308
LOS ANGELES, CA 90024
PH: 310.497.0744
EMAIL: KMSSTRUCTURAL@aol.com

CIVIL ENGINEER:
HARVEY A. GOODMAN CIVIL ENGINEER
834 17TH STREET UNIT 5
SANTA MONICA, CA 90403
PH: 310.829.1037
FX: 310.828.6062

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7. PLANNING DIVISION RESUB	10/01/2019
8. PLANNING DIVISION REVIS.	11/06/2019
9. PLANNING DIV. CONDITIONS	04/13/2020
10. PLANNING DIV. REVIS.	06/23/2020

NEIGHBORHOOD PHOTOS

DATE: 07/16/2020 DRAWN: SBD SCALE: NTS

A-0.6



TENTATIVE TRACT MAP NO. 82562

IN THE CITY OF CULVER CITY
COUNTY OF LOS ANGELES
STATE OF CALIFORNIA

SCALE 1"=20'

PROPOSED PROJECT:

5 UNIT CONDOMINIUM DEVELOPMENT
SUBTERRANEAN GARAGE WITH
2 SPACES PER UNIT & 1 GUEST SPACE
11 TOTAL PARKING SPACES

NOTES:

PROJECT ADDRESS:
3909 TILDEN AVE.
CULVER CITY, CA 90232

ASSESSOR PARCEL NUMBER:
4213-003-019

EXISTING ZONE:
RMD

EXISTING USE:
3 RESIDENTIAL BUILDINGS WITH
1 UNIT PER BUILDING

EXISTING STREET TREES TO REMAIN.

ALL ON-SITE TREES INTERFERING WITH
CONSTRUCTION TO BE REMOVED.

THE ENTIRE SITE SHALL DRAIN TO
TILDEN AVENUE WITHOUT FLOWING
OVER THE SIDEWALK, TO THE SATISFACTION
OF THE CITY ENGINEER.

SANITARY SEWER AND ALL UTILITIES ARE
EXISTING AND AVAILABLE.

OWNER/SUBDIVIDER SHALL COMPLY
WITH ALL REQUIREMENTS FROM THE
CITY OF CULVER CITY DEPARTMENT
OF ENVIRONMENTAL AND PUBLIC
WORKS MANAGEMENT.


NO RESIZING OF EXISTING PUBLIC UTILITIES
PROPOSED

FEMA FLOOD ZONE "X" - 12/21/18
AREA OF MINIMAL FLOOD HAZARD

ELEVATIONS SHOWN ARE BASED ON A
TOPOGRAPHIC SURVEY PERFORMED
BY: M&G CIVIL ENGINEERING AND LAND SURVEYING
CYNTHIA A. DELEON RCE C-31604

EXISTING UTILITIES EASEMENT PER DEED REC. IN
BOOK 5182, PAGE 225, RECORDS OF LOS ANGELES
COUNTY. EASEMENT IS NOT LOCATABLE.

FOR CONDOMINIUM PURPOSES

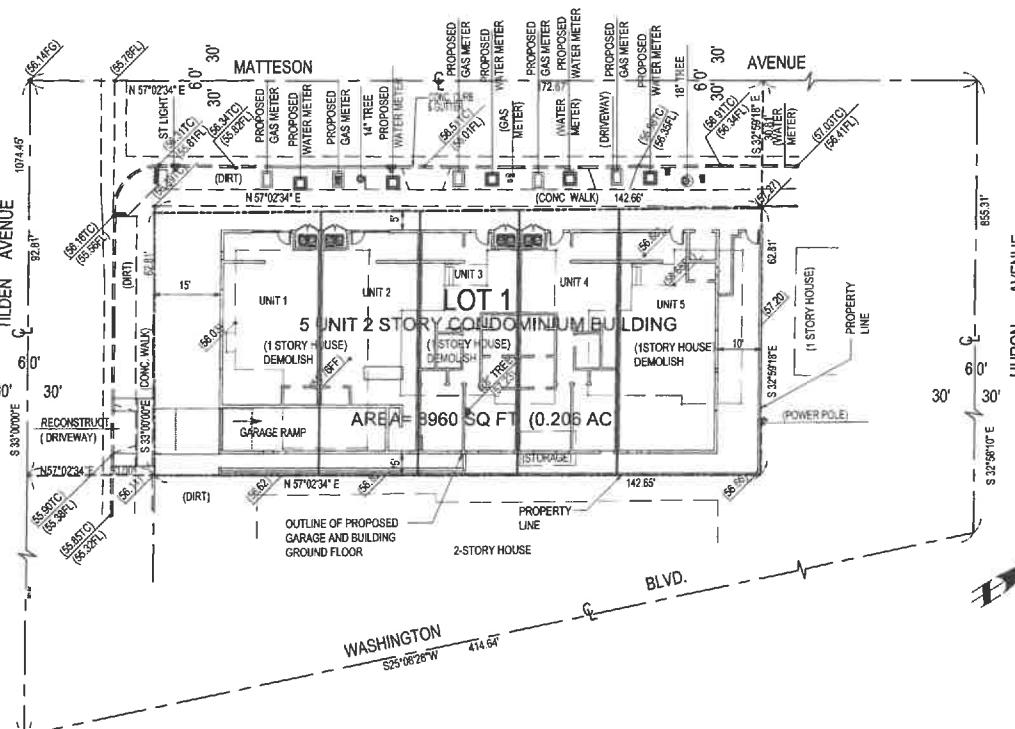

MAP MODIFIED MARCH 14, 2020
MAP MODIFIED APRIL 30, 2019
MAP PREPARED JANUARY 26, 2019

MAP PREPARED BY:
DIRECT ALL CORRESPONDENCE TO:

HARVEY A. GOODMAN CIVIL ENGINEER
834 17TH STREET UNIT 5
SANTA MONICA, CA 90403
PHONE: (310) 828-1037
FAX: (310) 828-5062



[Handwritten signature]

THIS MAP WAS PREPARED BY ME,
OR UNDER MY DIRECT SUPERVISION,
AND SHOW ALL EASEMENTS OF RECORD
AS REPORTED IN THE TITLE REPORT
PREPARED BY FIDELITY NATIONAL TITLE
COMPANY DATED MARCH 19, 2018.

OWNER/SUBDIVIDER:

1485 PH LLC, A NEW YORK
LIMITED LIABILITY COMPANY
380 LENOX AVENUE 6J
NEW YORK, NY 10027


ATTN: MR. LEWIS FUTTERMAN
(917) 566-6477
LEWFUTT@AOL.COM

GEOTECHNICAL ENGINEER:

HILLSIDE INSPECTIONS, INC.
7622 GODDARD AVE.
LOS ANGELES, CA 90045
(424) 781-7152

BENCHMARK:

BM ID 125 (NAVD 1988)
S & W AT INTERSECTION OF MATTESON AVE
AND PROSPECT AVE
ELEV. 61.06 PER RSB 164/42-45

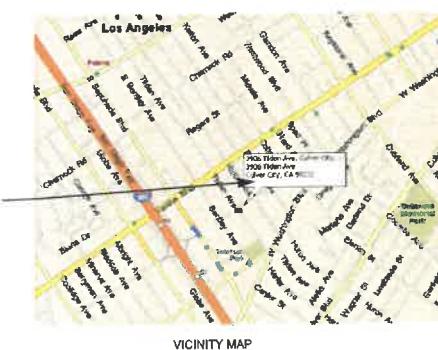

VICINITY MAP
NOT TO SCALE

TENTATIVE TRACT MAP NO. 82562

IN THE CITY OF CULVER CITY
COUNTY OF LOS ANGELES
STATE OF CALIFORNIA

SCALE 1"=20'




MAP PREPARED BY:

DIRECT ALL CORRESPONDENCE TO:
HARVEY A. GOODMAN CIVIL ENGINEER
834 17TH STREET UNIT 5
SANTA MONICA, CA 90403
PHONE: (310) 829-1037
FAX: (310) 828-5062



Bob Jordan

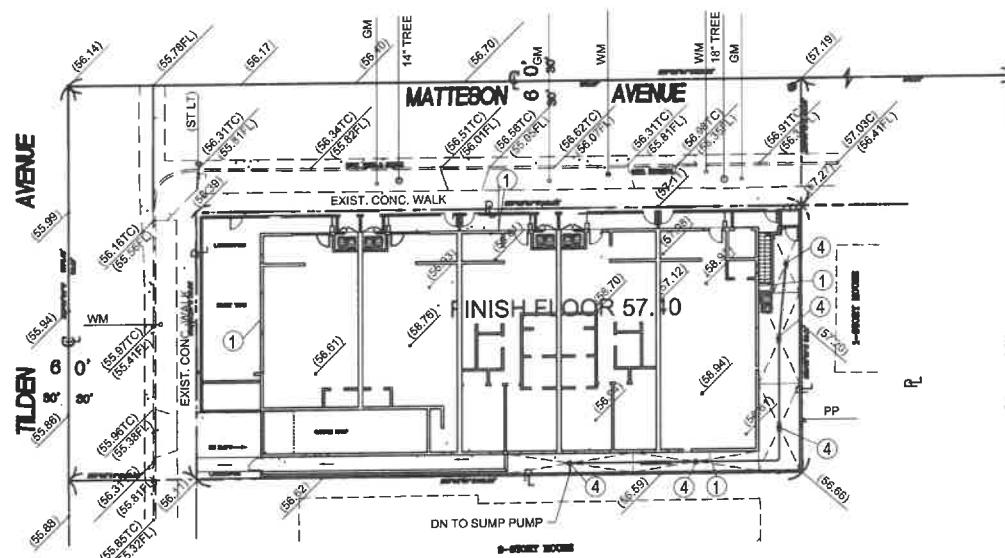

- ① OUTLINE OF PROPOSED STRUCTURE
 - ② GARAGE OUTLINE
 - ③ TRENCH DRAIN
 - ④ YARD OR AREA DRAIN
 - ⑤ SUMP PUMP AND PIT

P PROPERTY LINE

CONCEPTUAL GRADING PLAN


MAP REVISED MARCH 13, 2020
MAP PREPARED FEBRUARY 20, 2019

SHEET
1
OF 2 SHEETS

TENTATIVE TRACT MAP NO. 82562

IN THE CITY OF CULVER CITY
COUNTY OF LOS ANGELES
STATE OF CALIFORNIA

SCALE 1"=20'

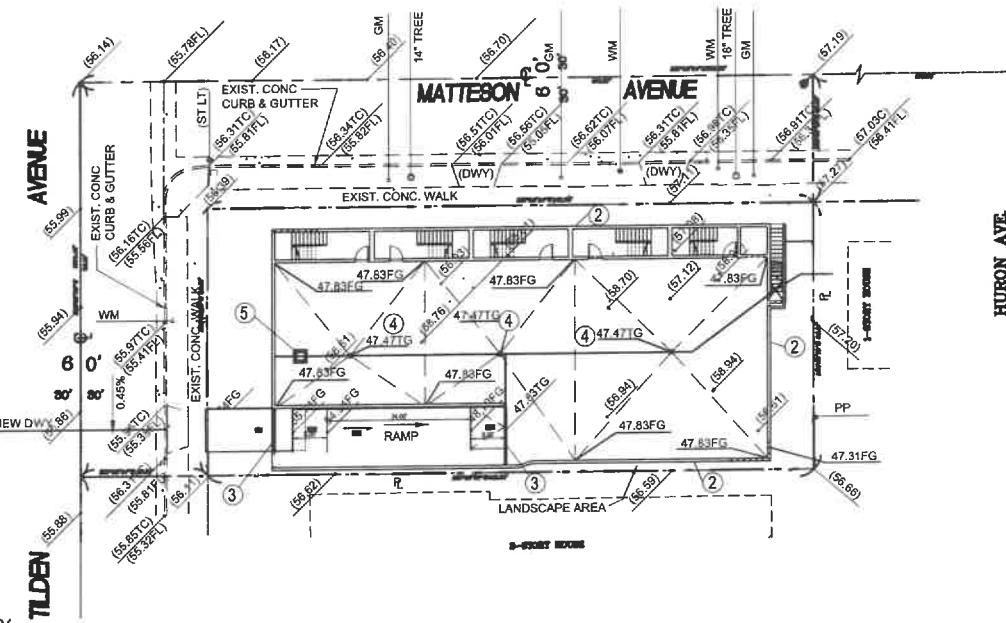

EARTHWORK SUMMARY

EXCAVATION 1900 CU. YD.
EMBANKMENT 0 CU. YD.

- ① OUTLINE OF PROPOSED STRUCTURE
- ② GARAGE OUTLINE
- ③ TRENCH DRAIN
- ④ YARD OR AREA DRAIN
- ⑤ SUMP PUMP AND PIT
- P PROPERTY LINE

CONCEPTUAL GARAGE GRADING PLAN

MAP REVISED MARCH 13, 2020
MAP PREPARED FEBRUARY 20, 2019

MAP PREPARED BY:
DIRECT ALL CORRESPONDENCE TO:
HARVEY A. GOODMAN CIVIL ENGINEER
834 17TH STREET UNIT 5
SANTA MONICA, CA 90403
PHONE: (310) 829-1037
FAX: (310) 829-5062



HARVEY A. GOODMAN
No.15900
Exp. 6-30-2021
CIVIL
ENGINEER

[Handwritten signature over seal]


SHEET
2
OF 2 SHEETS

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8. PLANNING DIVISION RESUB.	04/13/2020
9. PLANNING DIV. CONDITIONS	05/31/2020
10. PLANNING DIV. REVIS.	07/16/2020

BASEMENT PLAN

DATE: 07/16/2020 DRAWN: SBD SCALE: 1/8" = 1'-0"

A-1.0

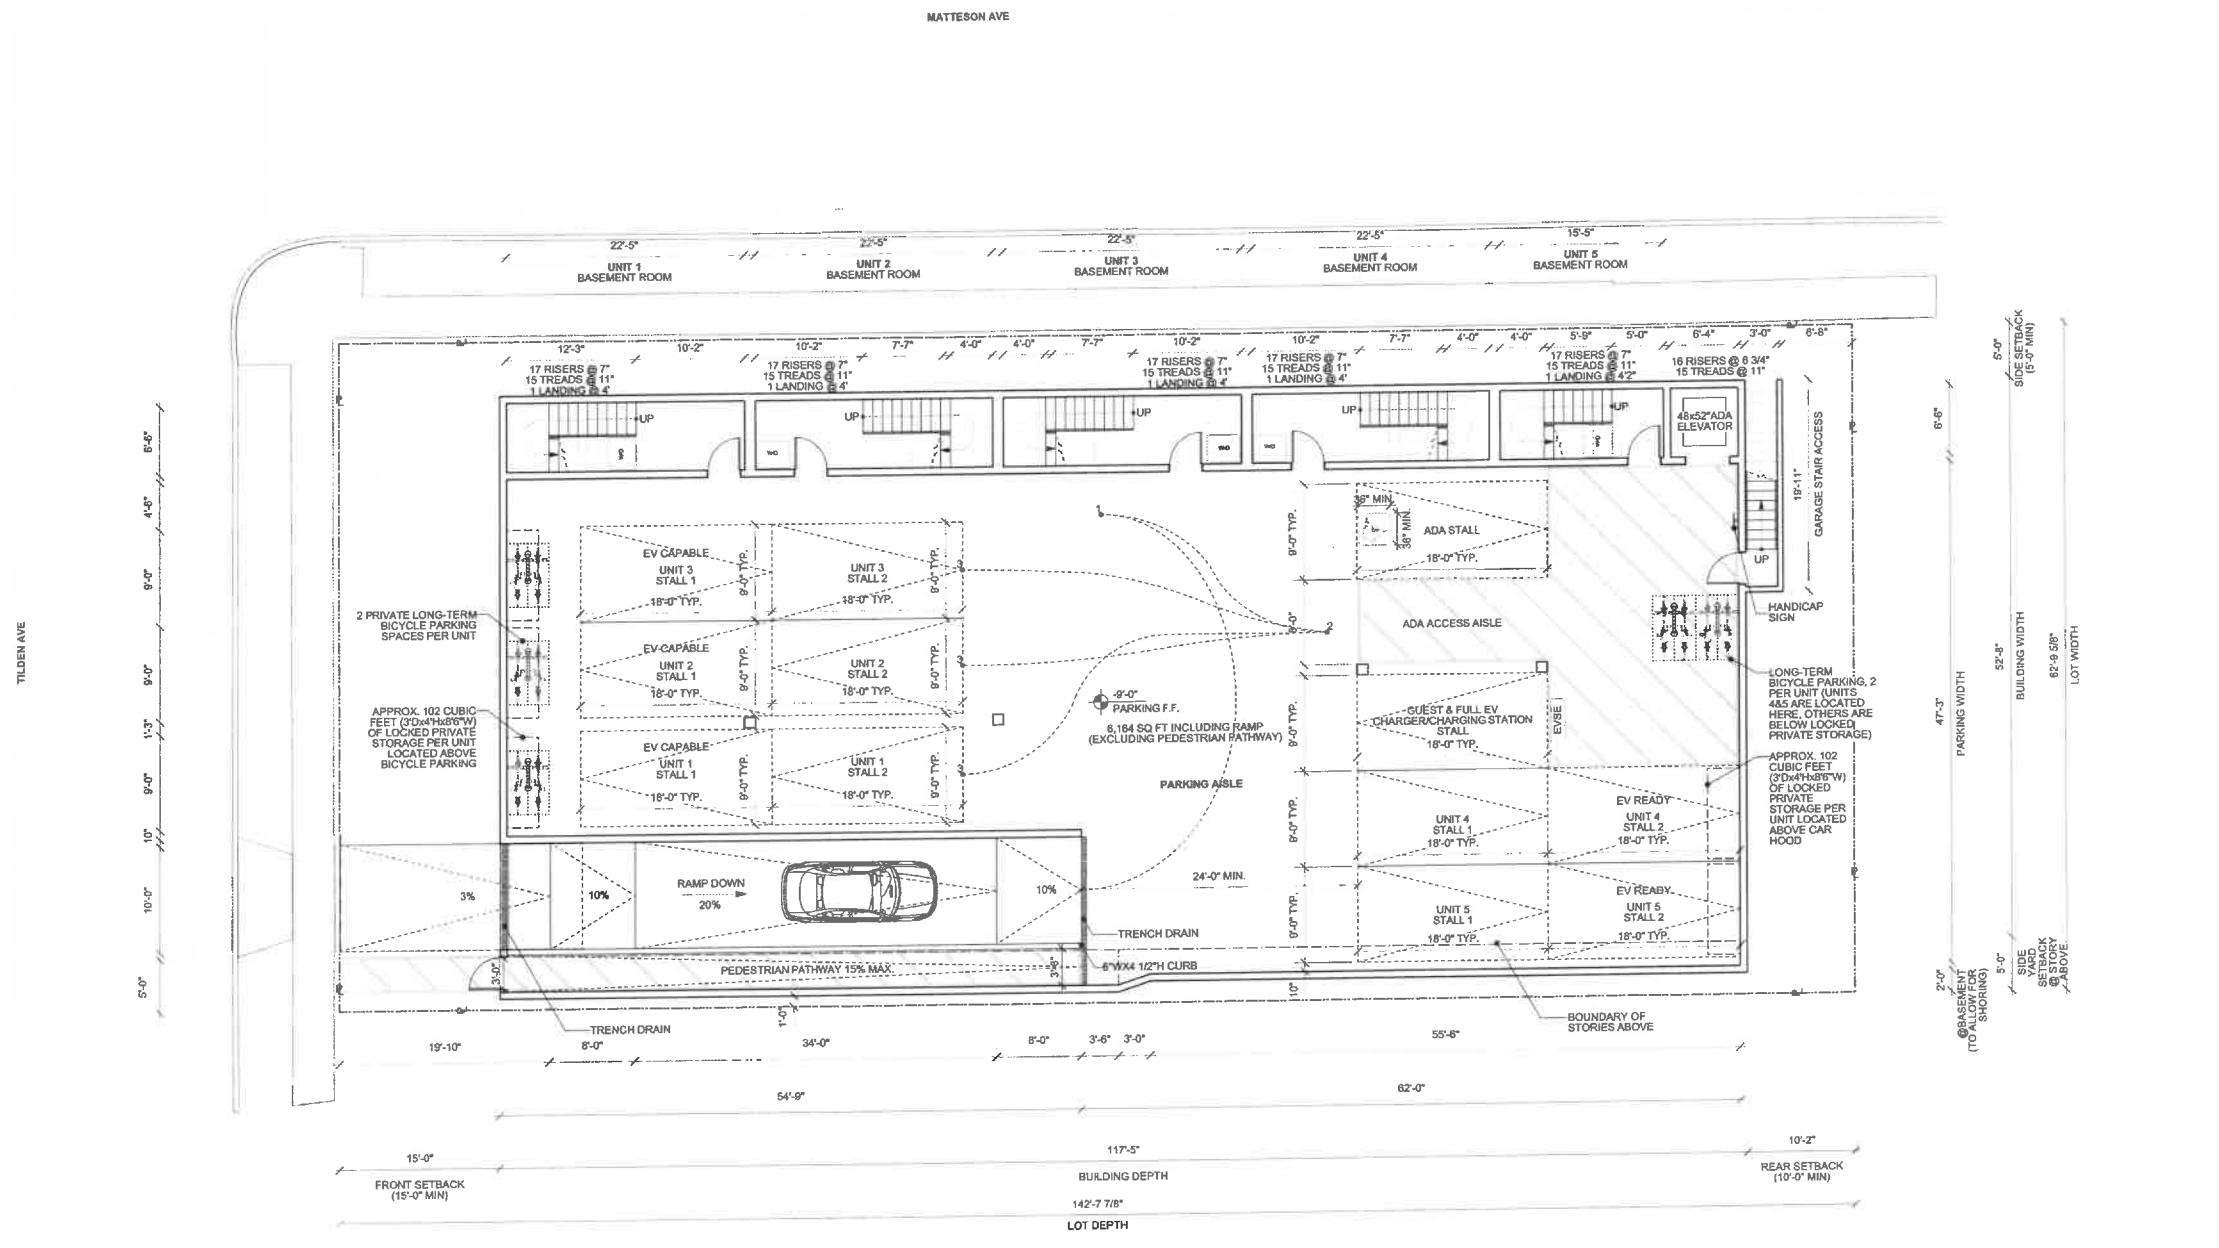

NOTES:
RESIDENTIAL PARKING SHALL BE CONSTRUCTED WITH THE INFRASTRUCTURE NECESSARY TO ALLOW FOR FUTURE INSTALLATION OF ELECTRONIC VEHICLE (EV) CHARGING STATION SHOULD RESIDENTS IN THE FUTURE REQUEST OR NEED EV CHARGING STATIONS AT THEIR PARKING STALLS.
EACH UNIT SHALL HAVE ITS OWN GARAGE SECURITY DOOR, AS APPLICABLE; SEISMIC GAS SHUT OFF VALVE; AND GAS, WATER, AND ELECTRIC METER.
SPACES WILL BE DOUBLED STRIPED.

BASEMENT PARKING PLAN: RAMP OPTION
Scale: 1/8" = 1'-0"




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9. PLANNING DIV. CONDITIONS	06/23/2020
10. PLANNING DIV. REVIS.	07/16/2020

FIRST FLOOR PLAN

DATE: 07/16/2020 DRAWN: SBD SCALE: 1/8" = 1'-0"

A-1.1

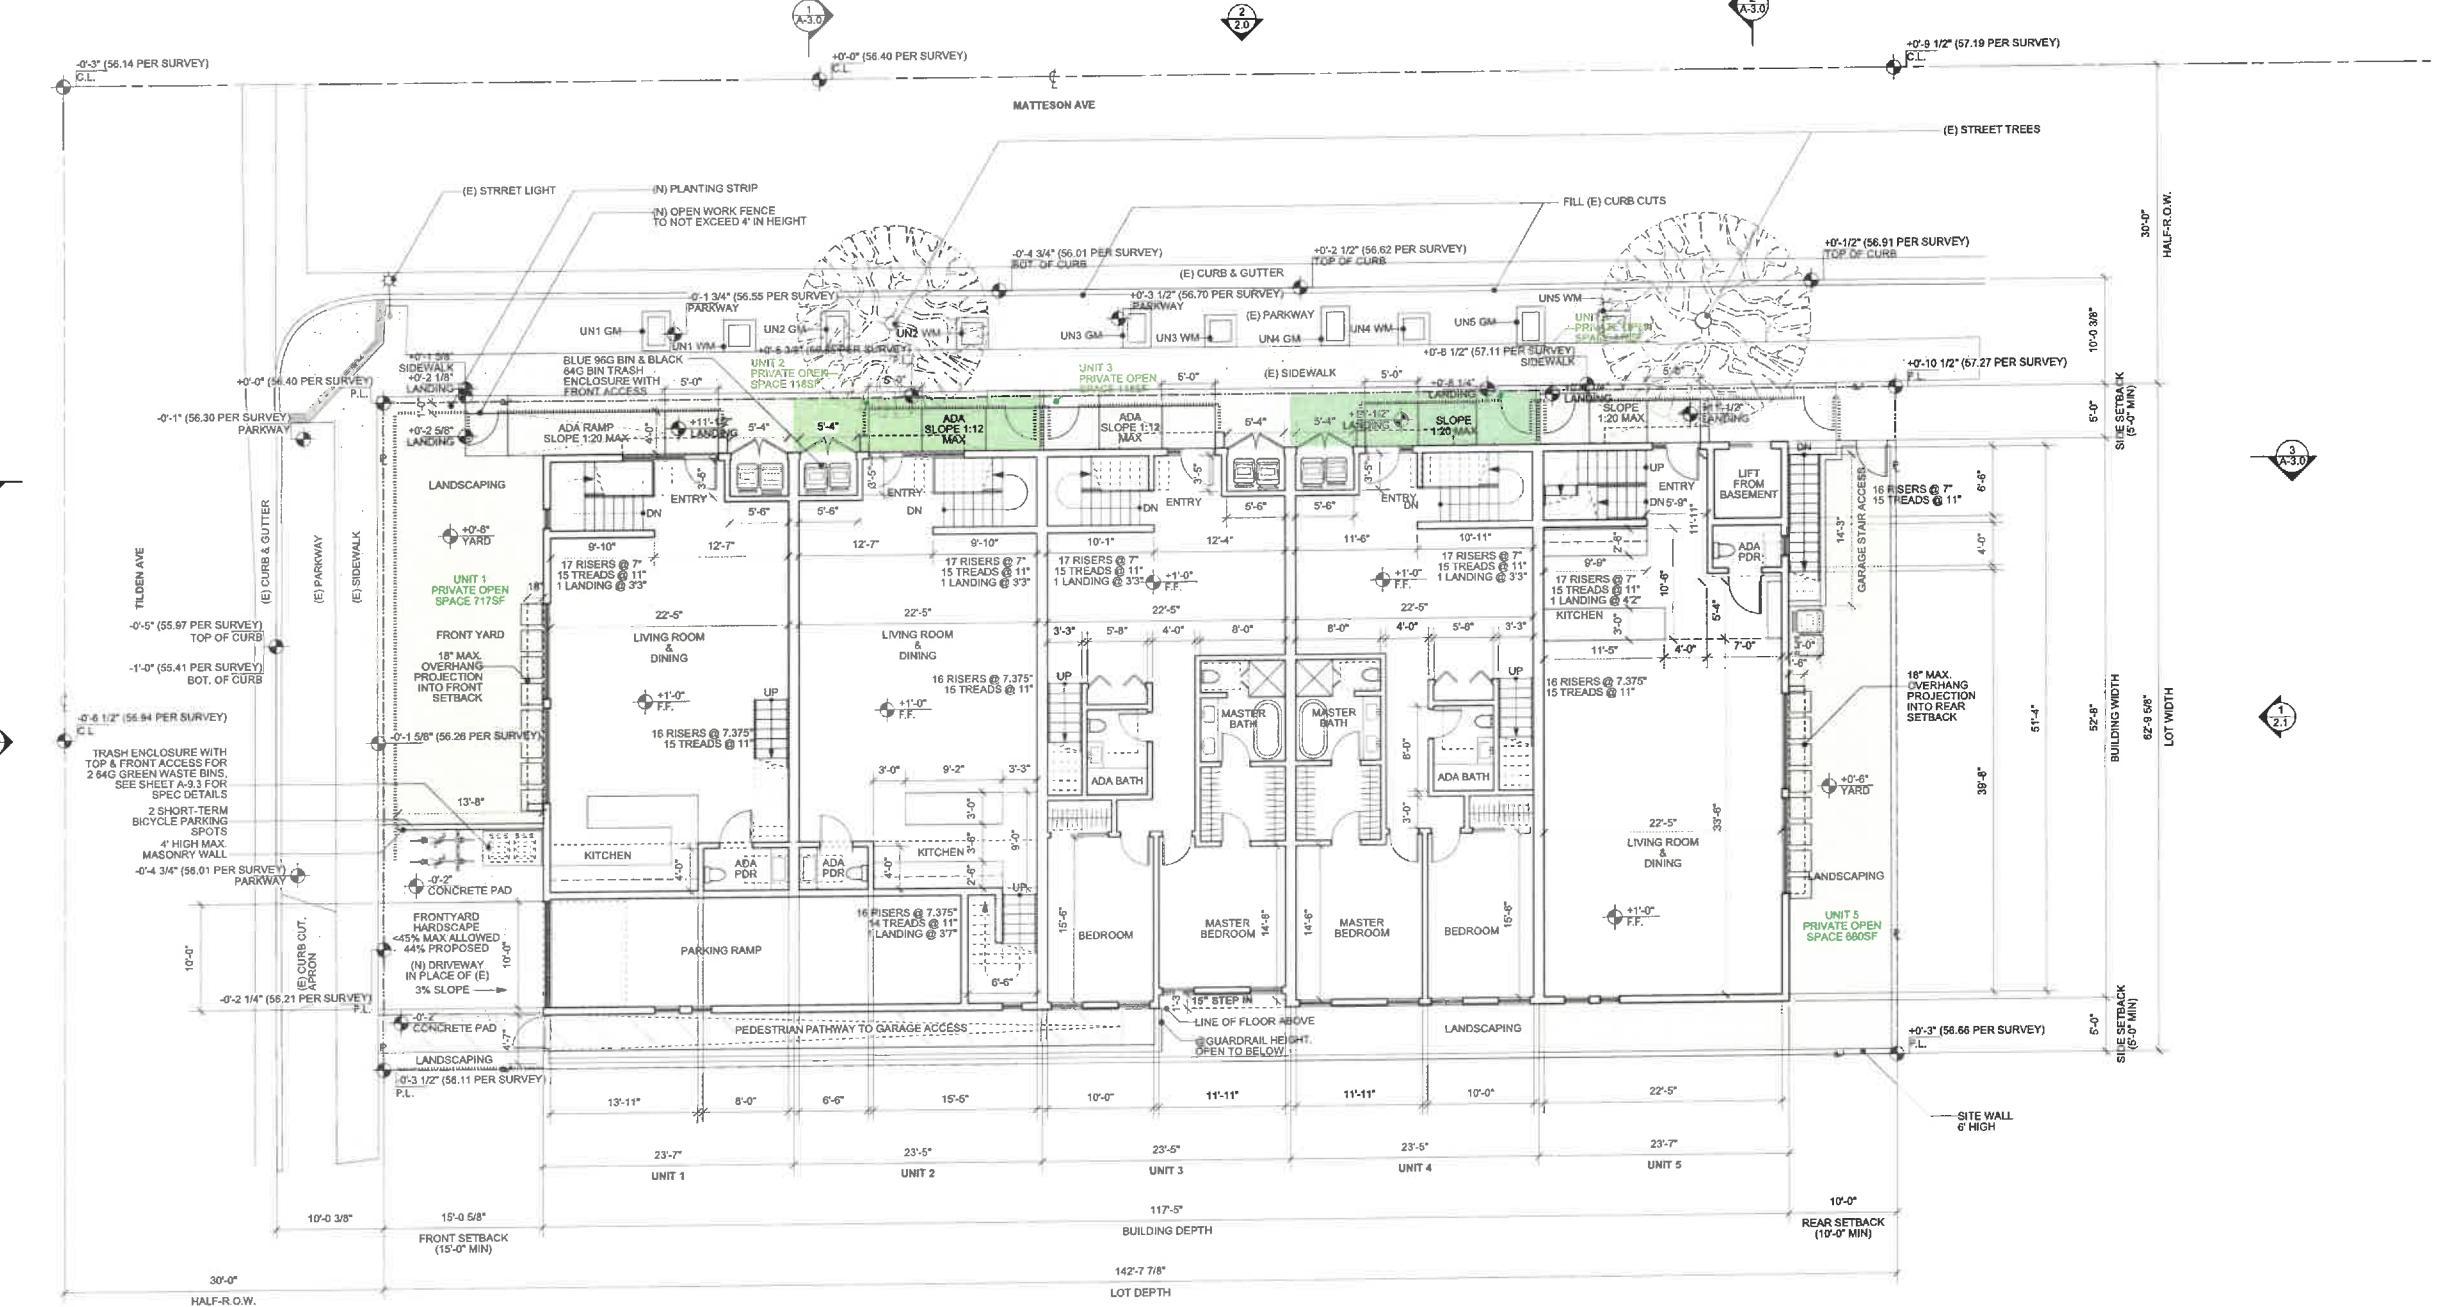

CONCEPTUAL SITE PLAN / GROUND FLOOR PLAN
Scale: 1/8" = 1'-0" 1



NOTES

ENVIRONMENTAL PROGRAMS AND OPERATIONS NOTES

1) SOLID WASTE, RECYCLABLE WASTE MATERIAL, AND ORGANIC WASTE HANDLING SHALL BE PERFORMED EXCLUSIVELY BY THE CITY OR ITS AUTHORIZED AGENTS. THE CITY COUNCIL MAY REGULATE, BY ORDINANCE OR RESOLUTION, ALL ASPECTS OF SOLID WASTE, RECYCLABLE WASTE MATERIAL, AND ORGANIC WASTE HANDLING, INCLUDING BUT NOT LIMITED TO, FREQUENCY OF COLLECTION, MEANS OF COLLECTION AND TRANSPORTATION, LEVEL OF SERVICES, CHARGES, FEES, AND NATURE, LOCATION AND EXTENT OF PROVIDING SOLID WASTE HANDLING SERVICES.

2) THE CITY OF CULVER CITY SHALL PROVIDE WASTE DISPOSAL AND RECYCLING SERVICES FOR ALL CONSTRUCTION AND DEMOLITION PROJECTS WITHIN CITY LIMITS IN ACCORDANCE WITH CULVER CITY MUNICIPAL CODE 5.01.010.

3) AUTOMATED ORGANIC WASTE CARTS ARE THE RESPONSIBILITY OF THE TENANT(S) OR HOMEOWNER(S) TO ROLL OUT TO THE STREET DURING DESIGNATED TRASH COLLECTION DAY.

ALL EXISTING DRIVEWAY APPROACHES WHICH WILL NO LONGER BE NECESSARY DUE TO THIS PROJECT SHALL BE REMOVED AND REPLACED WITH FULL HEIGHT SIDEWALK, PARKWAY, AND CURB AND GUTTER.
IN COMPLIANCE WITH 17.320.035.C.1.b.; TANDEM PARKING SPACES WILL ONLY BE ASSIGNED TO A SINGLE UNIT

REVISION / ISSUE:	DATE:
1. PPR SUBMITTAL	5/15/2016
2. DESIGN UPDATE	01/11/2019
3. PLANNING DIVISION SUB.	02/20/2019
4. PLANNING DIVISION REVIS.	03/20/2019
5. DESIGN UPDATE	04/10/2019
6. DESIGN UPDATE	07/16/2019
7. PLANNING DIVISION RESUB.	10/01/2019
8. PLANNING DIVISION REVIS.	11/08/2019
9. PLANNING DIV. CONDITIONS	06/23/2020
10. PLANNING DIV. REVIS.	07/16/2020

MEZZANINE FLOOR PLAN



DATE: 07/16/2020 DRAWN: SBD SCALE: 1/8" = 1'-0"


MEZZANINE FLOOR PLAN
Scale: 1/8" = 1'-0" 1

NOTES
PER CODE SECTION 505.2.3.1 OPENNESS, EXCEPTION: MEZZANINES OR PORTIONS THEREOF ARE NOT REQUIRED TO BE OPEN TO THE ROOM IN WHICH THE MEZZANINES ARE LOCATED, PROVIDED THAT THE OCCUPANT LOAD OF THE AGGREGATE AREA OF THE ENCLOSED SPACE IS NOT GREATER THAN 10 RESIDENTIAL OCCUPANT LOAD PER TABLE 1004.1.C:
200 SQUARE FEET/OCCUPANT
10 OCCUPANTS-> 2000 SF.

A-1.2

REVISION / ISSUE:	DATE:
1. PPR SUBMITTAL	5/15/2016
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6. DESIGN UPDATE	07/16/2019
7. PLANNING DIVISION RESUB.	10/01/2019
8. PLANNING DIVISION REVIS.	11/08/2019
8. PLANNING DIVISION RESUB.	04/13/2020
9. PLANNING DIV. CONDITIONS	05/23/2020
10. PLANNING DIV. REVIS.	07/16/2020

SECOND FLOOR PLAN

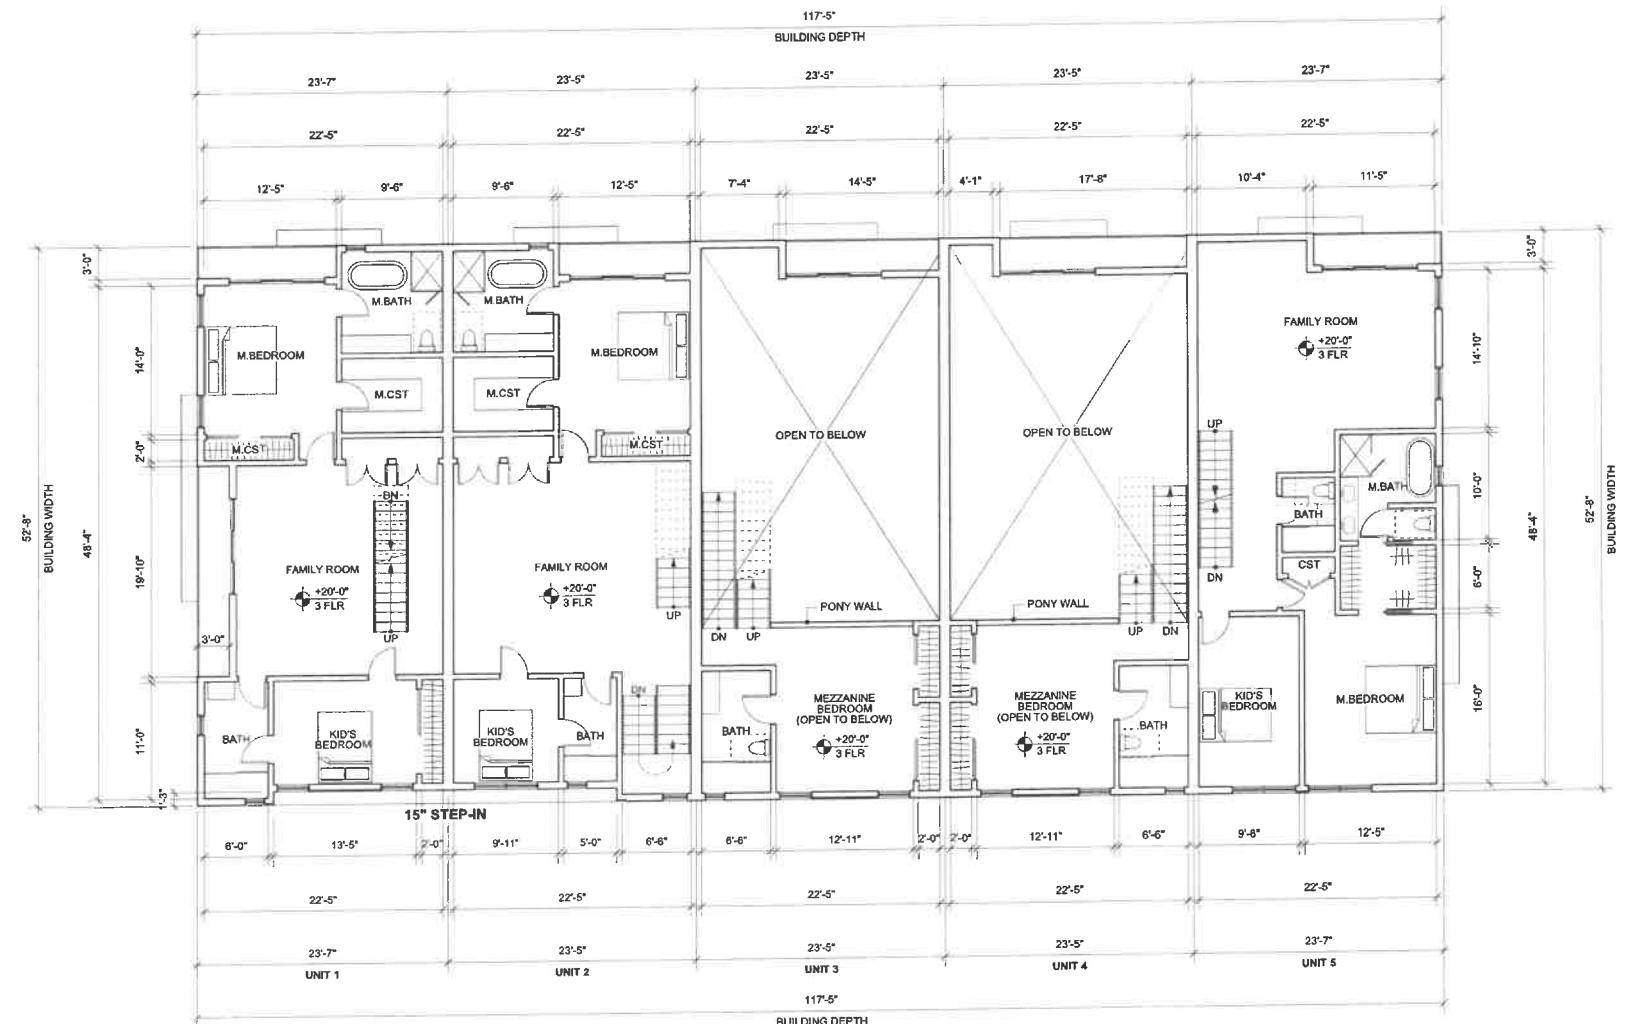

SECOND FLOOR PLAN
Scale: 1/8" = 1'-0"


DATE: 07/16/2020 DRAWN: SBD SCALE: 1/8" = 1'-0"

A-1.3

NOTES
505.2.3.1 MEZZANINES OR PORTIONS THEREOF ARE NOT REQUIRED TO BE OPEN TO THE ROOM IN WHICH THE MEZZANINES ARE LOCATED, PROVIDED THAT THE OCCUPANT LOAD OF THE AGGREGATE AREA OF THE ENCLOSED SPACE IS NOT GREATER THAN 10 RESIDENTIAL OCCUPANT LOAD PER TABLE 1004.1.2:
200 SQUARE FEET/OCCUPANT
10 OCCUPANTS-> 2000 SF.

REVISION / ISSUE:	DATE:
1. PPR SUBMITTAL	5/15/2018
2. DESIGN UPDATE	01/11/2018
3. PLANNING DIVISION SUB.	02/20/2019
4. PLANNING DIVISION REVIS.	03/20/2019
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6. DESIGN UPDATE	07/16/2019
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8. PLANNING DIVISION RESUB.	11/08/2019
9. PLANNING DIV. CONDITIONS	04/13/2020
10. PLANNING DIV. REVIS.	07/16/2020

ROOF PLAN

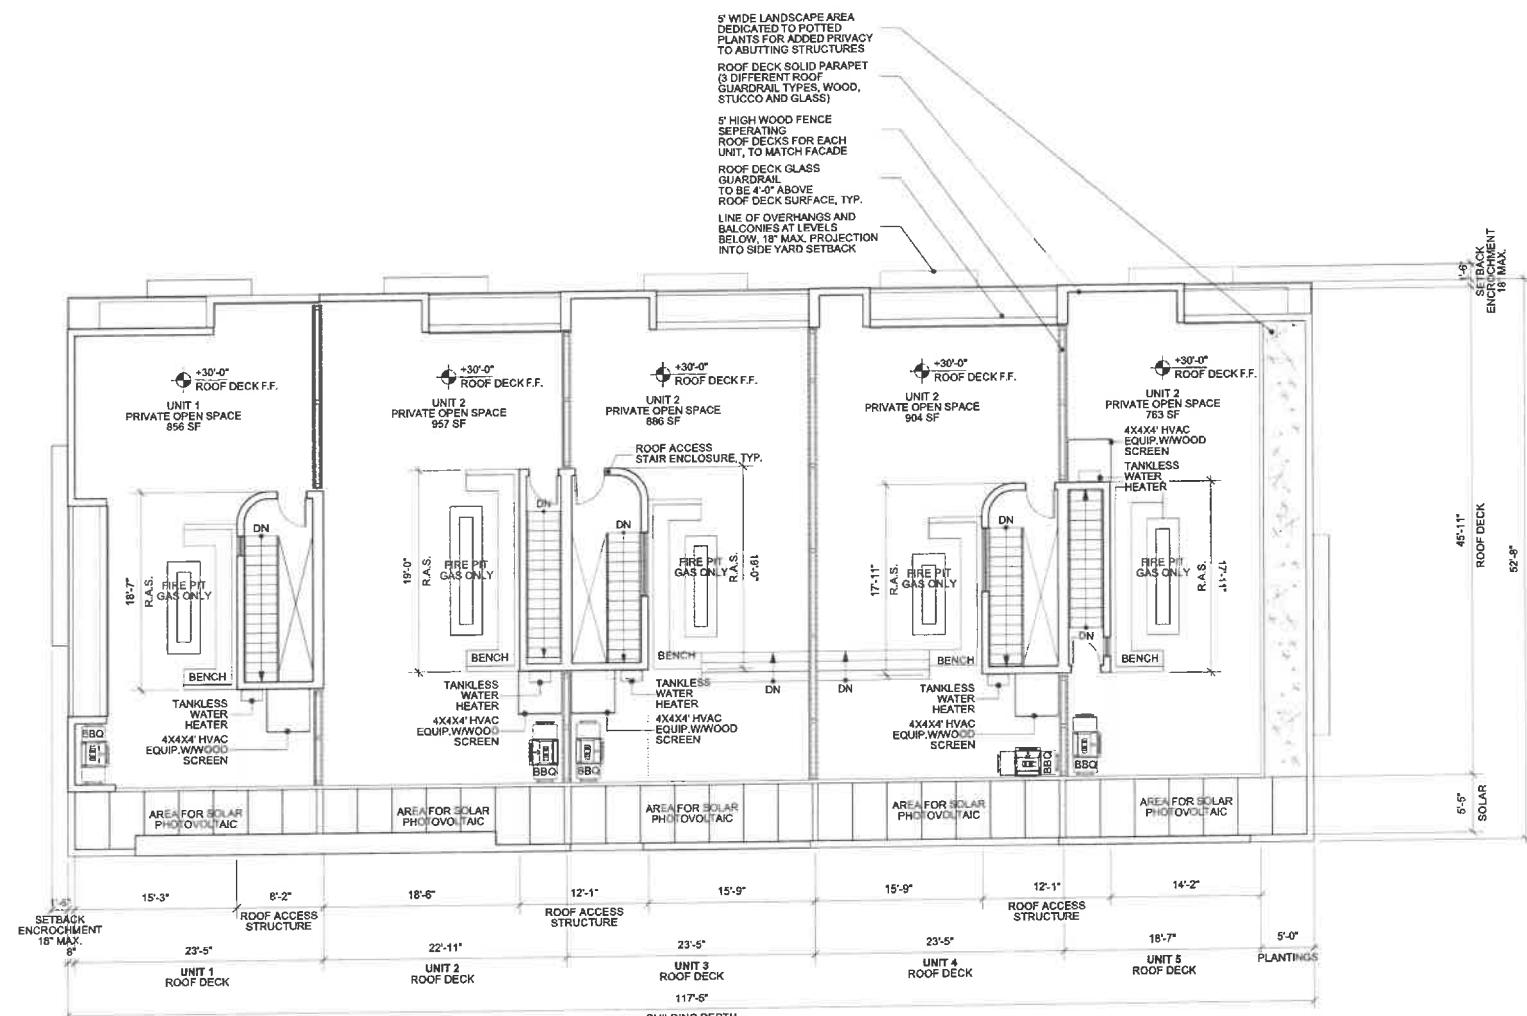

ROOF PLAN
Scale: 1/8" = 1'-0" 1


DATE: 07/16/2020 DRAWN: SBD SCALE: 1/8" = 1'-0"

A-1.4

REVISION / ISSUE:	DATE:
1. PPR SUBMITTAL	5/15/2018
2. DESIGN UPDATE	01/11/2019
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4. PLANNING DIVISION REVIS.	03/20/2019
5. DESIGN UPDATE	04/1/2019
6. DESIGN UPDATE	07/18/2019
7. PLANNING DIVISION RESUB.	10/01/2019
8. PLANNING DIVISION REVIS.	11/08/2019
9. PLANNING DIV. CONDITIONS	04/13/2020
10. PLANNING DIV. REVIS.	07/16/2020

EXTERIOR ELEVATIONS

DATE: 07/16/2020 DRAWN: SBD SCALE: 1/8" = 1'-0"


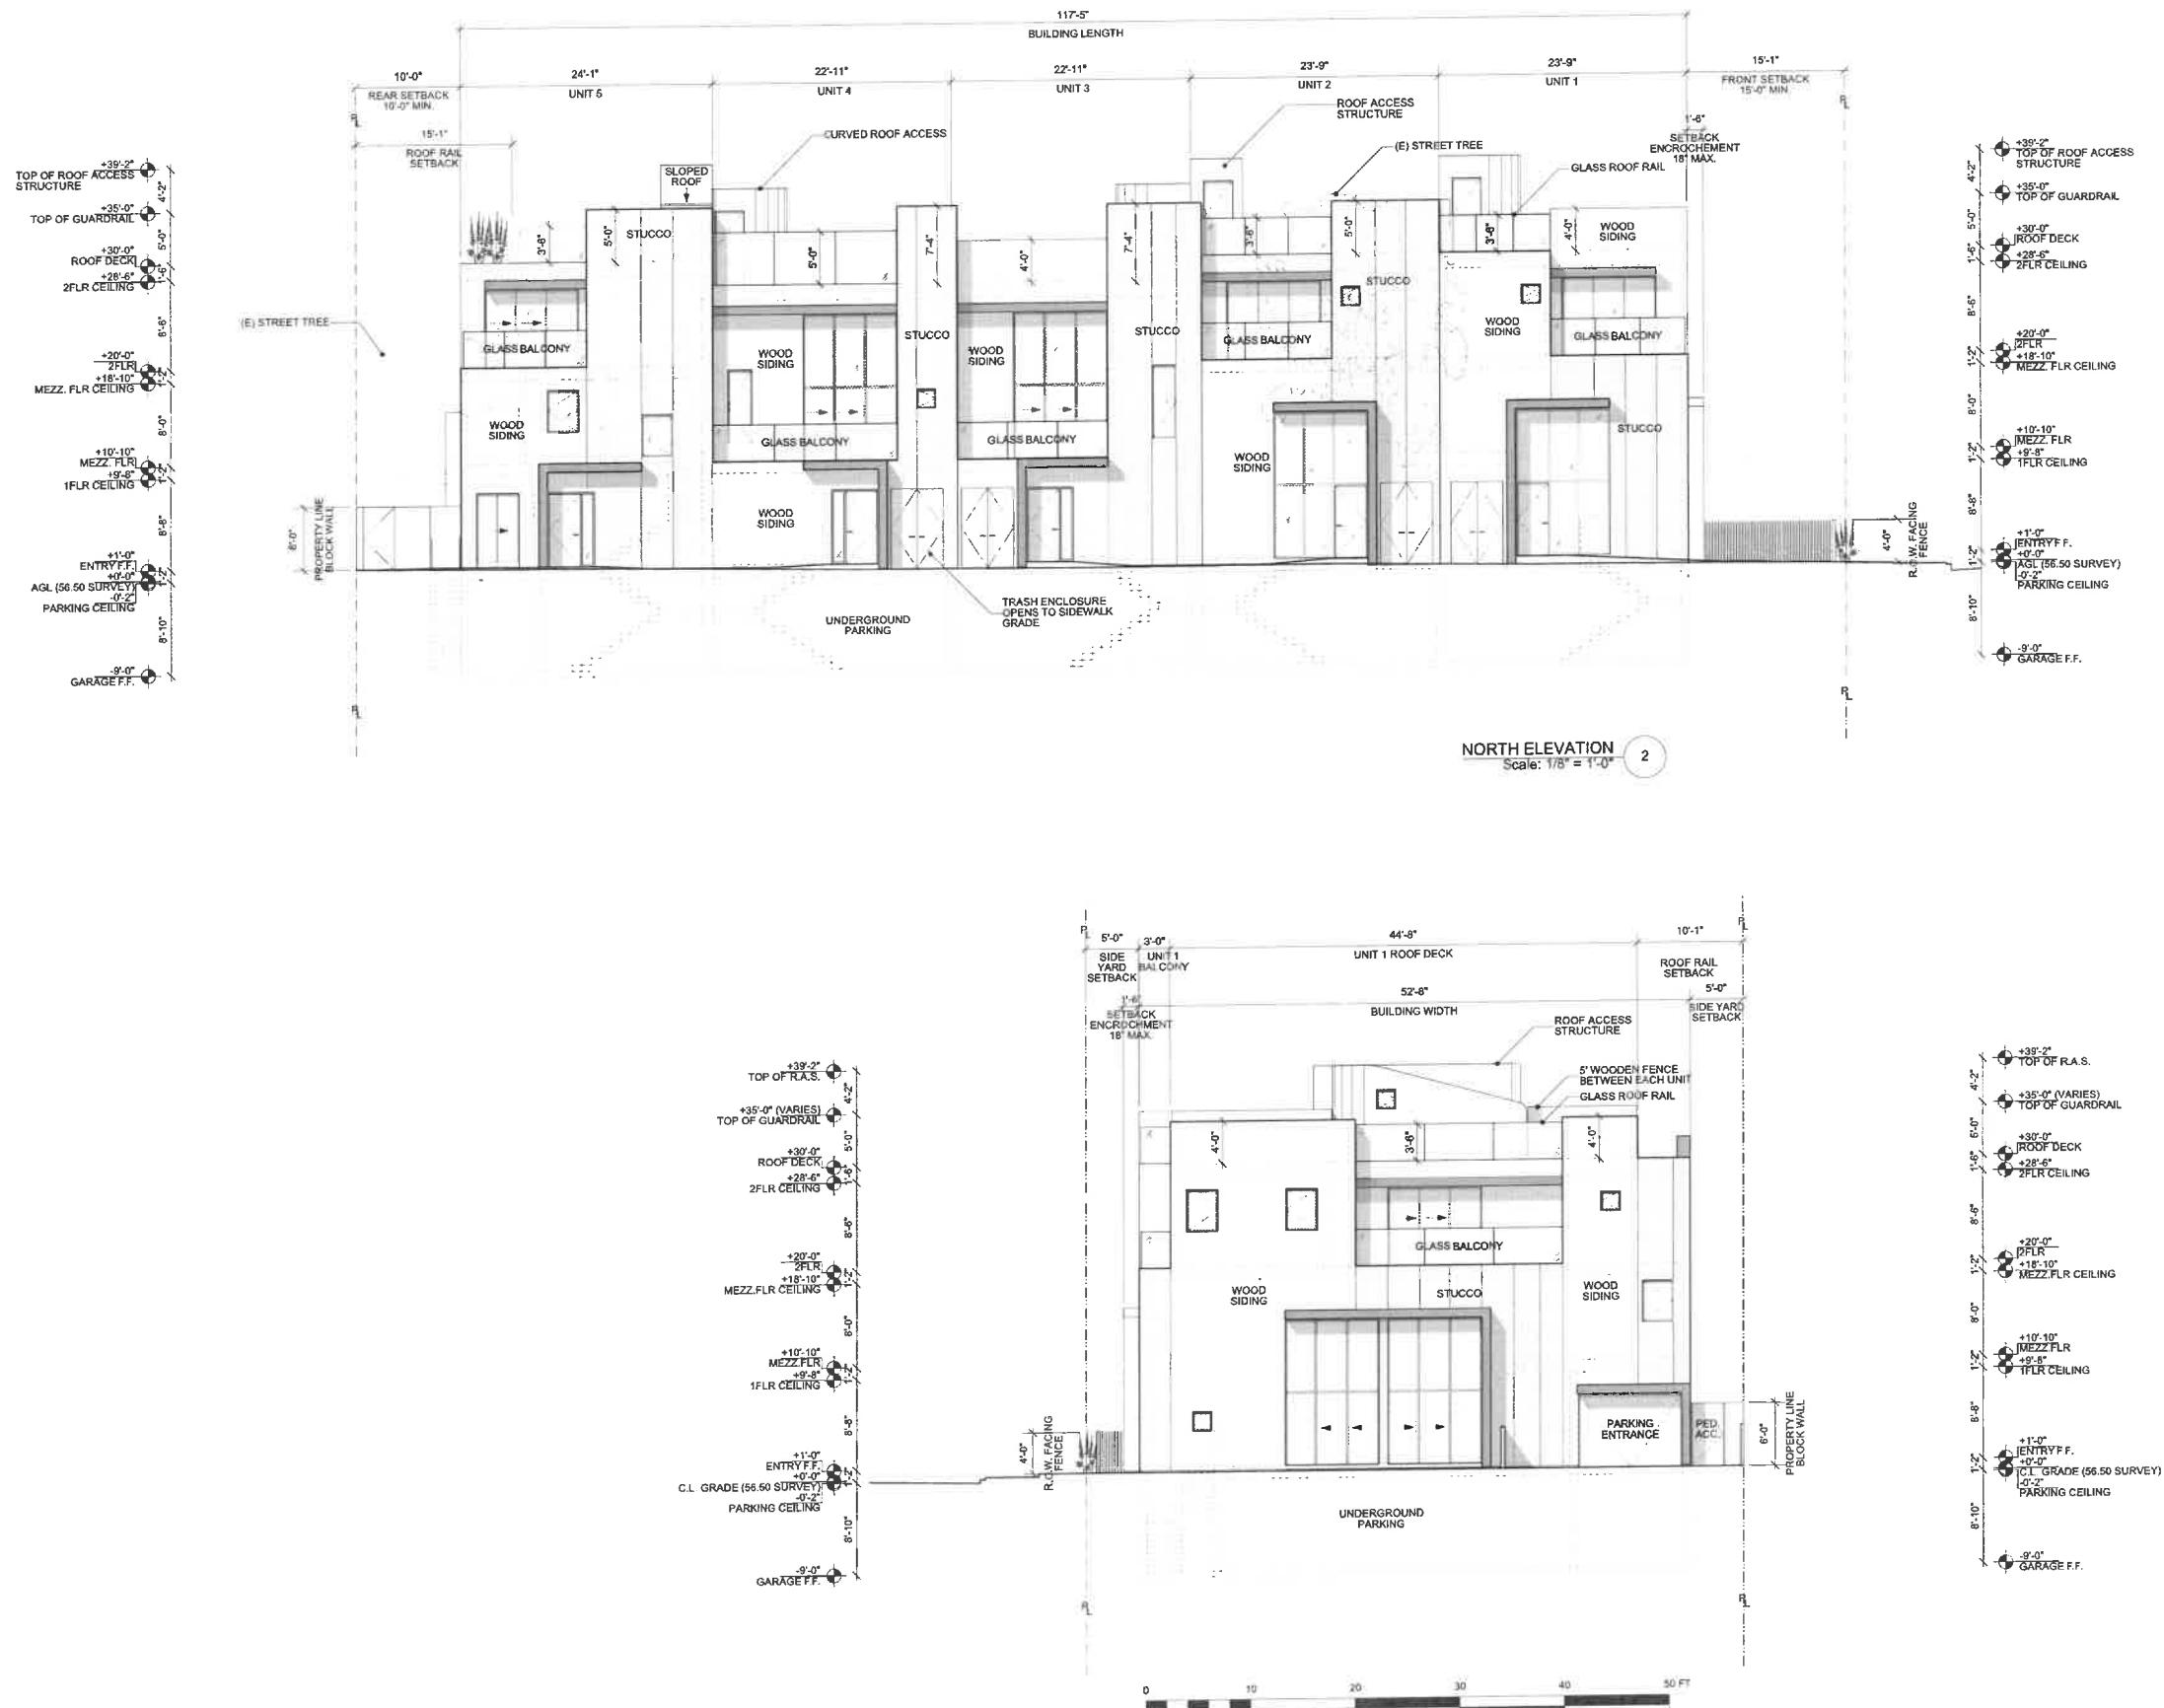


A-2.0



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1. PPR SUBMITTAL	5/15/2018
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10. PLANNING DIV. REVIS.	07/16/2020

EXTERIOR ELEVATIONS

DATE: 07/16/2020 DRAWN: SBD SCALE: 1/8" = 1'-0"

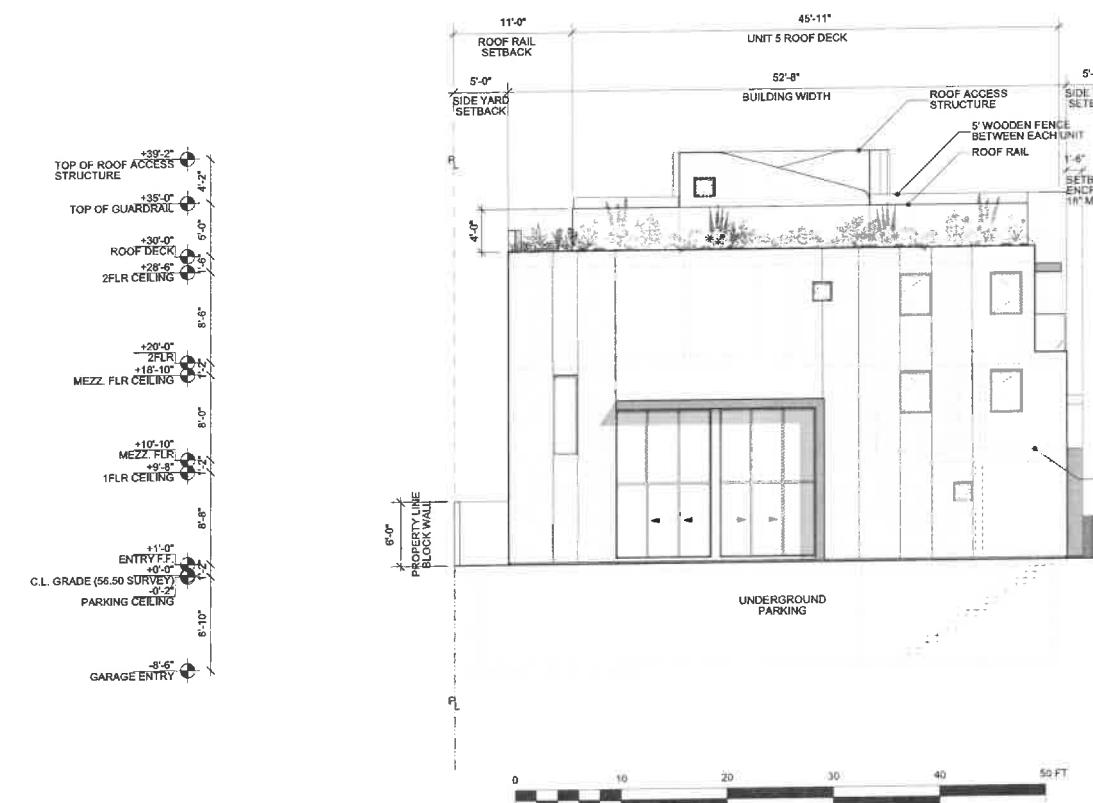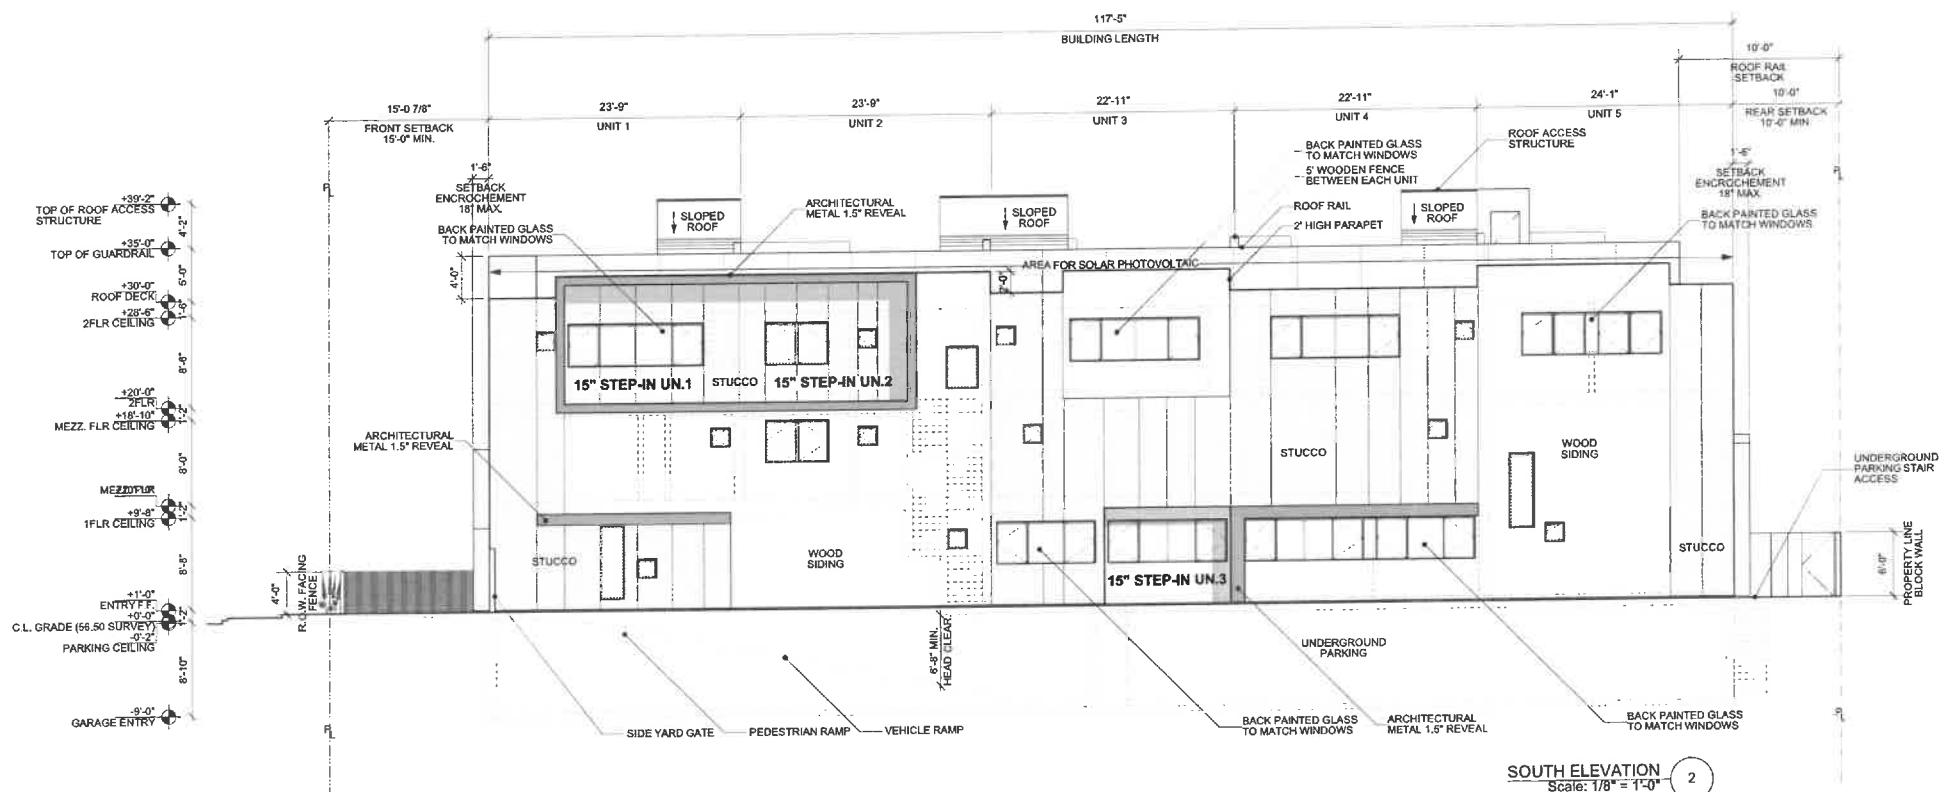

A-2.1

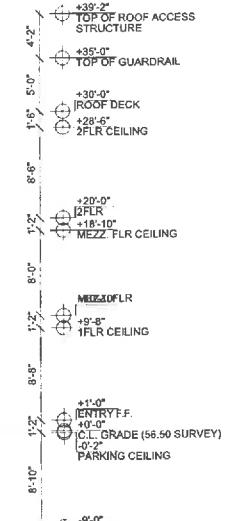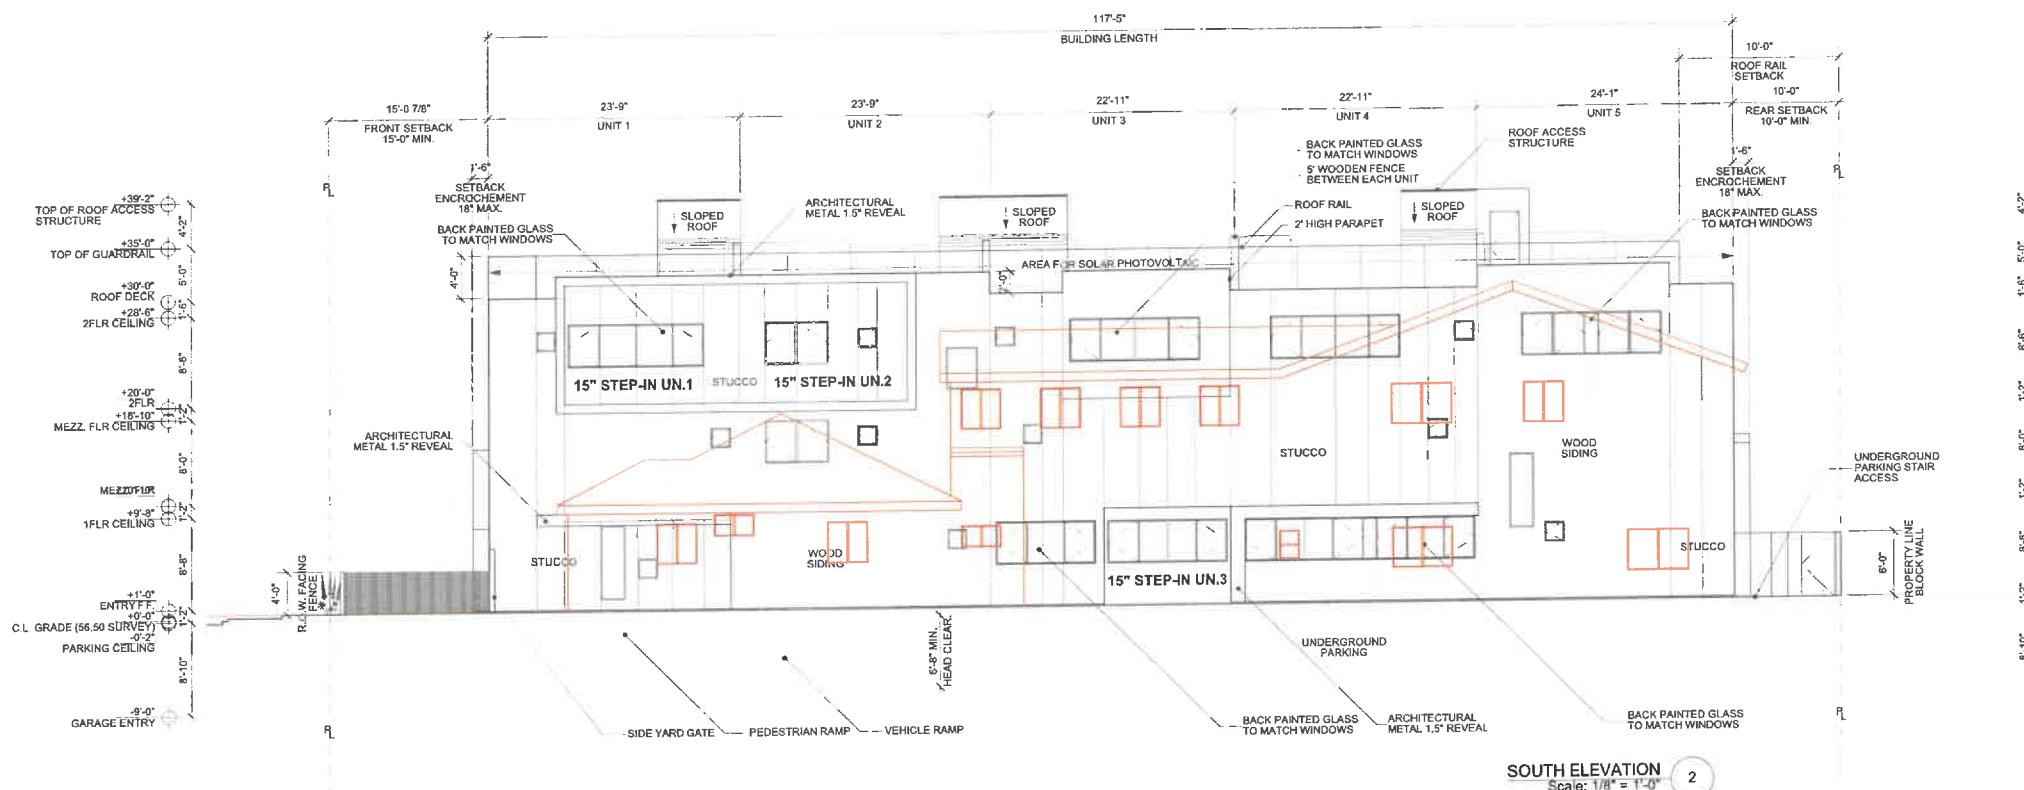

ARCHITECT:
DesignUniversal
ROBERT THIBODEAU
624 VENICE BLVD
VENICE, CA 90291
PH: 310.452.8161
FX: 310.452.8171

OWNER:
1465 PH LLC
280 LENOX AVE, #6J
NEW YORK, NY 10027
PH: 917.566.6477

CONTRACTOR:

SOILS ENGINEER:
HILLSIDE INSPECTIONS, INC.
7622 GODDARD AVE
LOS ANGELES, CA 90045
PH: 424.781.7152
EMAIL: INFO@HILLSIDEINSPECTIONS.COM

SURVEYOR:
M & G CIVIL ENGINEERING & LAND SURVEYING
347 S. ROBERTSON BLVD
BEVERLY HILLS, CA 90211
PH: 310.659.0871
FX: 310.659.0845

STRUCTURAL ENGINEER:
KMS STRUCTURAL DESIGN ENGINEERING
1377 S BEVERLY GLEN BLVD #308
LOS ANGELES, CA 90024
PH: 310.497.0744
EMAIL: KMSSTRUCTURAL@AOL.COM


CIVIL ENGINEER:
HARVEY A. GOODMAN CIVIL ENGINEER
834 17TH STREET UNIT 5
SANTA MONICA, CA 90403
PH: 310.829.1037
FX: 310.828.5002

REVISION / ISSUE:	DATE:
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NEIGHBORING WINDOW STUDY



EAST ELEVATION
Scale: 1/8" = 1'-0"

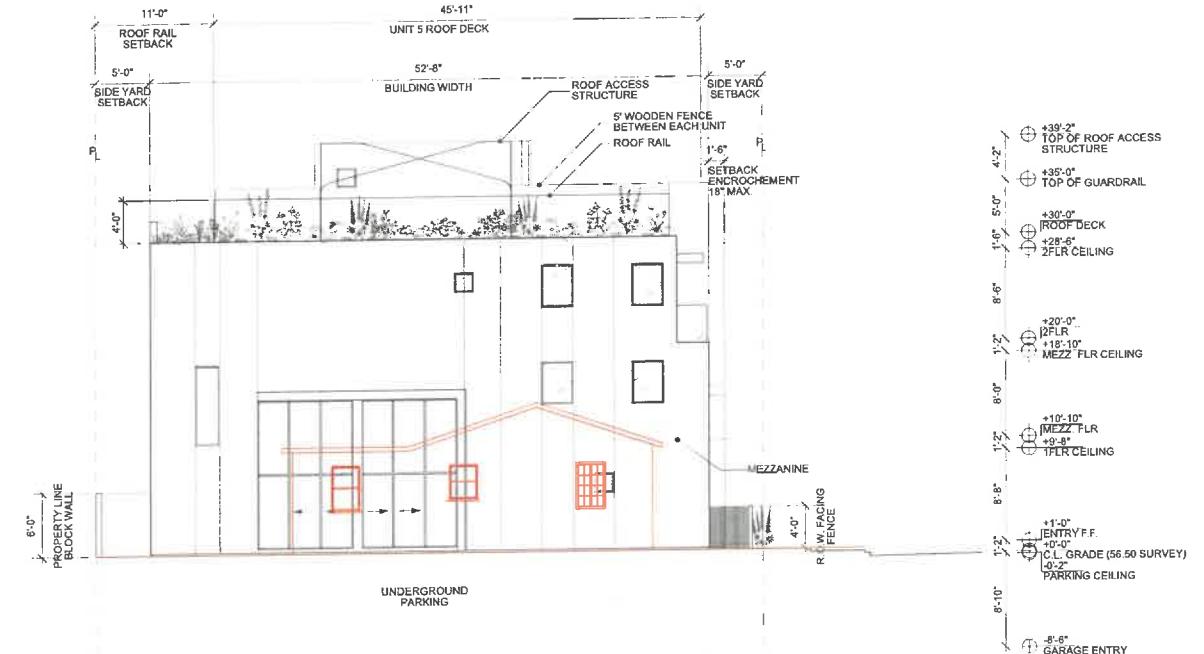


DATE: 04/16/2019 DRAWN: SBD SCALE: 1/8" = 1'-0"

A-2.2

REVISION / ISSUE:	DATE:
1. PPR SUBMITTAL	5/15/2018
2. DESIGN UPDATE	01/11/2019
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5. DESIGN UPDATE	04/10/2019
6. DESIGN UPDATE	07/16/2019
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8. PLANNING DIVISION RESUB.	11/08/2019
9. PLANNING DIV. CONDITIONS	04/13/2020
10. PLANNING DIV. REVIS.	07/16/2020

COLORED SITE PLAN

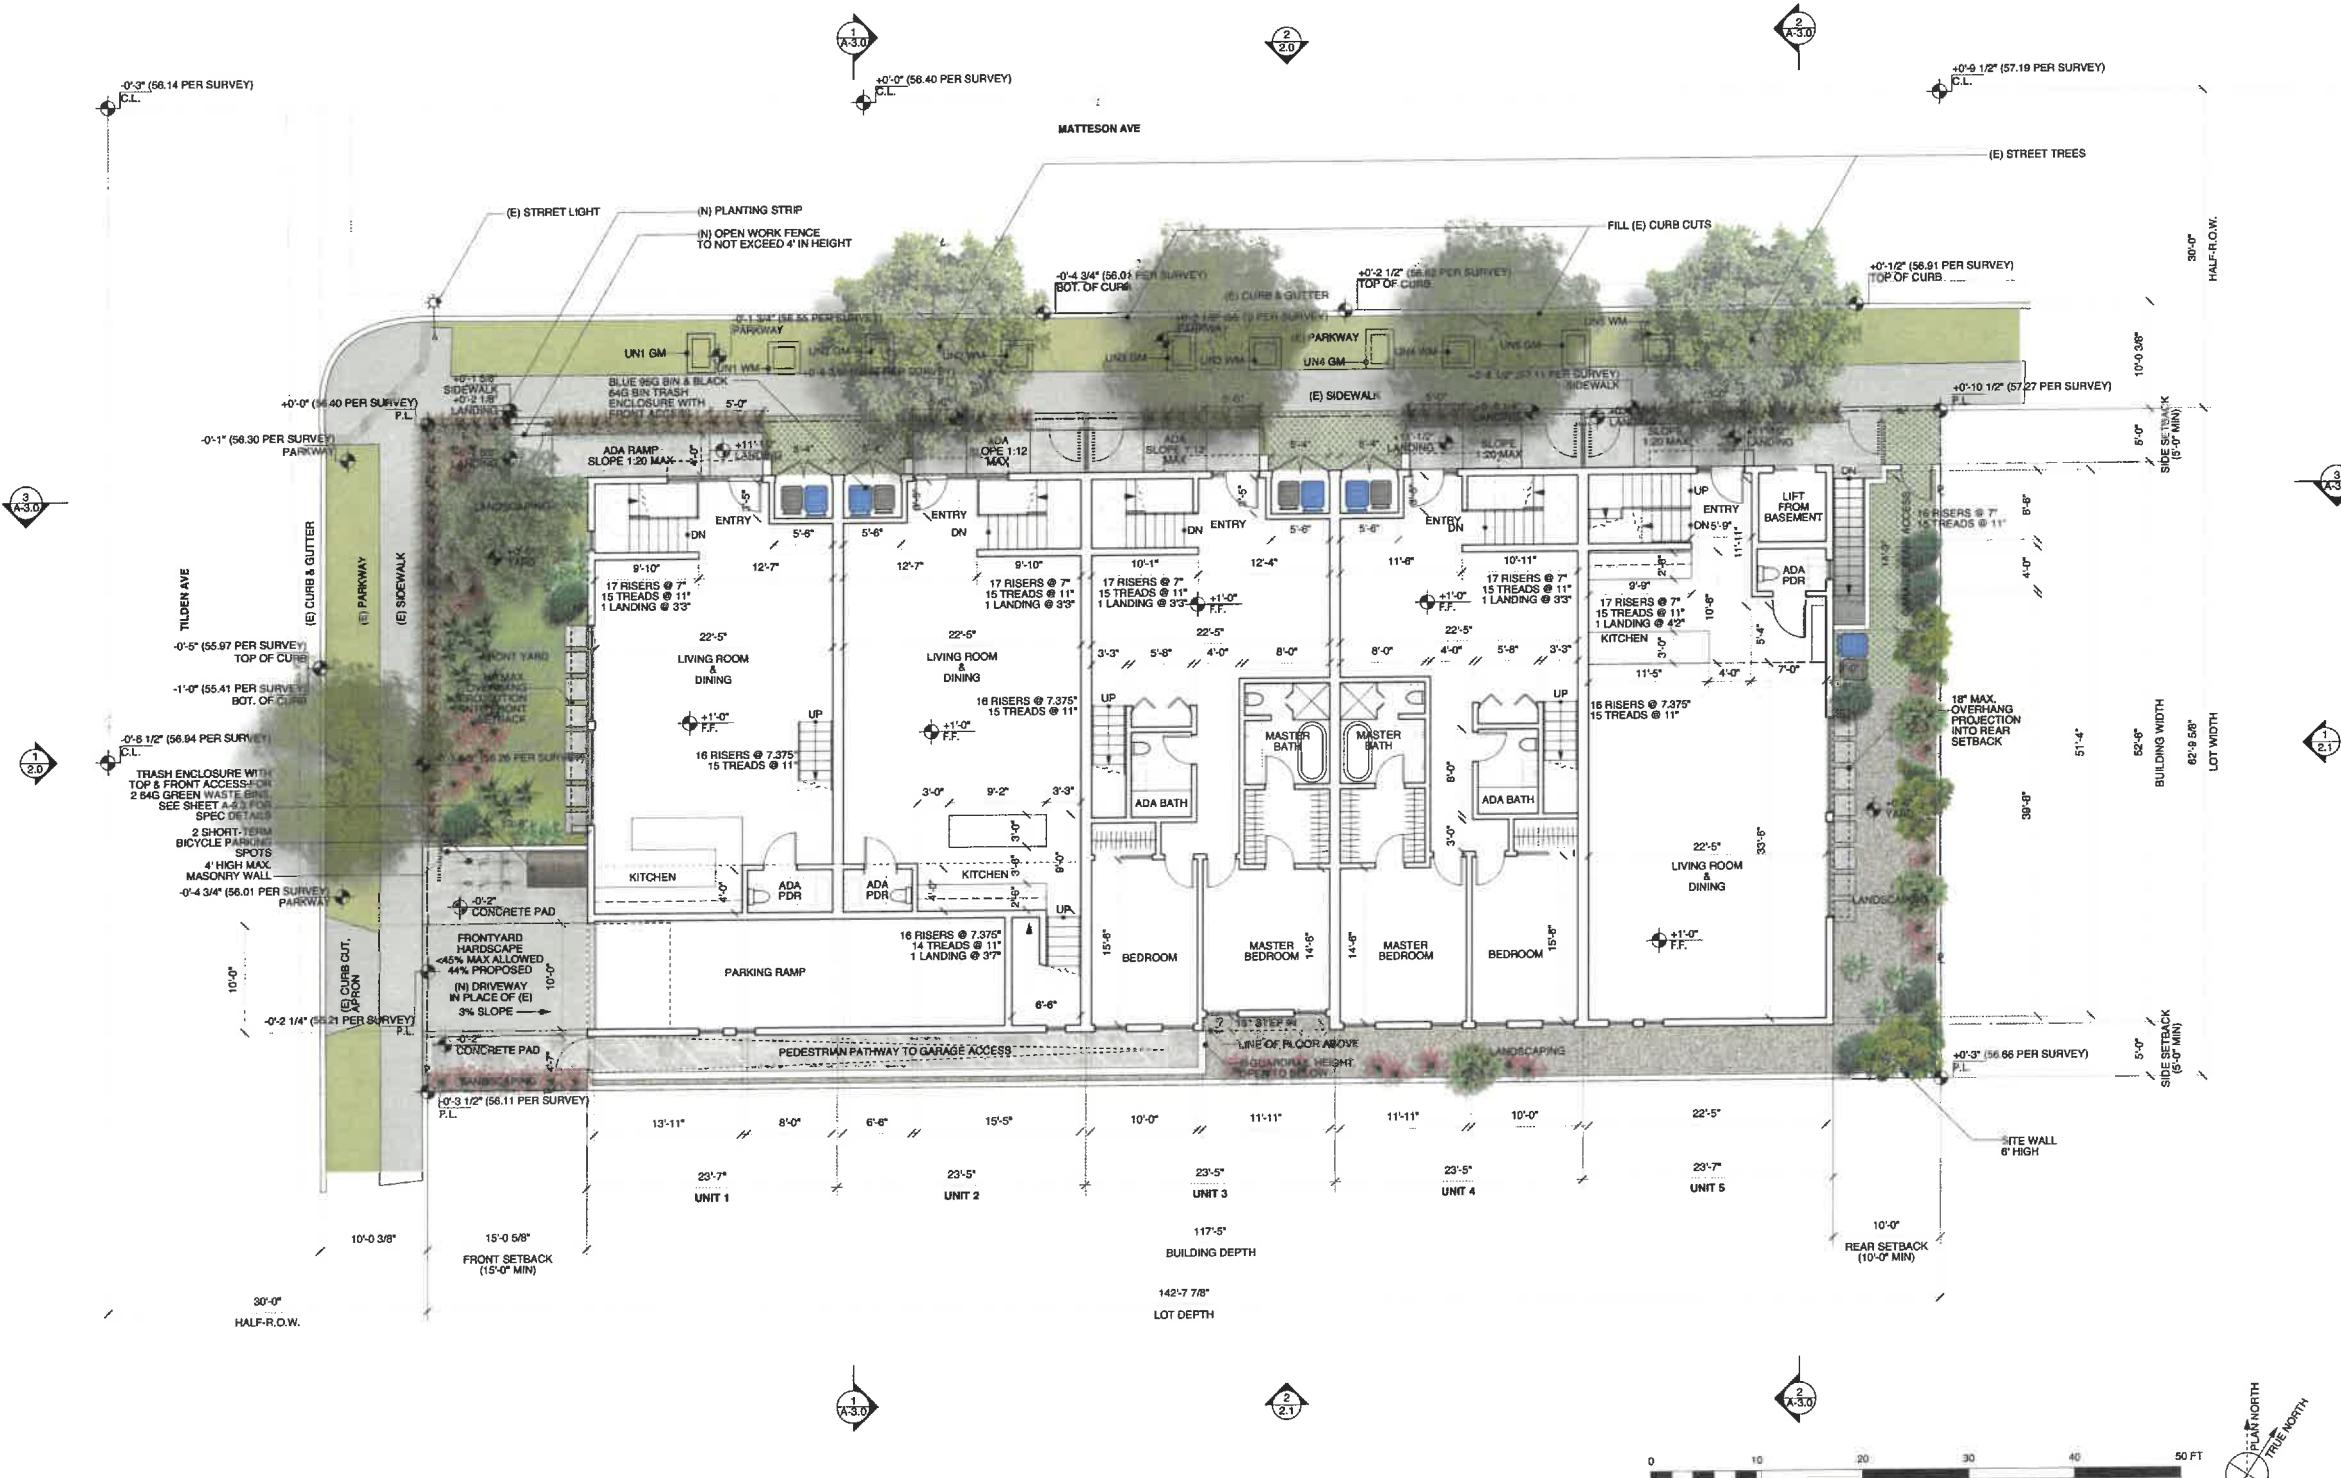

NOTES

ENVIRONMENTAL PROGRAMS AND OPERATIONS NOTES

1) SOLID WASTE, RECYCLABLE WASTE MATERIAL, AND ORGANIC WASTE HANDLING SHALL BE PERFORMED EXCLUSIVELY BY THE CITY OR ITS AUTHORIZED AGENTS. THE CITY COUNCIL MAY REGULATE, BY ORDINANCE OR RESOLUTION, ALL ASPECTS OF SOLID WASTE, RECYCLABLE WASTE MATERIAL, AND ORGANIC WASTE HANDLING, INCLUDING BUT NOT LIMITED TO, FREQUENCY OF COLLECTION, MEANS OF COLLECTION AND TRANSPORTATION, LEVEL OF SERVICES, CHARGES, FEES, AND NATURE, LOCATION AND EXTENT OF PROVIDING SOLID WASTE HANDLING SERVICES.

2) THE CITY OF CULVER CITY SHALL PROVIDE WASTE DISPOSAL AND RECYCLING SERVICES FOR ALL CONSTRUCTION AND DEMOLITION PROJECTS WITHIN CITY LIMITS IN ACCORDANCE WITH CULVER CITY MUNICIPAL CODE 5.01.010.

3) AUTOMATED ORGANIC WASTE CARTS ARE THE RESPONSIBILITY OF THE TENANT(S) OR HOMEOWNER(S) TO ROLL OUT TO THE STREET DURING DESIGNATED TRASH COLLECTION DAY.

ALL EXISTING DRIVEWAY APPROACHES WHICH WILL NO LONGER BE NECESSARY DUE TO THIS PROJECT SHALL BE REMOVED AND REPLACED WITH FULL HEIGHT SIDEWALK, PARKWAY, AND CURB AND GUTTER.

IN COMPLIANCE WITH 17.320.035.C.1.b; TANDEM PARKING SPACES WILL ONLY BE ASSIGNED TO A SINGLE UNIT.

CONCEPTUAL SITE PLAN / GROUND FLOOR PLAN

Scale: 1/8" = 1'-0"

DATE: 07/16/2020 DRAWN: SBD SCALE: NTS

A-9.0

REVISION / ISSUE:	DATE:
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9. PLANNING DIVISION RESUB.	04/13/2020
10. PLANNING DIV. REVIS.	06/23/2020
	07/16/2020

COLORED ELEVATIONS

DATE: 07/16/2020 DRAWN: SBD SCALE: NTS

A-9.1



REVISION / ISSUE:	DATE:
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9. PLANNING DIV. CONDITIONS	04/13/2020
10. PLANNING DIV. REVIS.	07/11/2020

COLORED ELEVATIONS

DATE: 07/15/2020 DRAWN: SBD SCALE: NTS

A-9.2




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REVISION / ISSUE:	DATE:
1. PPR SUBMITTAL	5/16/2018
2. DESIGN UPDATE	01/12/2019
3. PLANNING DIVISION SUB	02/20/2019
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5. DESIGN UPDATE	04/10/2019
6. DESIGN UPDATE	07/16/2019
7. PLANNING DIVISION RESUB.	10/01/2019
8. PLANNING DIVISION REVIS.	11/06/2019
9. PLANNING DIV. CONDITIONS	04/13/2020
10. PLANNING DIV. REVIS.	05/23/2020
	07/16/2020

MATERIALS SHEET

DATE: 07/16/2020 DRAWN: SBD SCALE: NTS

A-9.3

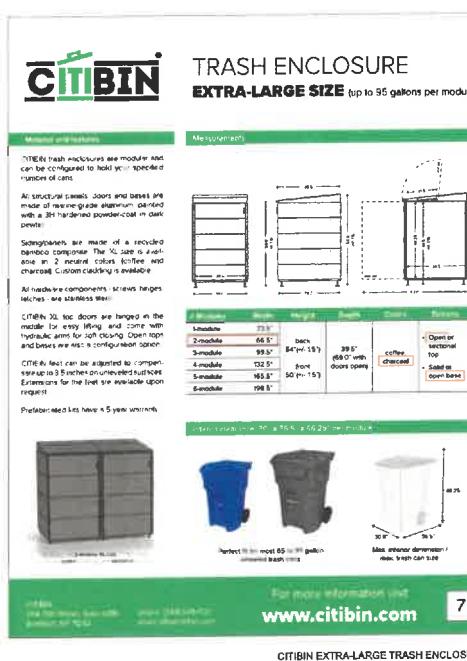

1 2 3 4
5 6 7 8
9 0
NEUTRA


BLACK METAL, NEUTRA STYLE
UNIT ADDRESSES



PANTONE 7753 C
FRONT DOORS & ROOF ACCESS DOORS




TEXTURED BLACK STUCCO PANELS
PROPERTY LINE BLOCK WALL, ROOF STRUCTURES

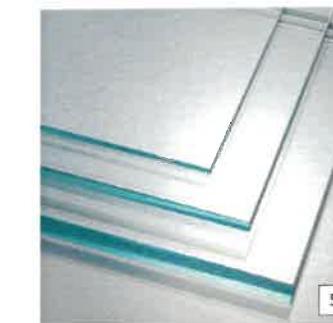

SOLARBAN XL 70 / INSULATED GLASS
WINDOWS, DOORS



SMOOTH NATURAL CONCRETE
STAIRS, PAVERS, DRIVEWAY

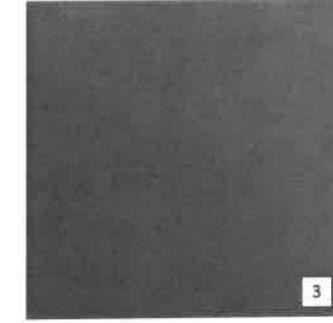

NATURAL STEEL
DOOR AND WINDOW FRAMES AND TRIMS



NATURAL STEEL
OPEN WORK GROUND FLOOR FENCE



WESTERN RED CEDAR VERTICAL SIDING
FAÇADE, ROOFTOP FENCE

MATERIALS 1



PROJECT PERSPECTIVE 2

DATE: 07/16/2020 DRAWN: SBD SCALE: NTS

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10. PLANNING DIV. REVIS.	06/23/2020

PHOTO SIMULATIONS

DATE: 07/16/2020 DRAWN: SBD SCALE: NTS



NORTH WEST FACING VIEW 4



WEST FACING VIEW 2



NORTH EAST FACING VIEW 3



SOUTH WEST FACING VIEW 1

A-9.4

PICTURE THIS LAND
WWW.PICTURTHISLAND.COM
A LANDSCAPE DESIGN/BUILD FIRM
C27 LIC # 984244
818 507 8969

PLANTING PLAN


PROPOSED
5 UNITS CONDOMINIUM BUILDING
3906 TILDEN
CULVER CITY CA 90232

REVISION	DATE	BY

DATE: 07-15-2020
SCALE: 1/8" = 1'-0"
DRAWN BY: G.L.
SHEET:


L-2.0


4 OF 6 SHEETS

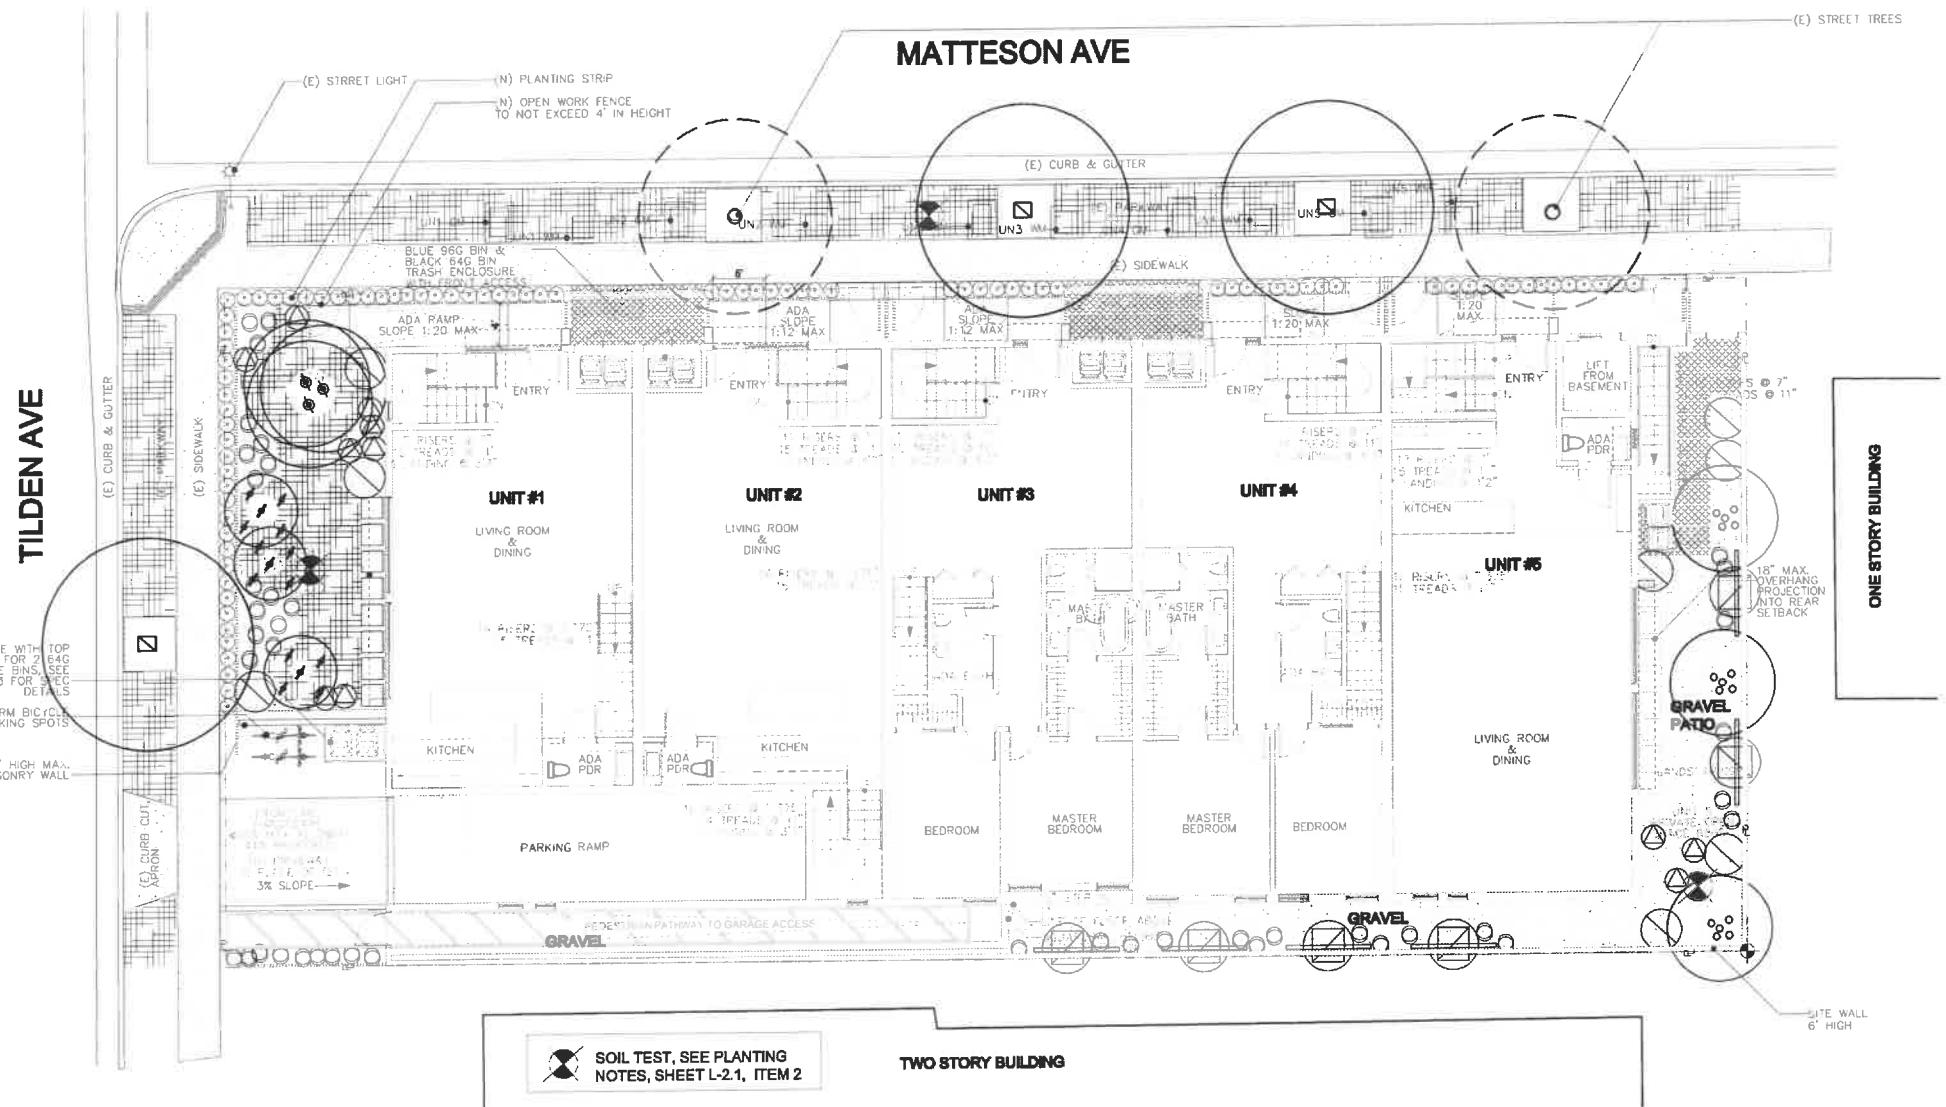

PLANT LEGEND

TREE	NAME	QTY	SIZE	NOTES	ETo ZONE	SHRUBS	NAME	QTY	SIZE	NOTES	ETo ZONE
	EXISTING (E) MAGNOLIA LOS ANGELES CITY STREET TREE TYPICAL	2	EXISTING	SINGLE TRUNK	H ESTABLISHED		AOLE PINK PERFECTION	9	5 GAL.	EACH SYMBOL REPRESENT THREE PLANTS	L
	LAURUS NOBILIS SWEET BAY	3	15 GAL.	SINGLE TRUNK	L		AGAVE ATTENUATA FOX TAIL	11	5 GAL.		L
	LEPTOSPERMUM LAEVIGATUM TEA TREE	1	24" BOX	FREE FORM WHITE BLOOM	L		CALANDRINA SPECTABILIS	36	1 GAL.		L
	LOPHOSTEMON CONFERTUS BRISBANE BOX	2	24" BOX	SINGLE TRUNK DOUBLE STAKE	L		TECOMA CAPENSIS CAPE HONEYSUCKLE	6	15 GAL.	SEE NOTE AND DETAIL FOR TRELLIS SUPPORT	VL
							WESTRINGIA FRUTICOSA COAST ROSEMARY	7	5 GAL.		L
	GC & VINES						GAZANIA 'SILVER LEAF PINK'	-	FLAT	1,175 SQ FT TOTAL YELLOW IN PARKWAY, (780SQFT), ORANGE IN FRONT YARD	L
							GRAVEL			658 SQ FT	
							PHORMIUM JACK SPRATT	97	1 GAL.		L
							GRASS CRETE W/ GRAVEL				

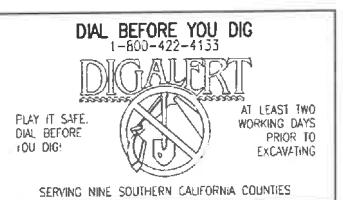

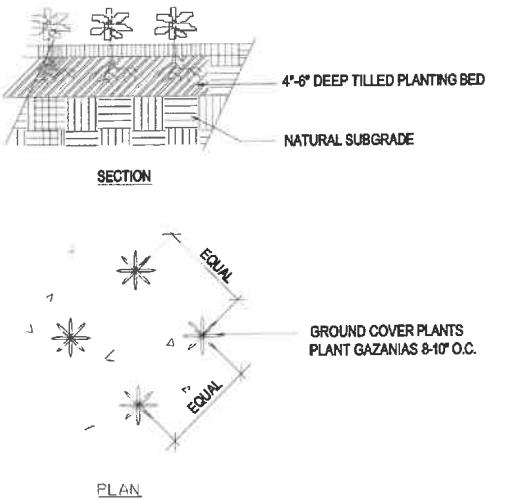

GROUND COVER

NTS

SHRUB PLANTING

NTS

TREE PLANTING & DOUBLE STAKING DETAIL


NTS

GENERAL LANDSCAPE NOTES

- SUBMITTALS: MINIMUM 3 WEEKS PRIOR TO START OF WORK, CONTRACTOR SHALL SUBMIT TO PROJECT MANAGER THREE (3) COPIES OF CATALOG CUTS AND TECHNICAL SPECIFICATIONS FOR ALL MATERIALS PROPOSED FOR USE ON THIS JOB. PROPOSED MATERIALS SUBSTITUTIONS SHALL BE APPROVED BY PROJECT MANAGER BEFORE BRINGING TO SITE. SUBMIT SOURCE OF ANY IMPORT SOIL AND PROVIDE CURRENT AGRONOMIC SOIL TEST OF THE SOIL FOR REVIEW & APPROVAL OF PROJECT MANAGER. RESUBMIT ANY REJECTED SUBMITTALS UNTIL APPROVED BY PROJECT MANAGER.
- PLANT SUBMITTALS: SUBMIT NAME OF NURSERY AND COLOR PHOTOGRAPH OF PLANT MATERIALS 15 GALLON SIZE AND GREATER WITH PERSON SHOWN IN PHOTO FOR SCALE. TREES SHALL BE LOCATED AT THEIR NURSERY SOURCES AND CONTRACTOR SHALL NOTIFY PROJECT MANAGER A MINIMUM OF 72 HOURS IN ADVANCE FOR PROJECT MANAGER TO INSPECT AND TAG TREES AT THE SOURCE.
- CONTRACTOR SHALL PROVIDE ALL MATERIALS AND SKILLED WORKERS SUFFICIENT TO COMPLETE THE WORK IN THESE DRAWINGS. CONTRACTOR SHALL COORDINATE HIS/her WORK WITH ALL AFFECTED TRADES.
- CONTRACTOR SHALL VERIFY ALL SCALED DIMENSIONS AND QUANTITIES PRIOR TO START OF WORK AND INFORM PROJECT MANAGER OF ANY DISCREPANCIES BETWEEN THE CONTRACT DRAWINGS AND THE SITE CONDITIONS PRIOR TO STARTING WORK. DO NOT WORK IN AREAS WHERE DISCREPANCIES ARE NOTED UNTIL FURTHER INSTRUCTION BY PROJECT MANAGER. ALL WORK SHALL COMPLY WITH CURRENT APPLICABLE CODES AND REGULATIONS.
- Maintenance and Guarantees: UPON COMPLETION OF OWNER-ACCEPTANCE OF WORK, CONTRACTOR SHALL PERFORM ALL MAINTENANCE FOR 60 DAYS, DURING WHICH TIME CONTRACTOR WILL GUARANTEE ALL SHRUBS AND GROUNDCOVERS. ALL TREES WILL BE GUARANTEED FOR 1 YEAR.
- INSPECTIONS: NOTIFY 72 HOURS IN ADVANCE FOR ALL WALK-THROUGHS IN ORDER TO HAVE WORK APPROVED.
- DELIVERIES AND STORAGE: DELIVER MATERIALS TO THE SITE IN ORIGINAL MANUFACTURER'S CONTAINERS WITH LABELS INTACT AND LEGIBLE. STORE MATERIALS AT JOB-SITE AT LOCATION APPROVED BY OWNER OR PROJECT MANAGER. REMOVE DAMAGED MATERIALS FROM THE JOB SITE AND PROMPTLY REPLACE AT NO ADDED COST TO OWNER. DO NOT DELIVER PLANT MATERIALS TO THE SITE UNTIL THE APPROVED DAY OF PLANTING. ALL PLANT MATERIALS SHALL BE PLANTED ON THE DAY OF DELIVERY.
- PROTECTION: FOR STREET TREE PROTECTION, PROTECT EXISTING STREET TREES, PLANT MATERIALS, STRUCTURES, AND UTILITIES UNLESS SPECIFICALLY DIRECTED IN THE CONTRACT DOCUMENTS OR BY AUTHORITY OF THE OWNER. IF DIRECTED TO DO SO, CONTRACTOR SHALL ERECT TEMPORARY FENCING AROUND EXISTING STREET TREES TO REMAIN.

PLANTING NOTES

TIE TREE STAKES TO TREE WITH ONE 3/4" WIDE X 1' LONG TIRE CORD BAND WITH #18 TIE WIRES. ATTACH WIRES TO STAKE BY WRAPPING WIRE AROUND EACH STAKE TWO TIMES, TWIST ENDS TOGETHER AND SECURE TO STAKE WITH CLECHED 6d NAIL. A CT-24, CINCH TIE MAY BE USED IN LIEU OF THE TIRE CORD TIE, SECURE WITH 6d NAIL. ATTACH ONE TREE TIE JUST UNDER HEAD OF TREE AND AN OTHER MIDWAY UP THE TRUNK. NO HOSE AND WIRE TIES.

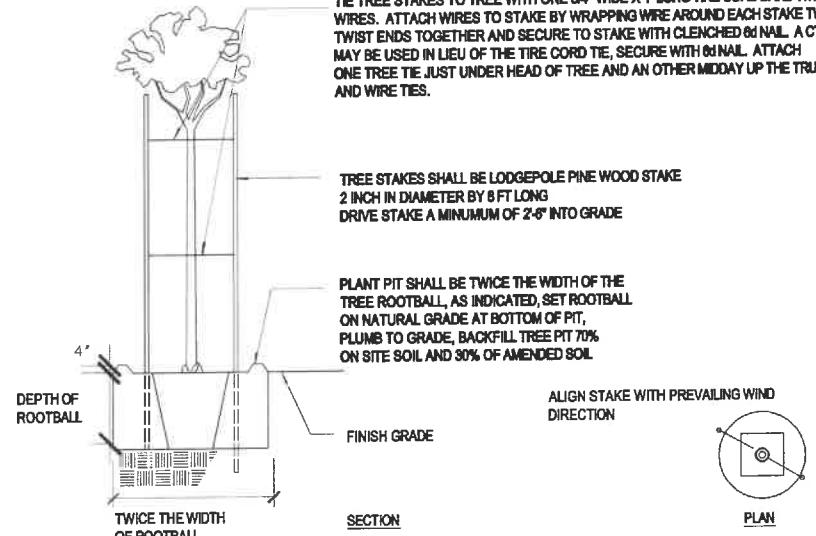

PLANTING DETAILS & NOTES

PROPOSED
5 UNITS CONDOMINIUM BUILDING
3906 TILDEN
CULVER CITY CA 90232


REVISION DATE BY

DATE: 07-15-2020

SCALE: 1/8" = 1'-0"

DRAWN BY: G.L.

SHEET:

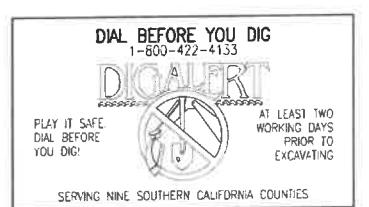

L-2.1

5 OF 6 SHEETS

PICTURE THIS LAND
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PLANTING CONCEPT

PROPOSED
5 UNITS CONDOMINIUM BUILDING
3906 TILDEN
CULVER CITY CA 90232

REVISION	DATE	BY

DATE: 07-15-2020

SCALE: 1/8" = 1'-0"

DRAWN BY: G.L.

SHEET:

PC-1.0

1 OF 6 SHEETS



LOPHOSTEMON



GAZANIA



LEPTOSPERMUM



ALOE




PHORMIUM



GAZANIA



WESTRINGIA

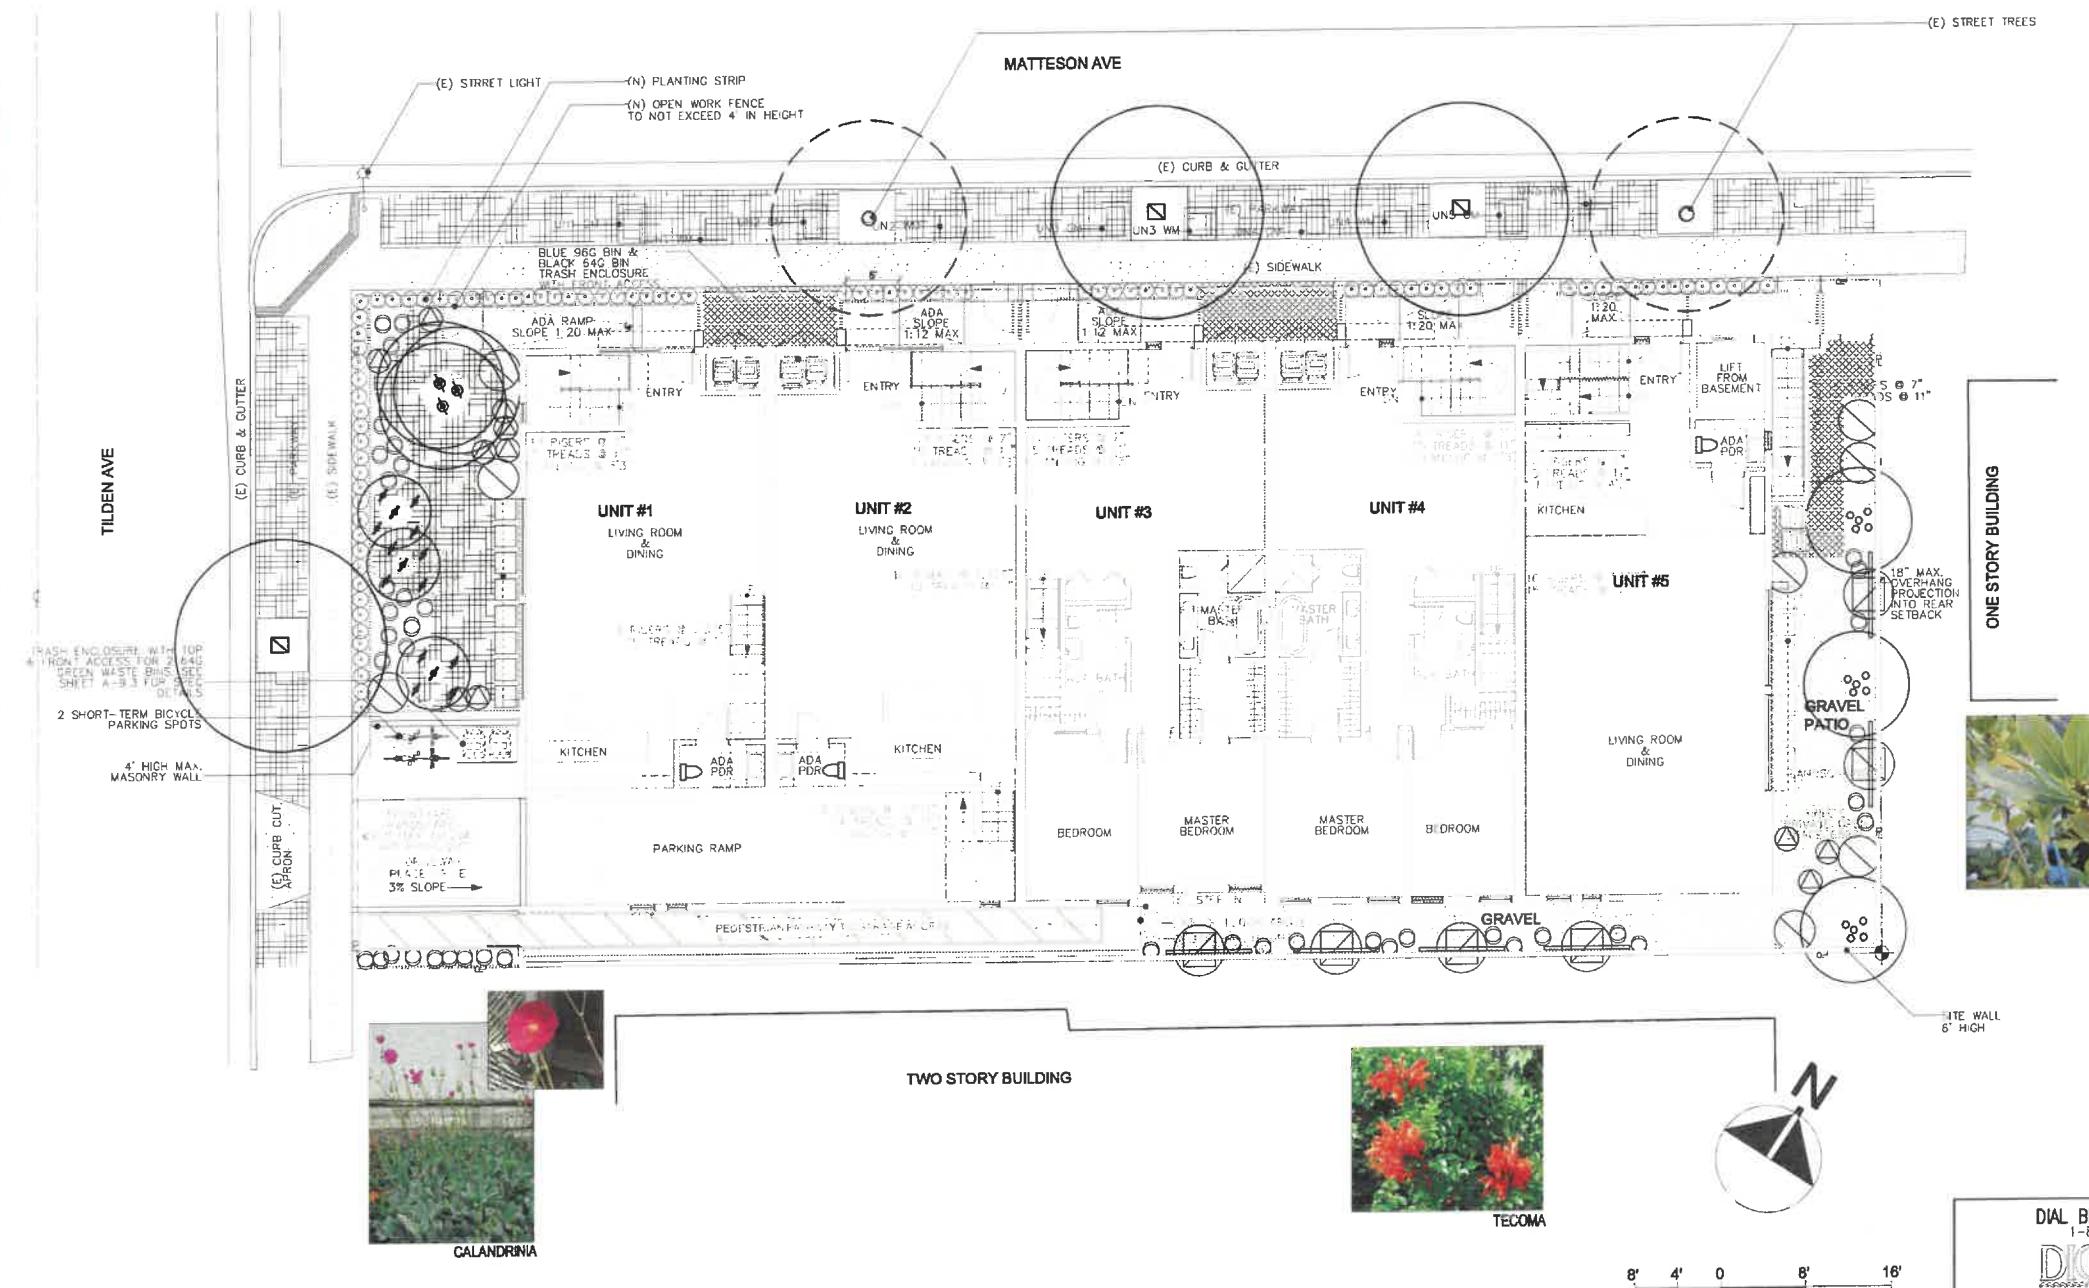

PICTURE THIS LAND
WWW.PICTURTHISLAND.COM
A LANDSCAPE DESIGN/BUILD FIRM
C27 LIC # 884244
818 507 8968

ROOF PLANTING

PROPOSED
5 UNITS CONDOMINIUM BUILDING
3906 TILDEN
CULVER CITY CA 90232

REVISION	DATE	BY

DATE: 07-15-2020

SCALE: 1/8" = 1'-0"

DRAWN BY: G.L.

SHEET:

RP-3.0

6 OF 6 SHEETS




GRAPTOPETALUM PARAGUAYENSE 'PINKY'



KALANCHOE BEHARENSIS



SENECO

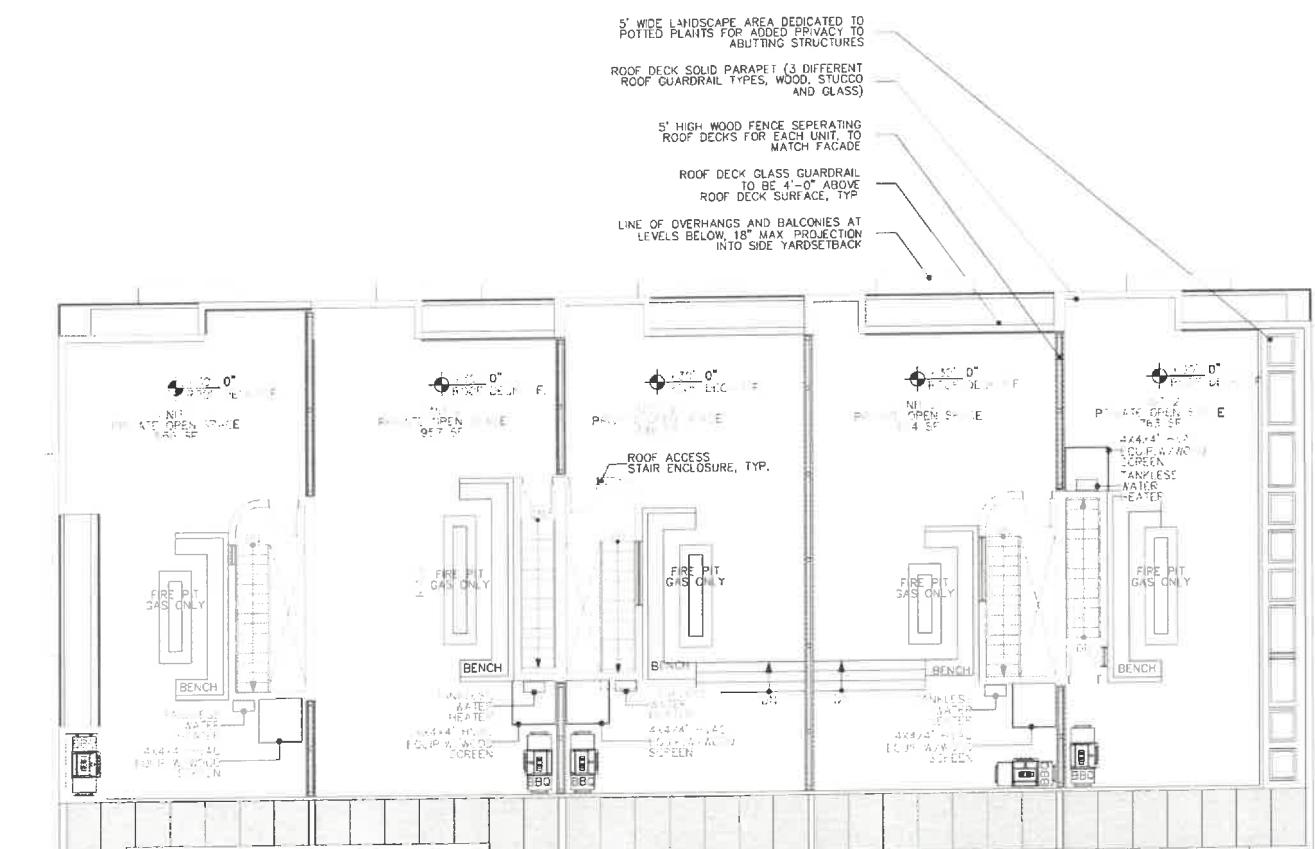

TILDEN AVE



KALANCHOE LUCIA



AGAVE 'OCTOPUS'



AOLE STRIATA



BULBINE



EUPHORBIA TIRUCALLI



FURCRAEA



HESPERALOE



GRAPTOPETALUM

POT LEGEND:
SELECTION FROM TOURNESOL SITESWORKS CATALOG OR EQUAL.
SQ FT PER CONTAINER SELECTION

- MODEL UR-603030 OR 8.30 SQFT & 25.5 CY
- MODEL UR-363030 OR 7.5 SQFT & 15 CY

COLORS SUGGESTED OR EQUAL: 'LEAF', 'ROYAL CARIBBEAN',
'CANARY', AND 'MANDARIN COPPER'

SOIL:
USE LIGHT WEIGHT SOIL
SEE PLANTING NOTES L-2.1

IRRIGATION:
ALL THE POTS WILL BE HAND WATERED USING THE TOURNESOL SITE WORKS IRRIGATION TECHNOLOGY.
RECTANGLES=MATCHING IRRIGATION: UR-603030 CWM R1614-2K, UR-363030 CWM P2020-2K

ROOF POT DESIGN
18 MODEL UR-603030 225 SQFT
15 MODEL UR-363030 112.5 SQFT
TOTAL ROOF LANDSCAPE 337.5 SQFT

UR 603030 POT PLANTING SCHEDULE AND OPTIONS:

OPTION A

7 1GAL BULBINE PER PLANTER

OPTION B

5-5GAL HESPERALOE PARVIFLORA

RED YUCCA

OPTION C

1-5GAL KALANCHOE BEHARENSIS

FELT PLANT

1-5GAL HESPERALOE PARVIFLORA

RED YUCCA

ALTERNATE OPTIONS FOR BETTER RESULT

4-1 GAL SENECIO SERPENS

UR 363030 POT PLANTING SCHEDULE AND OPTIONS:

OPTION A

1-5GAL EUPHORBIA TIRUCALLI

'FIRE STICKS'

1-5GAL ALOE STRIATA

1-1 GAL OSCLERIA

OPTION B

1-5GAL FURCRAEA FOETIDA

MAURITIUS HEMP

2-1GAL OSCLERIA

OPTION C

1-5GAL AGAVE VILMORIANA OCTOPUS AGAVE

1-2GAL KALANCHOE LUCIA

2-1 GAL GRAPTOPETALUM PARAGUAYENSE 'PINKY'

