SCHAEFER 3516 **CORE & SHELL**

3516 SCHAEFER STREET CULVER CITY, CA 90232

OWNER: REDCAR PROPERTIES LTD

2341 MICHIGAN AVE

SANTA MONICA, CA 90404



LOS ANGELES, CA 90039 T: 323-663-9898 F: 323-663-9899 WWW.RACDB.COM

RAC DESIGN BUILD ARCHITECTS - DISCLAIMER

THIS DRAWING AND/OR ELECTRONIC FILE IS COPYRIGHT AND SHALL NOT BE REPRODUCED NOR USED FOR ANY OTHER PURPOSE WITHOUT THE WRITTEN PERMISSION OF THE ARCHITECTS. THIS DRAWING MUST BE READ IN CONJUNCTION WITH ALL OTHER RELATED DRAWINGS AND DOCUMENTATION. IT IS THE CONTRACTOR'S RESPONSIBILITY TO ENSURE FULL COMPLIANCE WITH BUILDING DEPARTMENT REGULATIONS. DO NOT SCALE FROM THIS DRAWING, USE FIGURED DIMENSIONS ONLY. IT IS THE CONTRACTOR'S RESPONSIBILITY TO CHECK AND VERIFY ALL DIMENSIONS ON SITE. ANY DISCREPANCIES TO BE REPORTED IMMEDIATELY TO ARCHITECT & OWNER PRIOR TO INSTALLATION OF WORK.

CONSULTANTS: STRUCTURAL ENGINEER **GLOTMAN SIMPSON**

600 WILSHIRE BLVD., STE 650 LOS ANGELES, CA 90017 213.283.2513


MEP ENG AMA CONSULTING ENGINEERS 2101 EL S. GUNDO BLVD.

700 SOUTH FLOWER ST. STE 2100

CIVIL ENGINEED

SCALE AT ARCH D (24 x 36): DRAWN BY: RAC SHEET NUMBER:

000

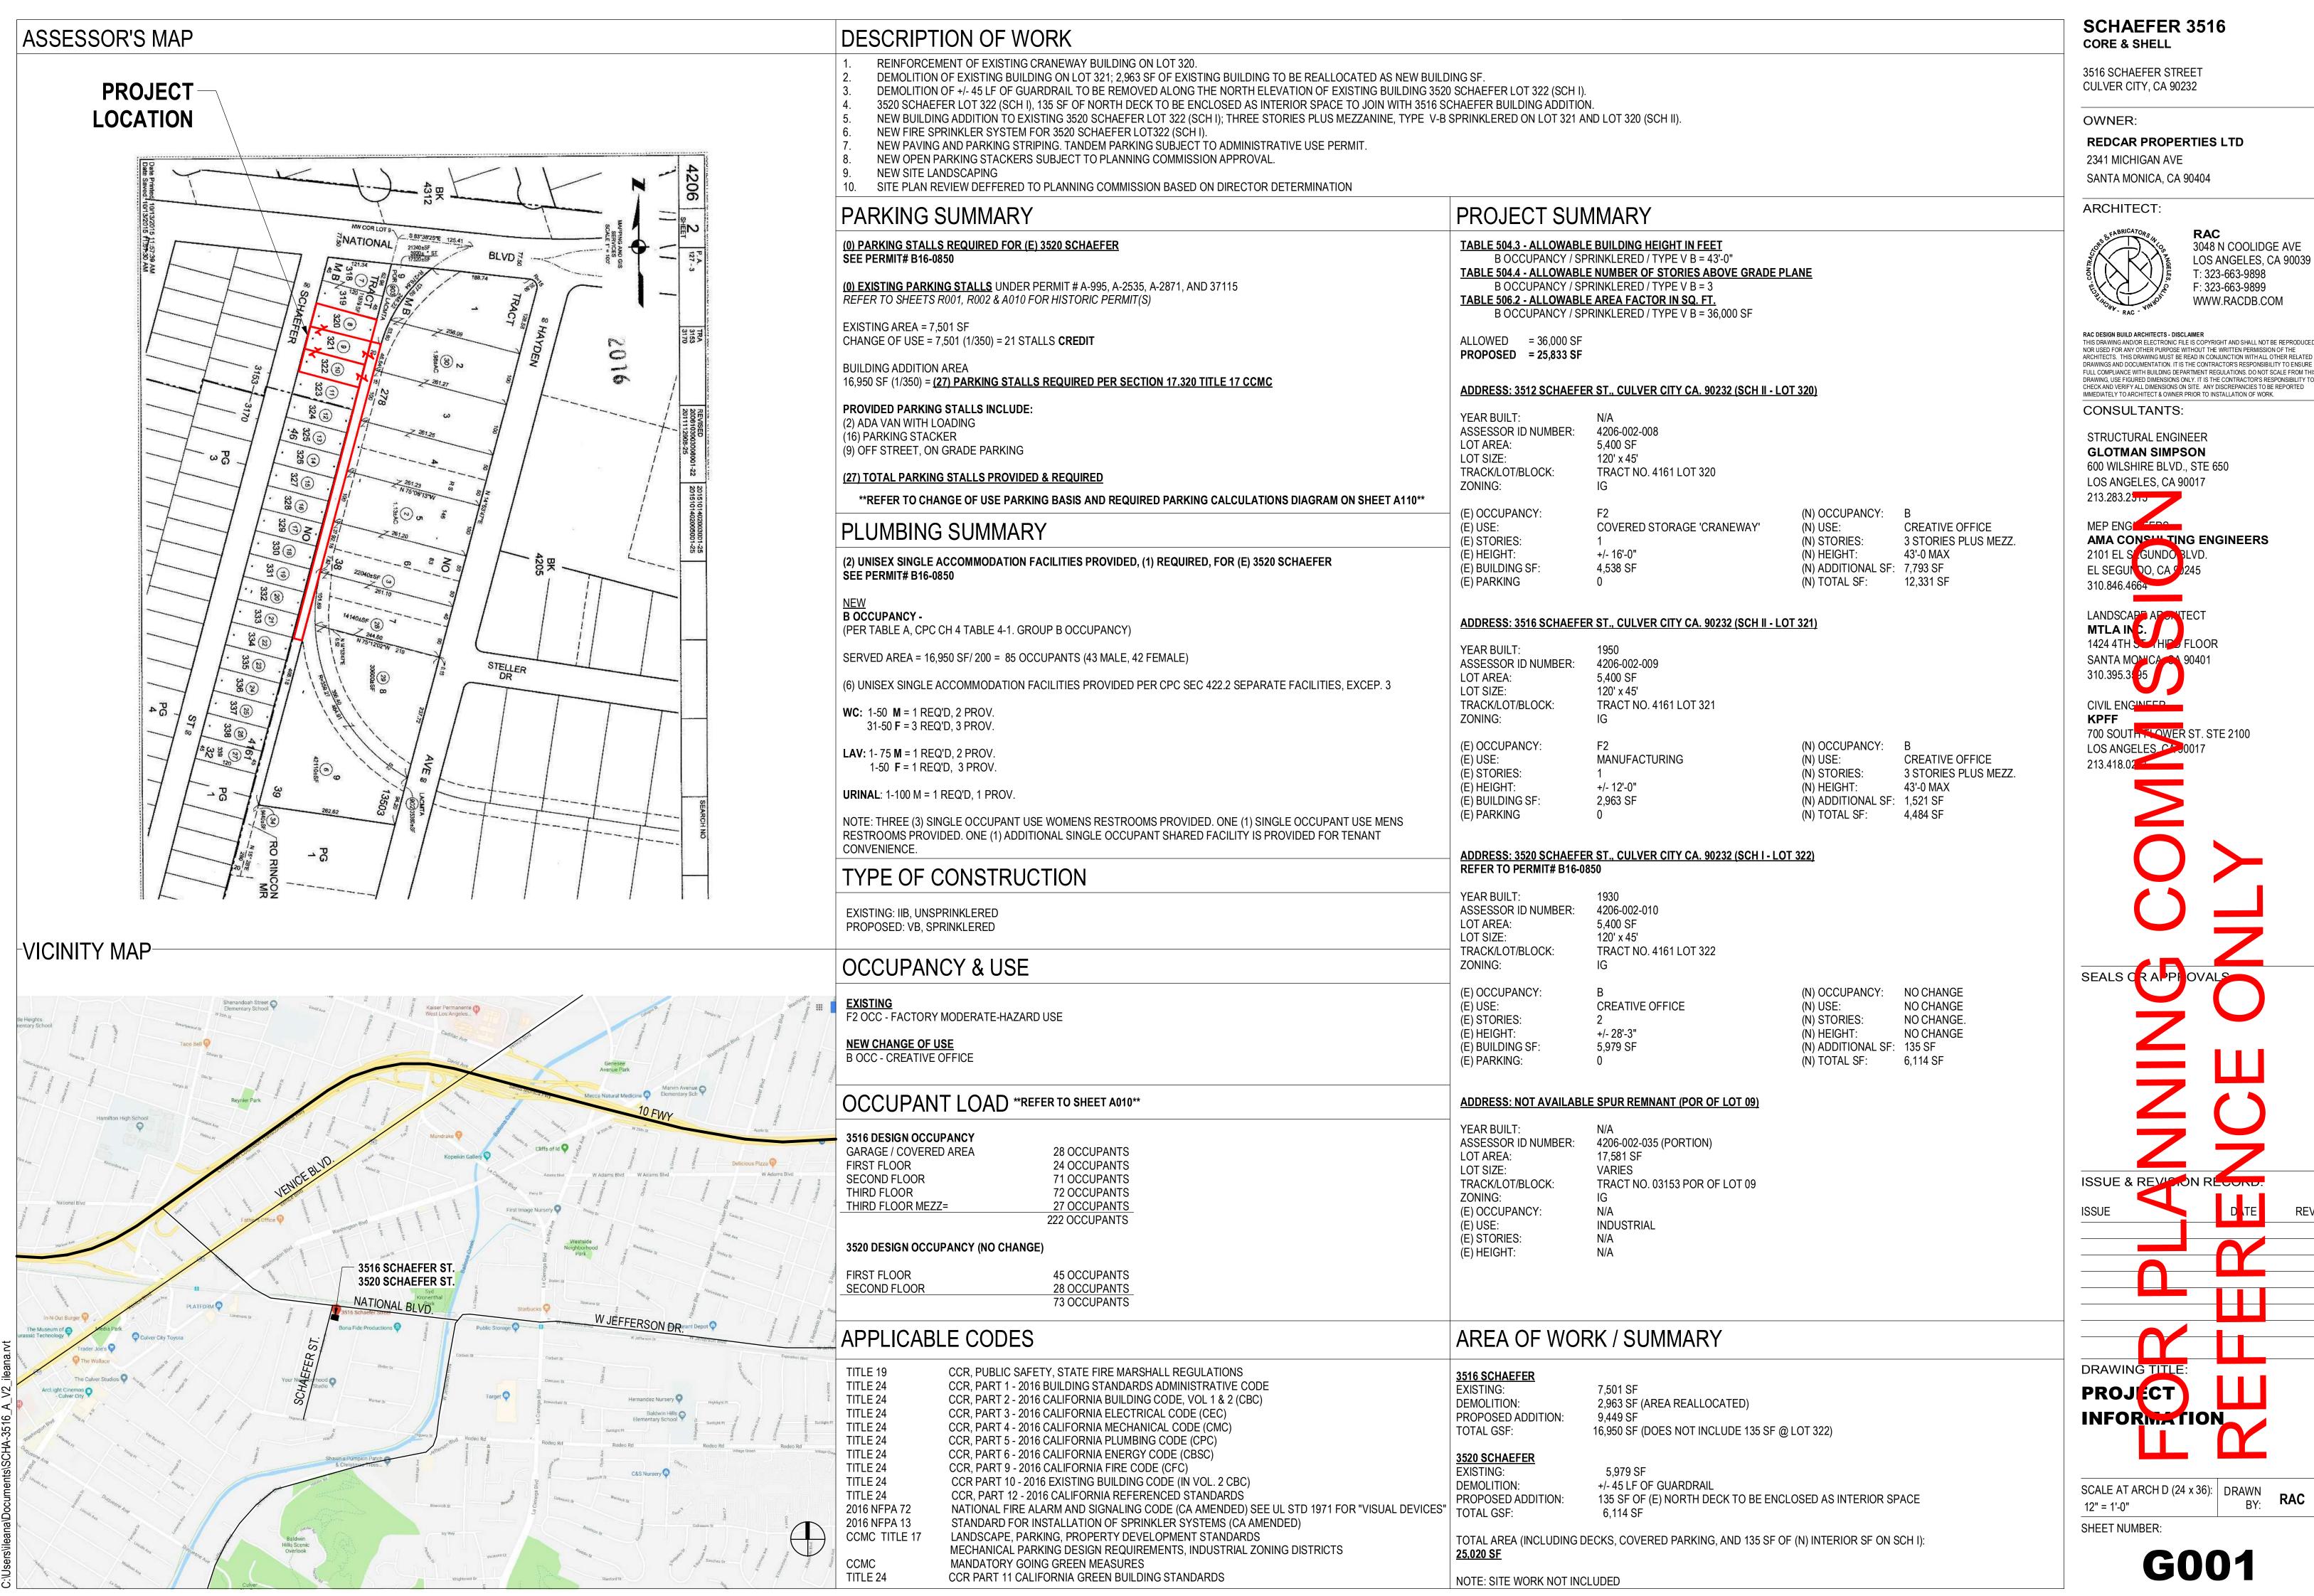

WALL TAG

INSUL. INSULATION


JOINT

TABLE 11B-228.3.2.1 ELECTRIC VEHICLE CHARGING STATIONS FOR PUBLIC USE AND COMMON USE

	MINIMUM NUMBER (BY TYPE) OF EVCS REQUIRED TO COMPLY WITH SECTION 11B-812			
TOTAL NUMVER OF EVCS AT A FACILITY	VAN ACCESSIBLE	STANDARD ACCESSIBLE	AMBULATORY	
1 TO 4	1	0	0	
5 TO 25	1	1	0	
26 TO 50	1	1	1	
51 TO 75	1	2	2	
76 TO 100	1	3	3	
101 TO OVER	1, PLUS 1 FOR EACH 300, OR FRACTION THEREOF, OVER 100	1 *	3, PLUS 1 FOR EACH 50, OR FRACTION THEREOF, OVER 100	

1. WHERE AN EV CHARGER CAN SIMULTANEOUSLY CHARGE MORE THAN ONE VEHICLE, THE NUMBER OF EVCS PROVIDED SHALL BE CONSIDERED EQUIVALENT TO THE NUMBER OF ELECTRIC VEHICLES THAT CAN BE SIMULTANEOUSLY CHARGED.

TRAFFIC WHITE ı 1' - 4" ı TYP. STENCIL PAINT DIRECTLY ON FLOOR SLAB WITH REFLECTED PAINT.

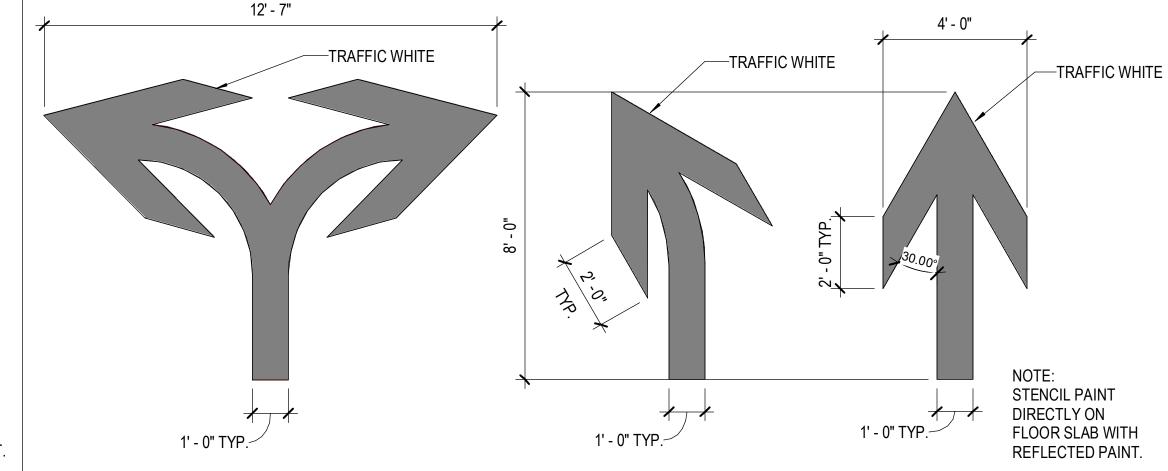


ACCESSIBLE PARKING FACILITIES ADDITIONAL SIGNAGE


AN ADDITIONAL SIGN SHALL BE POSTED EITHER; 1) IN A CONSPICUOUS PLACE AT EACH ENTRANCE TO AN OFF-STREET PARKING FACILITY OR 2) IMMEDIATELY ADJACENT TO ON-SITE ACCESSIBLE PARKING AND VISIBLE FROM EACH PARKING SPACE.

THE SIGN MUST INDICATE: "UNAUTHORIZED" VEHICLES PARKED IN DESIGNATED ACCESSIBLE SPACES NOT DISPLAYING DISTINGUISHING PLACARDS OR SPECIAL LICENSE PLATES ISSUED FOR PERSONS WITH DISABILITIES WILL BE TOWED AWAY AT THE OWNER'S EXPENSE. TOWED VEHICLES MAY BE RECLAIMED AT: ____ OR BY TELEPHONING ____."


11B-502.6 IDENTIFICATION. PARKING SPACE IDENTIFICATION SIGNS SHALL INCLUDE THE INTERNATIONAL SYMBOL OF ACCESSIBILITIY COMPLYING WITH SECTION 11B-703.7.2.1 IN WHITE ON A BLUE BACKGROUND. SIGNS IDENTIFYING VAN PARKING SPACES SHALL CONTAIN ADDITIONAL LANGUAGE OR AN ADDITIONAL SIGN WITH THE DESIGNATION "VAN ACCESSIBLE." SIGN SHALL BE 60 INCHES (1524MM) MINIMUM ABOVE THE FINISH FLOOR OR GROUND SURFACE MEASURED TO THE BOTTOM OF THE SIGN.


DSA - ADVISORY 11B-209.4 VALET PARKING. VALET PARKING DOES NOT ELIMINATE THE REQUIREMENT TO PROVIDE ACCESSIBLE PARKING SPACES. SOME VEHICLES MAY BE ADAPTED WITH HAND CONTROLS OR LACK A DRIVER'S SEAT, AND MAY NOT BE OPERABLE BY A VALET PARKING ATTENDANT. THE PARKING SPACE REQUIREMENTS OF SECTION 11B-208 AND 11B-502 APPLY TO FACILITIES WITH VALET PARKING, INCLUDING THE REQUIREMENT FOR AN ACCESSIBLE ROUTE OF TRAVEL TO THE ENTRANCE OF THE FACILITIY. IN ADDITION, WHEN VALET PARKING IS PROVIDED, A PASSENGER DROP-OFF AND LOADING ZONE COMPLYING WITH SECTION 11B-503 SHALL BE LOCATED ON AN ACCESSIBLE ROUTE OF TRAVEL TO THE ENTRANCE OF THE FACILITY.

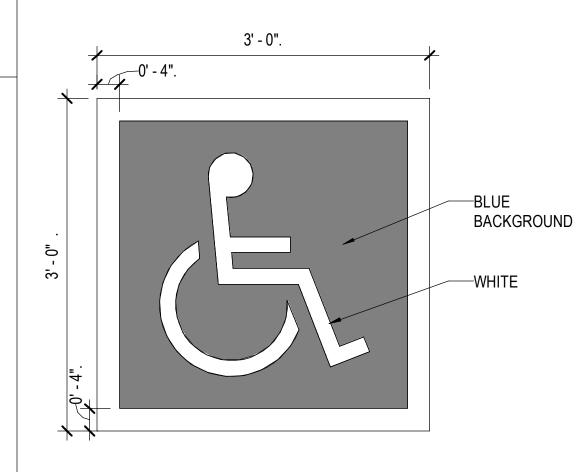


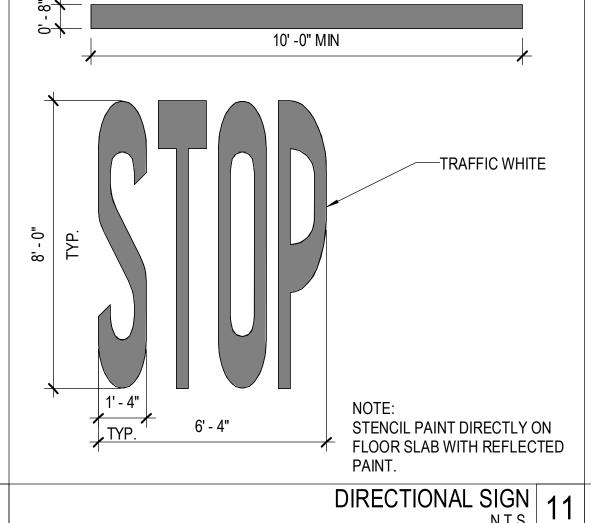



DIRECTIONAL SIGN N.T.S. 12

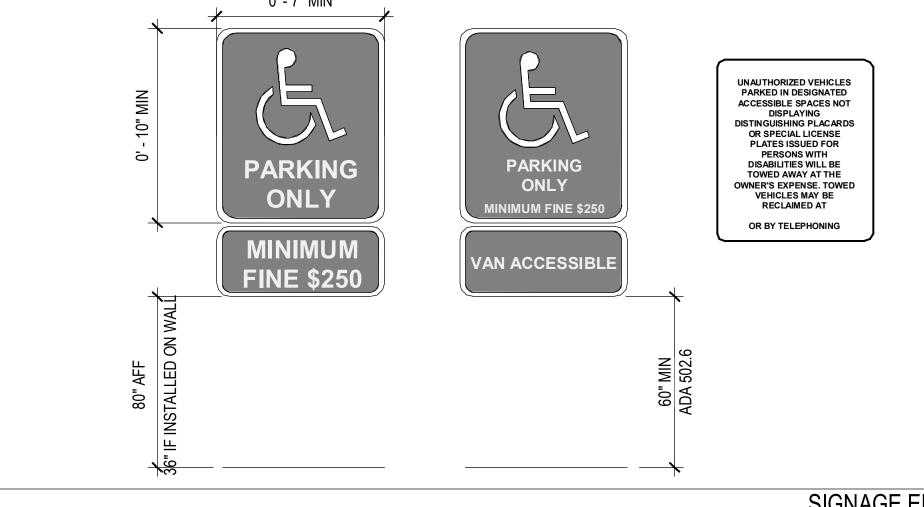


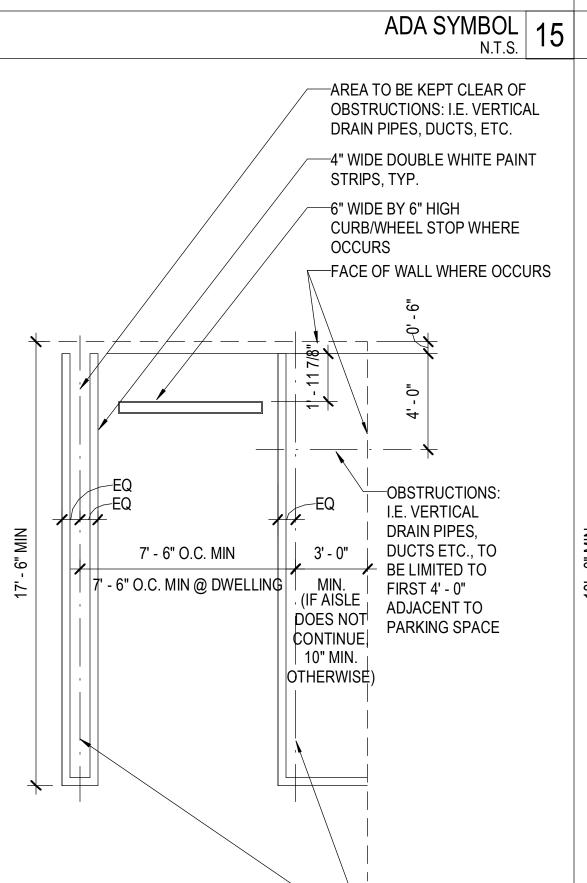

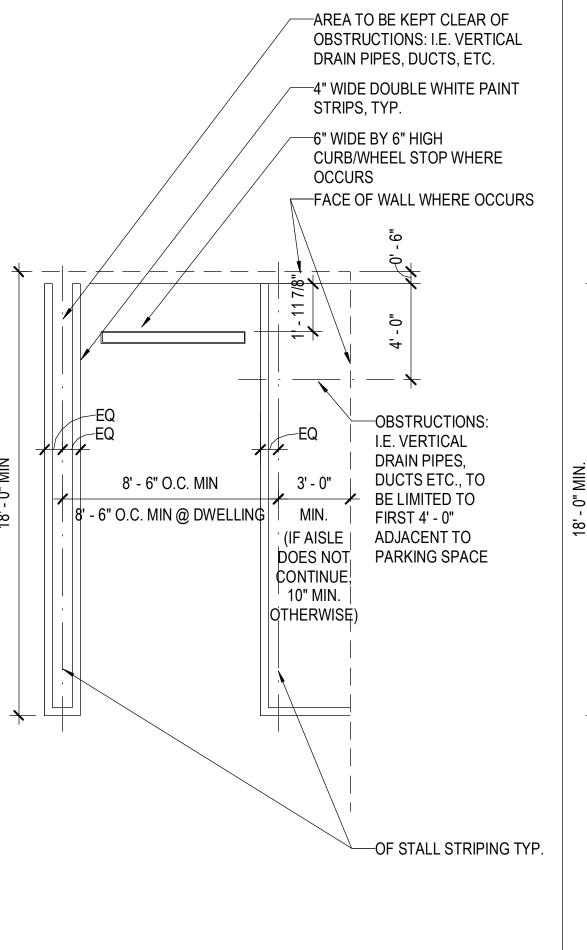

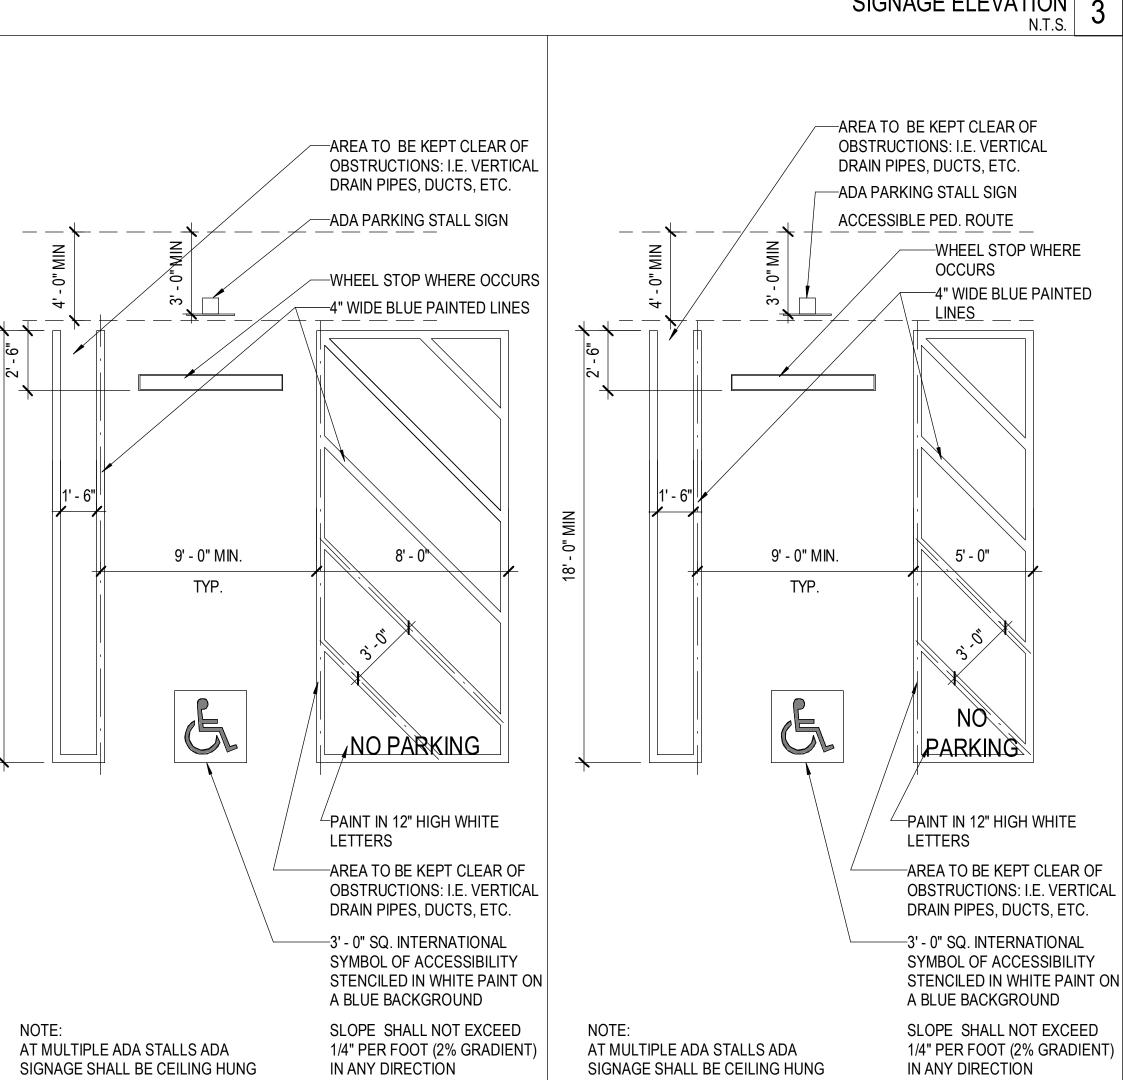

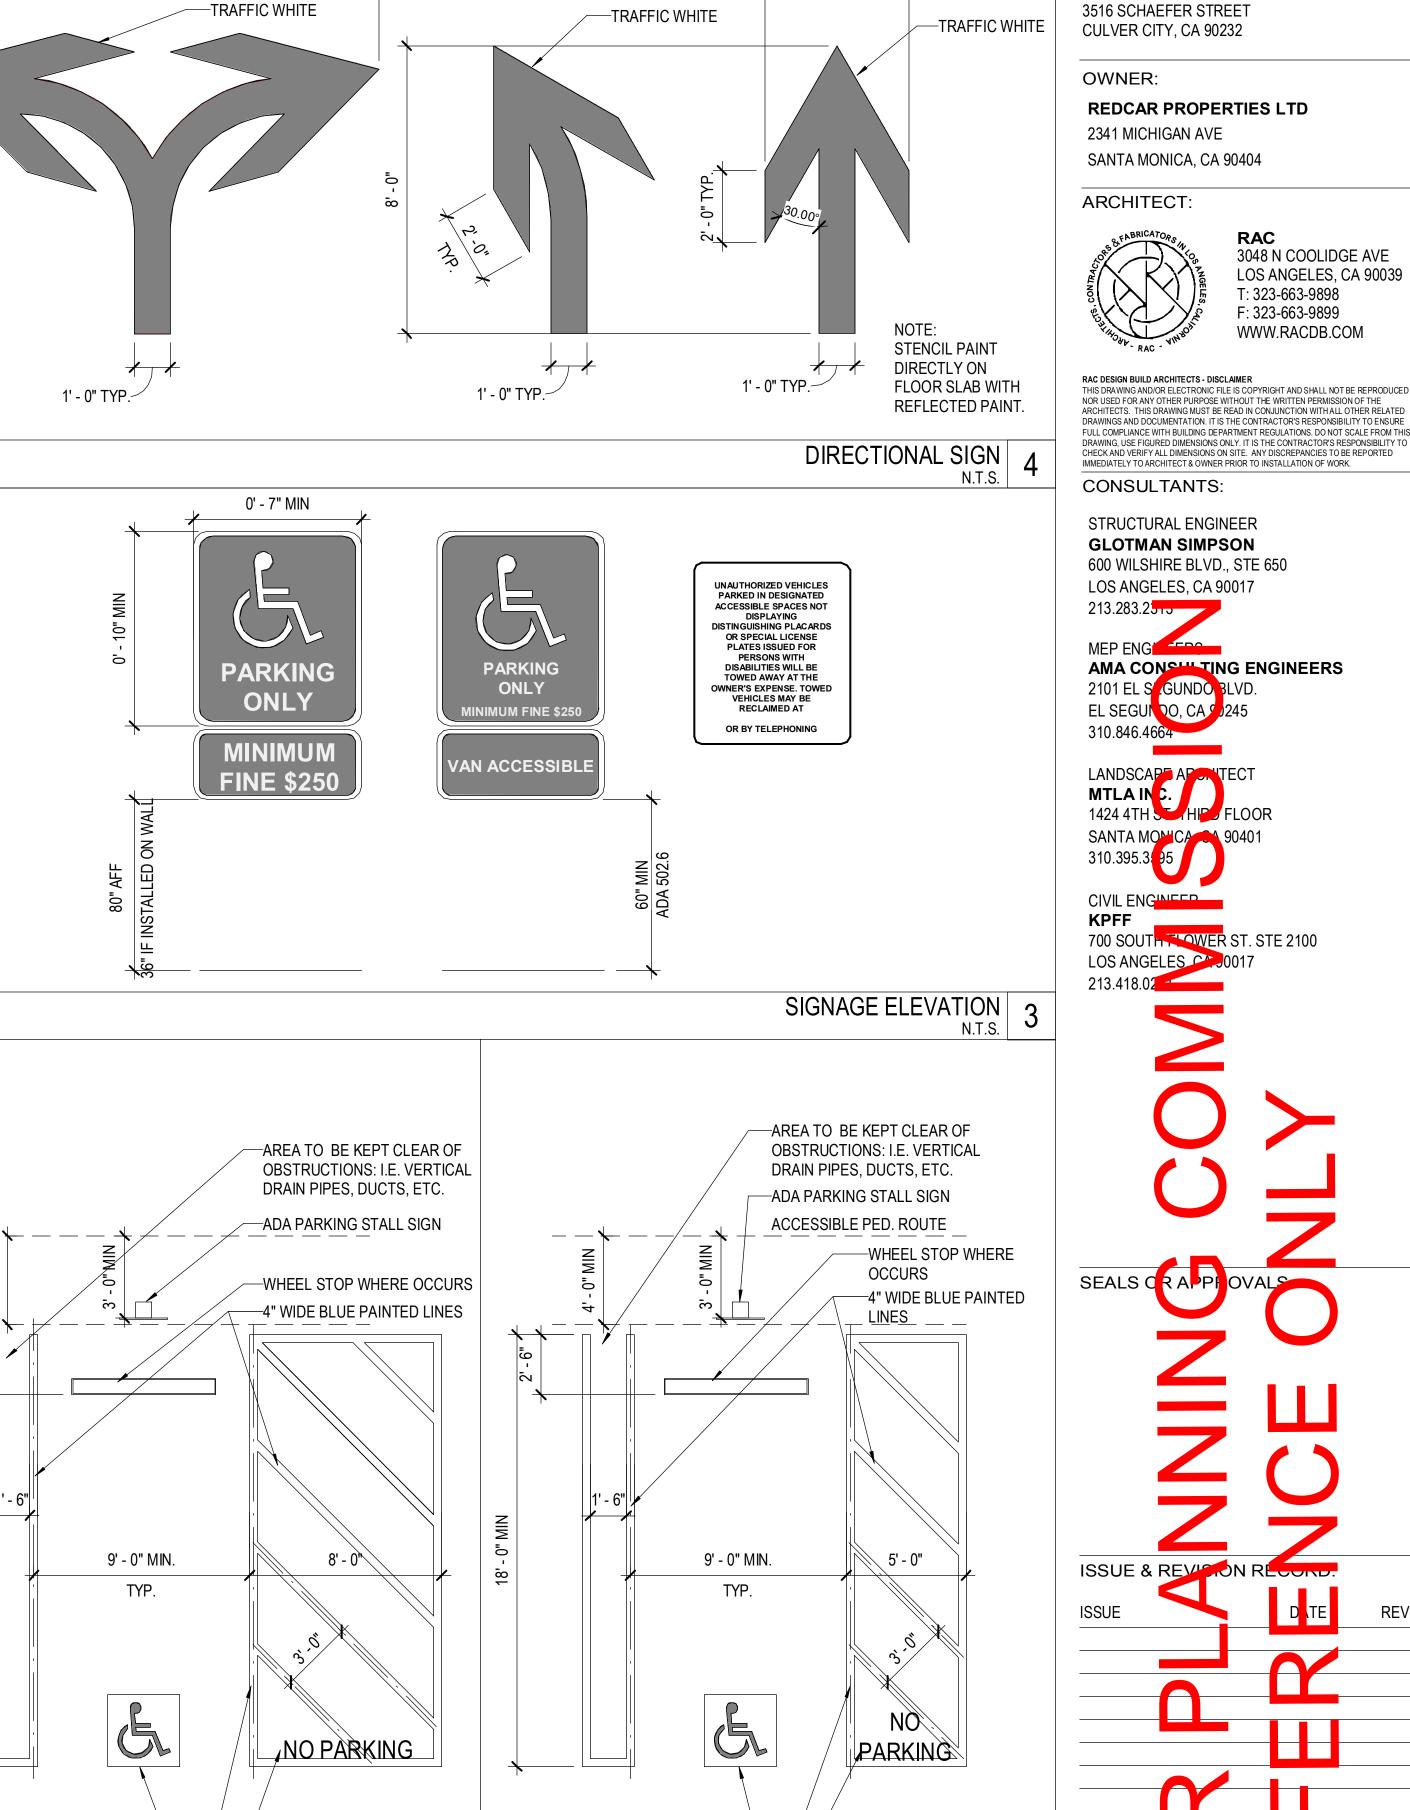

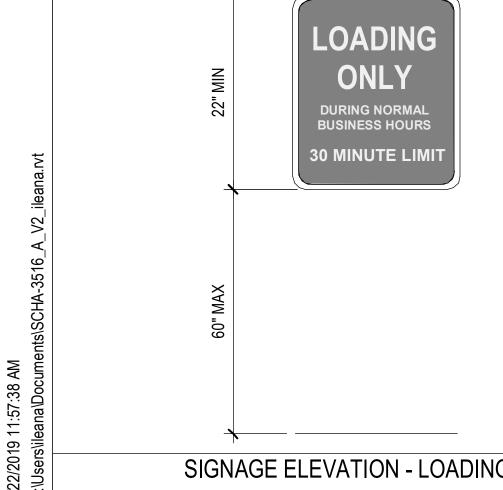

SIGNAGE ELEVATION - LOADING ONLY 3" = 1'-0"

17" MIN

TYPICAL COMPACT STALL 13 TYPICAL STANDARD STALL 9

OF STALL STRIPING TYP.

VAN PARKING STALL STRIPING 5

ADA PARKING STALL STRIPING

SLOPE SHALL NOT EXCEED 1/4" PER FOOT (2% GRADIENT)

SHEET NUMBER:

SCALE AT ARCH D (24 x 36): DRAWN

CULVER CITY PARKING

DRAWING TITLE:

NOTES

As indicated

SCHAEFER 3516

LOS ANGELES, CA 90039

T: 323-663-9898

WWW.RACDB.COM

CORE & SHELL

BUILDING SAFETY DIVISION

Culver City Building Safety Division Mandatory Green Building Program

Category 1 Qualifying Projects

All new construction, new additions, and major renovations in Culver City up to 49,999 square feet of affected area are required to comply with Category 1 requirements, excluding single family and two family structures.

Major renovations are defined as a project construction valuation of 50% or greater of the value of the existing building or affected portion of a building.

The value of an existing building is defined as the Los Angeles County Assessor's Office value of the existing structure not including the land, or the value listed on a recent certified appraisal.

The construction valuation is as defined by the permit applicant on the construction permit, application, or at a minimum as defined by the most current Culver City Building Safety Minimum S.F. Costs Guide.

Category 1 qualifying projects must comply with 80% of the <u>applicable</u> following items. The project applicant shall submit this checklist with the construction permit application drawings and all items checked must be indicated in the construction permit application drawings.

✓ 1. Heating, ventilating and air conditioning (HVAC) units shall have a minimum seasonal energy efficiency rating (SEER) of 17.

☐ 2. Gas heating units shall be a minimum of 93% energy efficient. NOT APPLICABLE

☑ 3. All heating and cooling ducts shall be located within the space to be heated or cooled.

☐ 4. Roof and floor structures abutting an exterior space shall be a minimum of R-38 (thermal resistance value), and all exterior walls shall be a minimum value of R-28.

CRAIG JOHNSON, RA, GC, CBO, BUILDING OFFICIAL BUILDING SAFETY DIVISION TEL 310-253-5800 FAX 310-253-5824 Past President of the ICC Los Angeles Basin Chapter

9770 CULVER BOULEVARD, CULVER CITY, C.A., 90232-0507 www.culvercity.org

- ☐ 5. Radiant barriers shall be installed under all new roof sheathing.
- ☑ 6. All new exterior glass shall be a minimum value of U .35 (measure of heat conducting properties) and a minimum value of .30 SHGC (solar heat gain coefficient).
- ✓ 7. Low slope roofs shall be a minimum value of 75% SRI (solar reflectance index).
- ✓ 8. Exterior shading shall be provided over all west, south, and east facing glass. Where exterior shading is infeasible all new exterior glass shall be a minimum value of U .32 and a minimum value of .27 SHGC.
- ☑ 9. All new interior and exterior lighting shall be fluorescent, LED, or other type of high efficiency lighting.

- 12. All new lighting installed in a garage or parking structure shall be motion sensor controlled. Minimum base level lighting shall be permitted.
- ✓ 13. All new or replaced water closets shall be dual flush models.
- 14. All new or replaced urinals shall be waterless models.
- ☐ 15. Water heating units installed residential units shall be gas tankless models.NOT APPLICABLE
- 16. Two- 2" electrical conduits shall be installed from the roof to the electrical panels for future solar photovoltaic installation for each unit in residential and commercial buildings. (Qualifying projects that are subject to the Culver City Mandatory Solar Photovoltaic Requirement may not use this item toward satisfying the requirements of this section.)
- 17. A 20 square feet area to house recyclable material containers shall be provided.

 This requirement shall be in addition to any CCMC requirements related to solid waste and recyclable material containers.
- ☐ 18. Multistory buildings shall provide separate trash chutes for recyclable and non-recyclable materials and waste. Such chutes shall discharge directly into separate recyclable and non-recyclable materials waste containers. This requirement shall be in addition to any other CCMC requirements related to trash chutes.

CRAIG JOHNSON, RA, GC, CBO, BUILDING OFFICIAL
BUILDING SAFETY DIVISION TEL 310-253-5800 FAX 310-253-5824
Past President of the ICC Los Angeles Basin Chapter

9770 CULVER BOULEVARD, CULVER CITY, C.A., 90232-0507 www.culvercity.org

✓ 19. One duplex weatherproof (WP) ground fault circuit interrupter (GFCI) outlet shall be installed for every eight new parking spaces; to be utilized for future electric "plug-in" vehicles.

✓ 21. Any new on-site, ground level paving, which is open to the sky shall be permeable.

 \square 23. All wood floor and roof structures shall be constructed with 90% engineered lumber.

☐ 24. A minimum of 50% of the overall building insulation shall be formaldehyde free and recycled content. A minimum aggregate of 60% of the wall, ceiling, and floor insulation shall be cellulose, cotton ball, or bio-based foam.

> CRAIG JOHNSON, RA, GC, CBO, BUILDING OFFICIAL BUILDING SAFETY DIVISION TEL 310-253-5800 FAX 310-253-5824 Past President of the ICC Los Angeles Basin Chapter

PLUMBING FIXTURE FLOW RATES

(2017 Los Angeles Green Building Code) Non-Residential Occupancies

SECTION 5.303.2 WATER REDUCTION FIXTURE FLOW RATES

FIXTURE TYPE	MAXIMUM ALLOWABLE FLOW RATE		
Showerheads	1.8 gpm @ 80 psi		
Lavatory faucets, residential	1.2 gpm @ 60 psi ^{1,3}		
Lavatory Faucets, nonresidential	0.4 gpm @ 60 psi ^{1,3}		
Kitchen faucets	1.5 gpm @ 60 psi ^{2,4,5}		
Wash fountains	1.8 gpm for every 20 in. of rim space @60 psi		
Metering faucets	0.2 gallons/cycle		
Metering faucets for wash fountains	0.2 gpm for every 20 in. of rim space @ 60 psi		
Gravity tank type water closets	1.28 gallons/flush ⁶		
Flushometer tank water closets	1.28 gallons/flush ⁶		
Flushometer valve water closets	1.28 gallons/flush ⁶		
Urinals	0.125 gallons/flush		
Clothes Washers	ENERGY-STAR certified		
Dishwashers	ENERGY-STAR certified		

- ¹ Lavatory faucets shall not have a flow rate less than 0.8 gpm at 20 psi.
- ² Kitchen faucets may temporarily increase flow above the maximum rate, but not above 2.2gpm @ 60psi
- and must default to a maximum flow rate of 1.8 gpm @ 60psi.
- ³Where complying faucets are unavailable, aerators or other means may be used to achieve reduction. ⁴Kitchen faucets with a maximum 1.8 gpm flow rate may be installed in buildings that have water closets
- with a maximum flush rate of 1.06 gallons/flush installed throughout ⁵ This requirement does not apply to faucets in commercial kitchens.
- ⁶ Includes single and dual flush water closets with an effective flush of 1.28 gallons or less.
- Single Flush Toilets The effective flush volume shall not exceed 1.28 gallons (4.8 liters). The effective flush volume is the average flush volume when tested in accordance with ASME A112.19.233.2.
- Dual Flush Toilets The effective flush volume shall not exceed 1.28 gallons (4.8 liters). The effective flush volume is defined as the composite, average flush volume of two reduced flushes and one full flush. Flush volumes will be tested in accordance with ASME A112.19.2 and ASME A112.19.14.

VOC AND FORMALDEHYDE LIMITS

PRODUCT	CURRENT
Hardwood plywood veneer core	0.05
Hardwood plywood composite core	0.05
Particleboard	0.09
Medium density fiberboard	0.11
Thin medium density fiberhoard ²	0.13

Values in this table are derived from those specified by the California Air Resources Board, Air Toxics Control Measure for Composite Wood as tested in accordance with ASTM E 1333. For additional information, see California Code of Regulations, Title 17, Sections 93120 through 93120.12.

Thin medium density fiberboard has a maximum thickness of 5/150 inches (8 mm).

voc content limits for architectural coating. Grams of VOC per Liter of Coating.

COATING CATEGORY ^{2,3}	CURRENT LIMIT
Flat coatings	50
Nonflat coatings	100
Nonflat-high gloss coatings	150
Specialty Coatings	
Aluminum roof coatings	400
Basement specialty coatings	400
Bituminous roof coatings	50
Bituminous roof primers	350
Bond breakers	350
Concrete curing compounds	350
Concrete/masonry sealers	100
Driveway sealers	50
Dry fog coatings	150
Faux finishing coatings	350
Fire resistive coatings	350
Floor coatings	100
Form-release compounds	250
Graphic arts coatings (sign paints)	500
High temperature coatings	420
Industrial maintenance coatings	250
Low solids coatings	120
Magnesite cement coatings	450
Mastic texture coatings	100
Metallic pigmented coatings	500
Multicolor coatings	250
Pretreatment wash primers	420
Primers, sealers, and undercoaters	100
Reactive penetrating sealers	350
Recycled coatings	250
Roof coatings	50
Rust preventative coatings	250
Shellacs	
Clear	730
Opaque	550
Specialty primers, sealers and undercoaters	100
Stains	250
Stone consolidants	450
Swimming pool coatings	340
Traffic marking coatings	100
Tub and tile refinish coatings	420
Waterproofing membranes	250
Wood coatings	275
Wood preservatives	350
Zinc-rich primers ams of VOC per liter of coating, including water and including	340

Values in this table are derived from those specified by the California Air Resources Board

SEALANT VOC LIMIT
Less Water and Less Exempt Compounds in Grams per Liter
SEALANTS
CURRENT VOC LIMIT
Lectural
L

| All Price | All

tables, see South Coast Air Quality Management District Rule 1168

ADHESIVE VOC LIMIT 1.2

Less Water and Less Exempt Compounds in Grams per Liter

ARCHITECTURAL APPLICATIONS CURRENT VOC LIMIT

Indoor carpet adhesives 50

Carpet pad adhesives 150

Nood flooring adhesive 100

Rubber floor adhesives 60

Subfloor adhesives 50

Ceramic tile adhesives 65

VCT and asphalt tile adhesives 50

Drywall and panel adhesives 50

(2017 Los Angeles Green Building Code)

see South Coast Air Quality Management District Rule 1168, http://www.arb.ca.gov/DRDB/SC/CURHTML/R1168.PDF.

STORM WATER POLLUTION CONTROL

(2017 Los Angeles Green Building Code)
Storm Water Pollution Control Requirements for Construction Activities
Minimum Water Quality Protection Requirements for All Construction Projects

The following notes shall be incorporated in the approved set of construction/grading plans and represents the minimum standards of good housekeeping which must be implemented on all construction projects.

Construction means constructing, clearing, grading or excavation that result in soil disturbance. Construction includes structure teardown (demolition). It does not include routine maintenance to maintain riginal line and grade, hydraulic capacity, or original purpose of facility; emergency construction activities required to immediately protect public health and safety; interior remodeling with no outside exposure of construction material or construction waste to storm water; mechanical permit work; or sign permit work.

(Order No. 01-182, NPDES Permit No. CAS004001 – Part 5: Definitions)

1. Eroded sediments and pollutants shall be retained on site and shall not be transported from the site via sheet flow, swales, area drains, natural drainage or wind.

2. Stockpiles of earth and other construction-related materials shall be covered and/or protected from being transported from the site by wind or water.

3. Fuels, oils, solvents and other toxic materials must be stored in accordance with their listing and shall not contaminate the soil nor the surface waters. All approved toxic storage containers are to be protected from the weather. Spills must be cleaned up immediately and disposed of properly and shall not be washed into the drainage system.

4. Non-storm water runoff from equipment and vehicle washing and any other activity shall be contained on the project site.

5. Excess or waste concrete may not be washed into the public way or any drainage system. Provisions shall be made to retain concrete waste on-site until it can be appropriately disposed of or recycled.

6. Trash and construction –related solid wastes must be deposited into a covered receptacle to prevent contamination of storm water and dispersal by wind.

7. Sediments and other materials shall not be tracked from the site by vehicle traffic. The construction entrance roadways must be stabilized so as to inhibit sediments from being deposited into the street/public ways. Accidental depositions must be swept up immediately and may not be washed down by rain or by any other means.

8. Retention basins of sufficient size shall be provided to retain storm water runoff on-site and shall be properly located to collect all tributary site runoff.

9. Where retention of storm water runoff on-site is not feasible due to site constraints, runoff may be conveyed to the street and the storm drain system provided that an approved filtering system is installed and maintained on-site during the construction duration.

As a covered entity under Title II of the Americans with Disabilities Act, the City of Los Angeles does not discriminate on the basis of disability and, up on request, will provide reasonable accommodation to ensure equal access to its programs, services and activities.

(Rev. 01/17/17)

SCHAEFER 3516 CORE & SHELL

3516 SCHAEFER STREET CULVER CITY, CA 90232

OWNER:

REDCAR PROPERTIES LTD
2341 MICHIGAN AVE
SANTA MONICA, CA 90404

ARCHITECT:



3048 N COOLIDGE AVE LOS ANGELES, CA 90039 T: 323-663-9898 F: 323-663-9899 WWW.RACDB.COM

RAC DESIGN BUILD ARCHITECTS - DISCLAIMER

THIS DRAWING AND/OR ELECTRONIC FILE IS COPYRIGHT AND SHALL NOT BE REPRODUCED NOR USED FOR ANY OTHER PURPOSE WITHOUT THE WRITTEN PERMISSION OF THE ARCHITECTS. THIS DRAWING MUST BE READ IN CONJUNCTION WITH ALL OTHER RELATED DRAWINGS AND DOCUMENTATION. IT IS THE CONTRACTOR'S RESPONSIBILITY TO ENSURE FULL COMPLIANCE WITH BUILDING DEPARTMENT REGULATIONS. DO NOT SCALE FROM THIS DRAWING, USE FIGURED DIMENSIONS ONLY. IT IS THE CONTRACTOR'S RESPONSIBILITY TO CHECK AND VERIFY ALL DIMENSIONS ON SITE. ANY DISCREPANCIES TO BE REPORTED

IMMEDIATELY TO ARCHITECT & OWNER PRIOR TO INSTALLATION OF WORK

CONSULTANTS:

STRUCTURAL ENGINEER
GLOTMAN SIMPSON
600 WILSHIRE BLVD., STE 650
LOS ANGELES, CA 90017
213.283.2513

MEP ENGINEERS

AMA CONSULTING ENGINEERS

2101 EL SEGUI DO, CA 20245

310.846.4664

LANDSCAPE APOINTECT
MTLA IN C.
1424 4TH SEA HIP FLOOR
SANTA MONICA CA 90401
310.395.3.95

SEALS OR APPLOVALS

EALS OR APPHOVALS

ISSUE & REVISION RECORD.

ISSUE DITE

SUE DITE

DRAWING TITLE:


CULVER CITY GREEN
BUILDING NOTES

SCALE AT ARCH D (24 x 36): DRAWN

BY: Designer

SHEET NUMBER:


G040

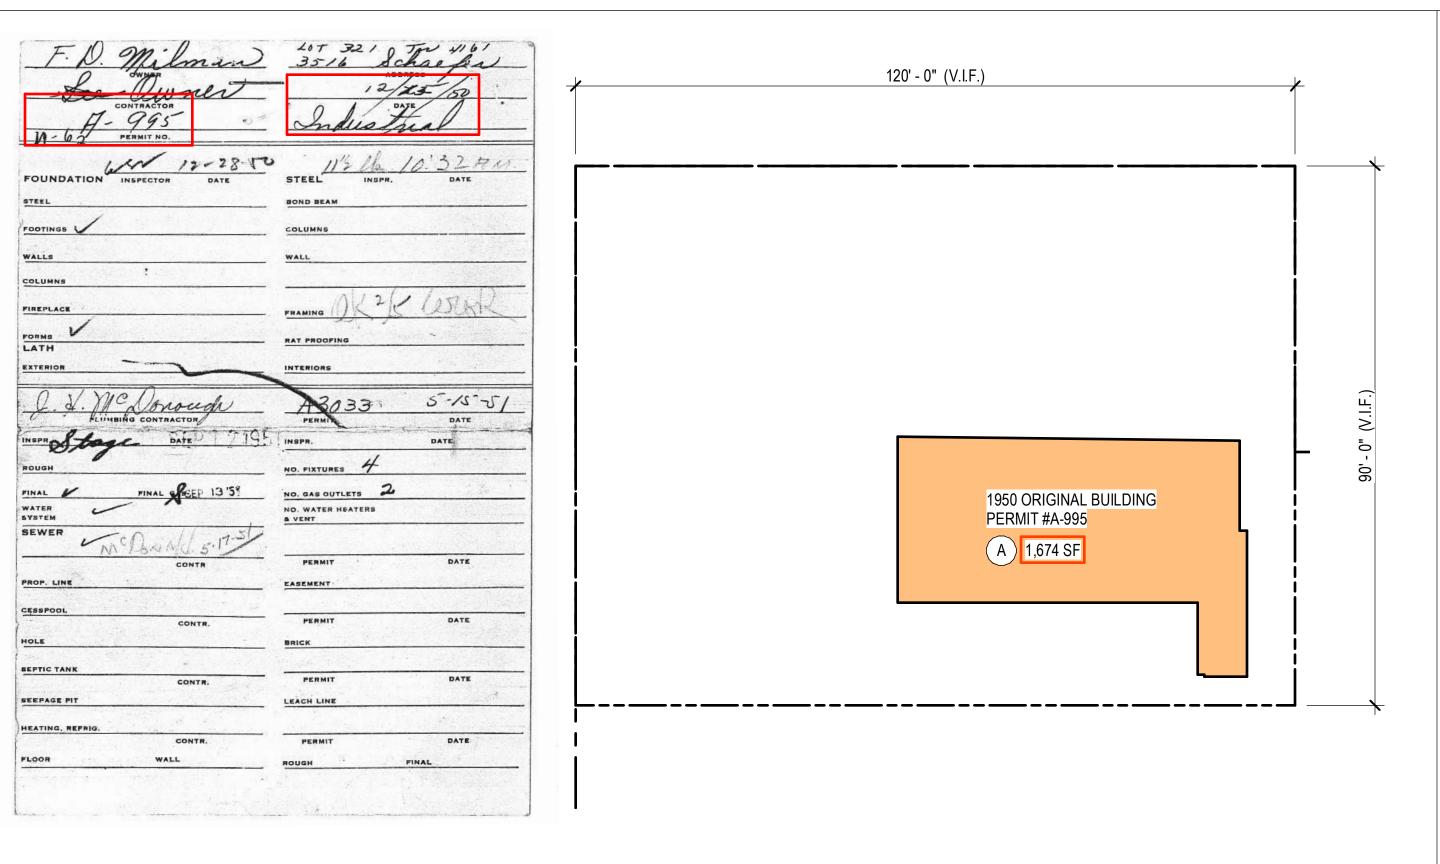

1950 ORIGINAL BUILDING PERMIT # A-995 **NEW CONSTRUCTION**

USE: INDUSTRIAL 1,674 TOTAL SF

REQ'D PARKING: <u>0 STALLS</u>

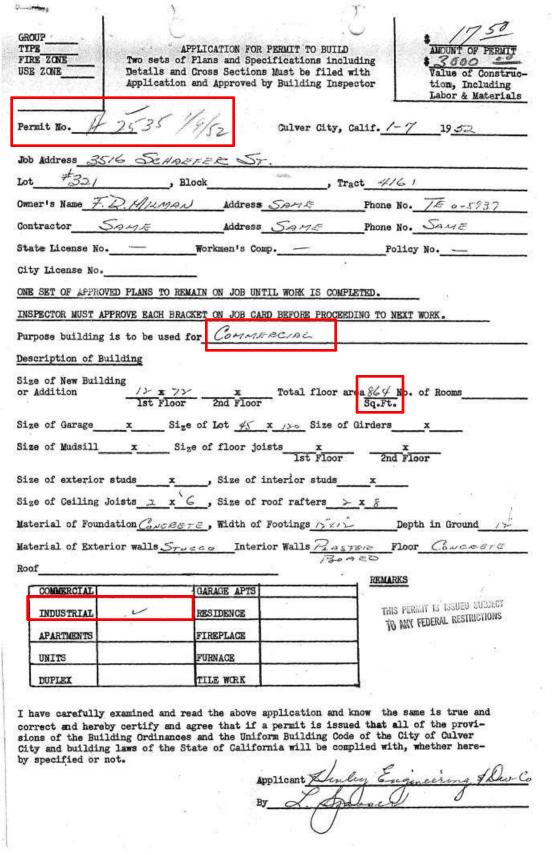

1952 BUILDING PERMIT # A-2535 ADDITION

USE: COMMERCIAL / INDUSTRIAL (A)1,674 + (B.1) 864 = 2,538 TOTAL SF

COMMERCIAL / INDUSTRIAL


(A)1,674 + (B.1) 864 + (B.2) 425 = 2,963 TOTAL SF

REQ'D PARKING: 0 STALLS


USE:

AREA:

REQ'D PARKING: 0 STALLS

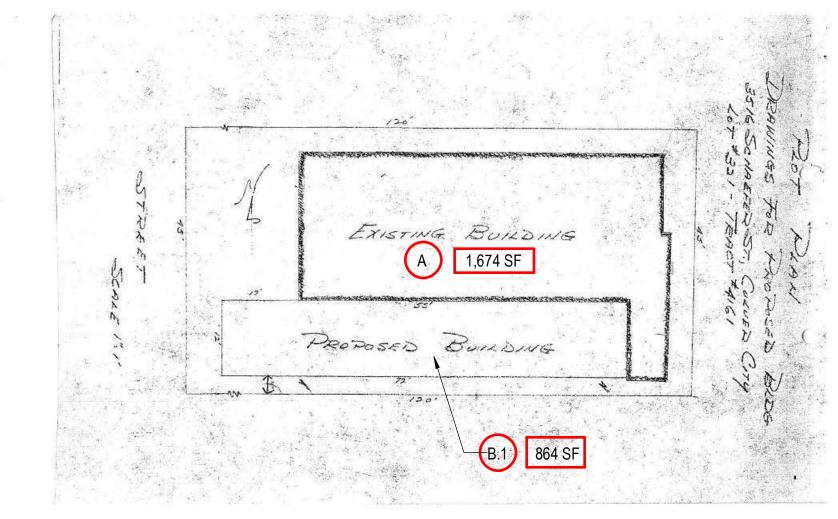

PLOT PLAN FOR BUILDING PERMIT A-2535

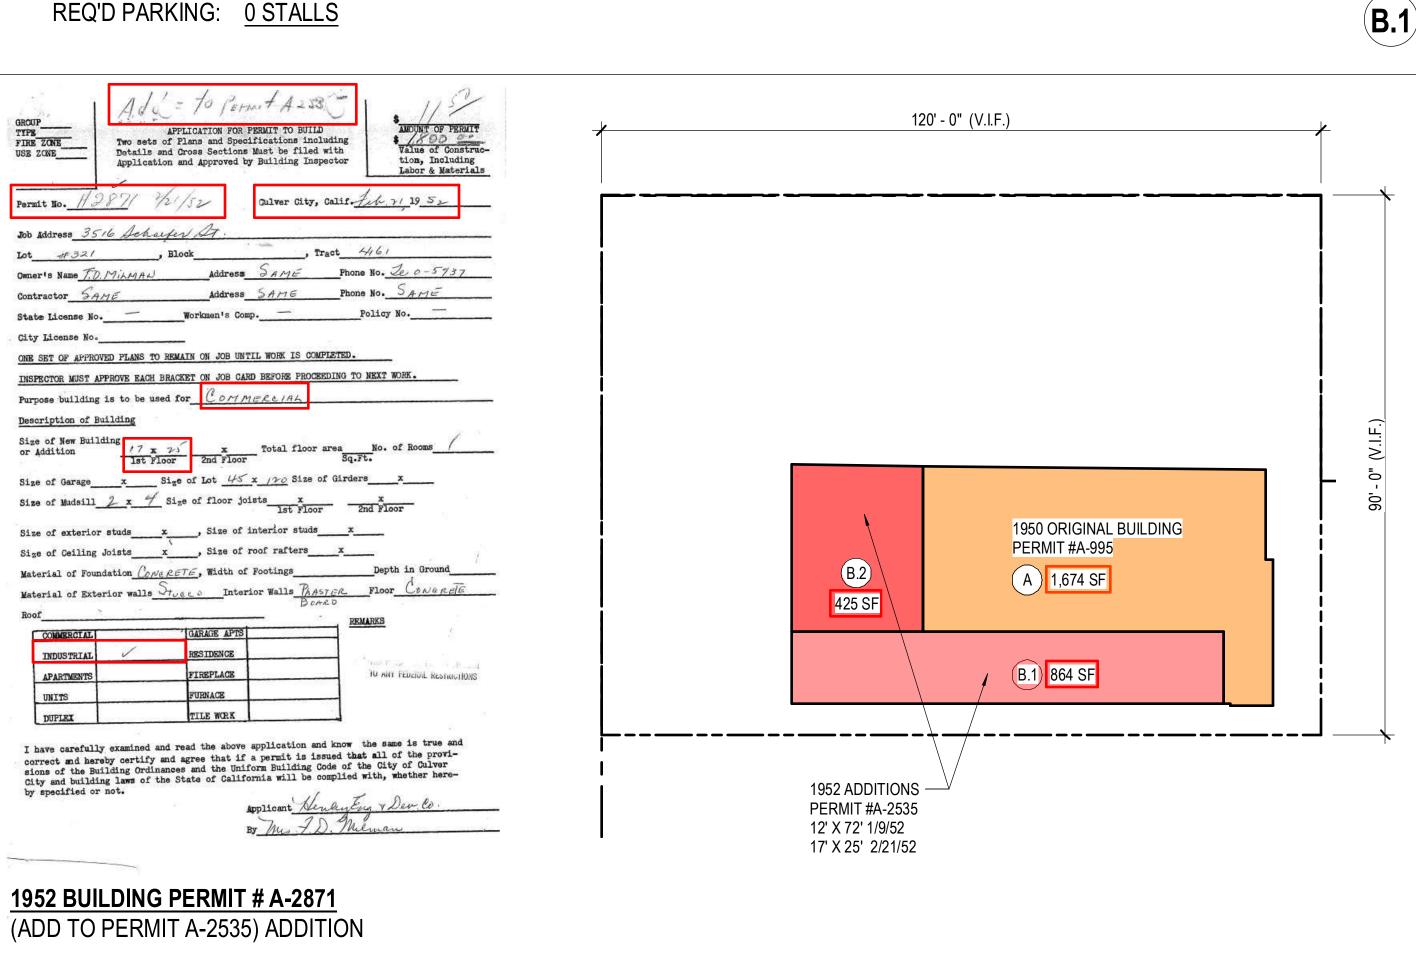

SCHAEFER 3516 CORE & SHELL

> 3516 SCHAEFER STREET CULVER CITY, CA 90232

OWNER: **REDCAR PROPERTIES LTD** 2341 MICHIGAN AVE

SANTA MONICA, CA 90404

ARCHITECT:



LOS ANGELES, CA 90039 T: 323-663-9898 F: 323-663-9899 WWW.RACDB.COM

RAC DESIGN BUILD ARCHITECTS - DISCLAIMER THIS DRAWING AND/OR ELECTRONIC FILE IS COPYRIGHT AND SHALL NOT BE REPRODUCED NOR USED FOR ANY OTHER PURPOSE WITHOUT THE WRITTEN PERMISSION OF THE ARCHITECTS. THIS DRAWING MUST BE READ IN CONJUNCTION WITH ALL OTHER RELATED DRAWINGS AND DOCUMENTATION. IT IS THE CONTRACTOR'S RESPONSIBILITY TO ENSURE FULL COMPLIANCE WITH BUILDING DEPARTMENT REGULATIONS. DO NOT SCALE FROM THIS DRAWING, USE FIGURED DIMENSIONS ONLY. IT IS THE CONTRACTOR'S RESPONSIBILITY TO CHECK AND VERIFY ALL DIMENSIONS ON SITE. ANY DISCREPANCIES TO BE REPORTED IMMEDIATELY TO ARCHITECT & OWNER PRIOR TO INSTALLATION OF WORK

CONSULTANTS:

STRUCTURAL ENGINEER **GLOTMAN SIMPSON** 600 WILSHIRE BLVD., STE 650 LOS ANGELES, CA 90017

213.283.2513 MEP ENG AMA CONSTITUTING ENGINEERS 2101 EL S. GUNDO BLVD. EL SEGUI DO, CA 90245

LANDSCAPE APPLITECT

310.395.3 CIVIL ENGINEED


700 SOUTH TOWER ST. STE 2100 LOS ANGELES C 30017

DRAWING TITLE

SCALE AT ARCH D (24 x 36): DRAWN 1/16" = 1'-0"

SHEET NUMBER:

HISTORIC PERMITS

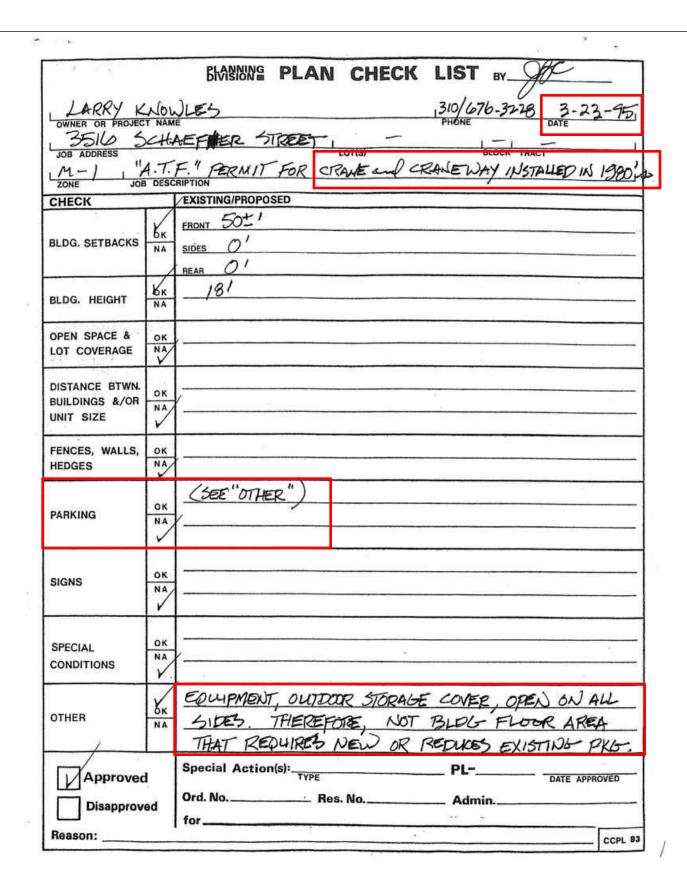


1995 PLAN CHECKLIST

USE: AREA:

SEE ABOVE (D) 4,538 TOTAL SF

REQ'D PARKING:

BUILDING FLOOR AREA DOES NOT REQUIRE NEW PARKING AND DOES NOT REDUCE EXISTING PARKING

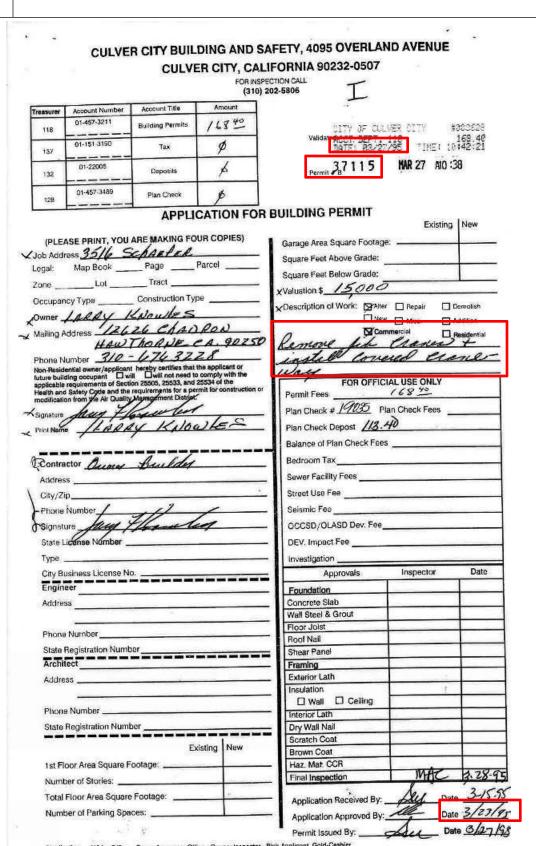

1964 BUILDING PERMIT # A-12938

MANUFACTURING / OFFICE

NO CHANGE


INTERIOR PARTITIONS

REQ'D PARKING: 0 STALLS

USE:

1995 COVERED CRANEWAY PERMIT #37115

D

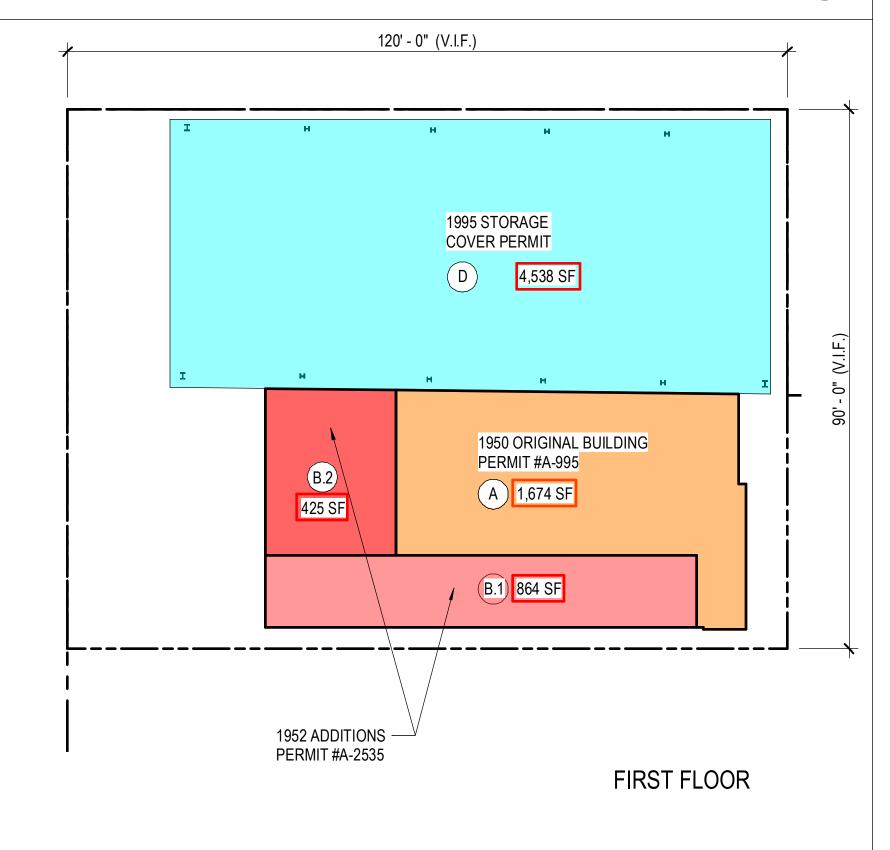

TOTAL PARKING REQUIRED = 0

SUMMARY OF EXISTING PERMITTED BLDGS

AREA: (A)1,674 + (B.1) 864 + (B.2) 425 + (D)4,538 = 7,501 TOTAL SF

HISTORIC PERMITS

SCHAEFER 3516 CORE & SHELL

3516 SCHAEFER STREET CULVER CITY, CA 90232

OWNER:

REDCAR PROPERTIES LTD 2341 MICHIGAN AVE

SANTA MONICA, CA 90404

ARCHITECT:



3048 N COOLIDGE AVE LOS ANGELES, CA 90039 T: 323-663-9898 F: 323-663-9899 WWW.RACDB.COM

RAC DESIGN BUILD ARCHITECTS - DISCLAIMER THIS DRAWING AND/OR ELECTRONIC FILE IS COPYRIGHT AND SHALL NOT BE REPRODUCED. NOR USED FOR ANY OTHER PURPOSE WITHOUT THE WRITTEN PERMISSION OF THE ARCHITECTS. THIS DRAWING MUST BE READ IN CONJUNCTION WITH ALL OTHER RELATED DRAWINGS AND DOCUMENTATION. IT IS THE CONTRACTOR'S RESPONSIBILITY TO ENSURE FULL COMPLIANCE WITH BUILDING DEPARTMENT REGULATIONS. DO NOT SCALE FROM THIS DRAWING, USE FIGURED DIMENSIONS ONLY. IT IS THE CONTRACTOR'S RESPONSIBILITY TO CHECK AND VERIFY ALL DIMENSIONS ON SITE. ANY DISCREPANCIES TO BE REPORTED

IMMEDIATELY TO ARCHITECT & OWNER PRIOR TO INSTALLATION OF WORK

CONSULTANTS:

310.846.4664

STRUCTURAL ENGINEER **GLOTMAN SIMPSON** 600 WILSHIRE BLVD., STE 650 LOS ANGELES, CA 90017 213.283.2513

MEP ENG AMA CONSTITUTING ENGINEERS 2101 EL S. GUNDO BLVD. EL SEGUNDO, CA 90245

LANDSCAPE APPLITECT 1424 4TH THIN FLOOR SANTA MONICA 90401 310.395.3


CIVIL ENGINEED 700 SOUTH FLOWER ST. STE 2100 LOS ANGELES 20017

DRAWING TITLE: HISTORIC PERMIT

SCALE AT ARCH D (24 x 36): DRAWN 1/16" = 1'-0"

SHEET NUMBER:

R002

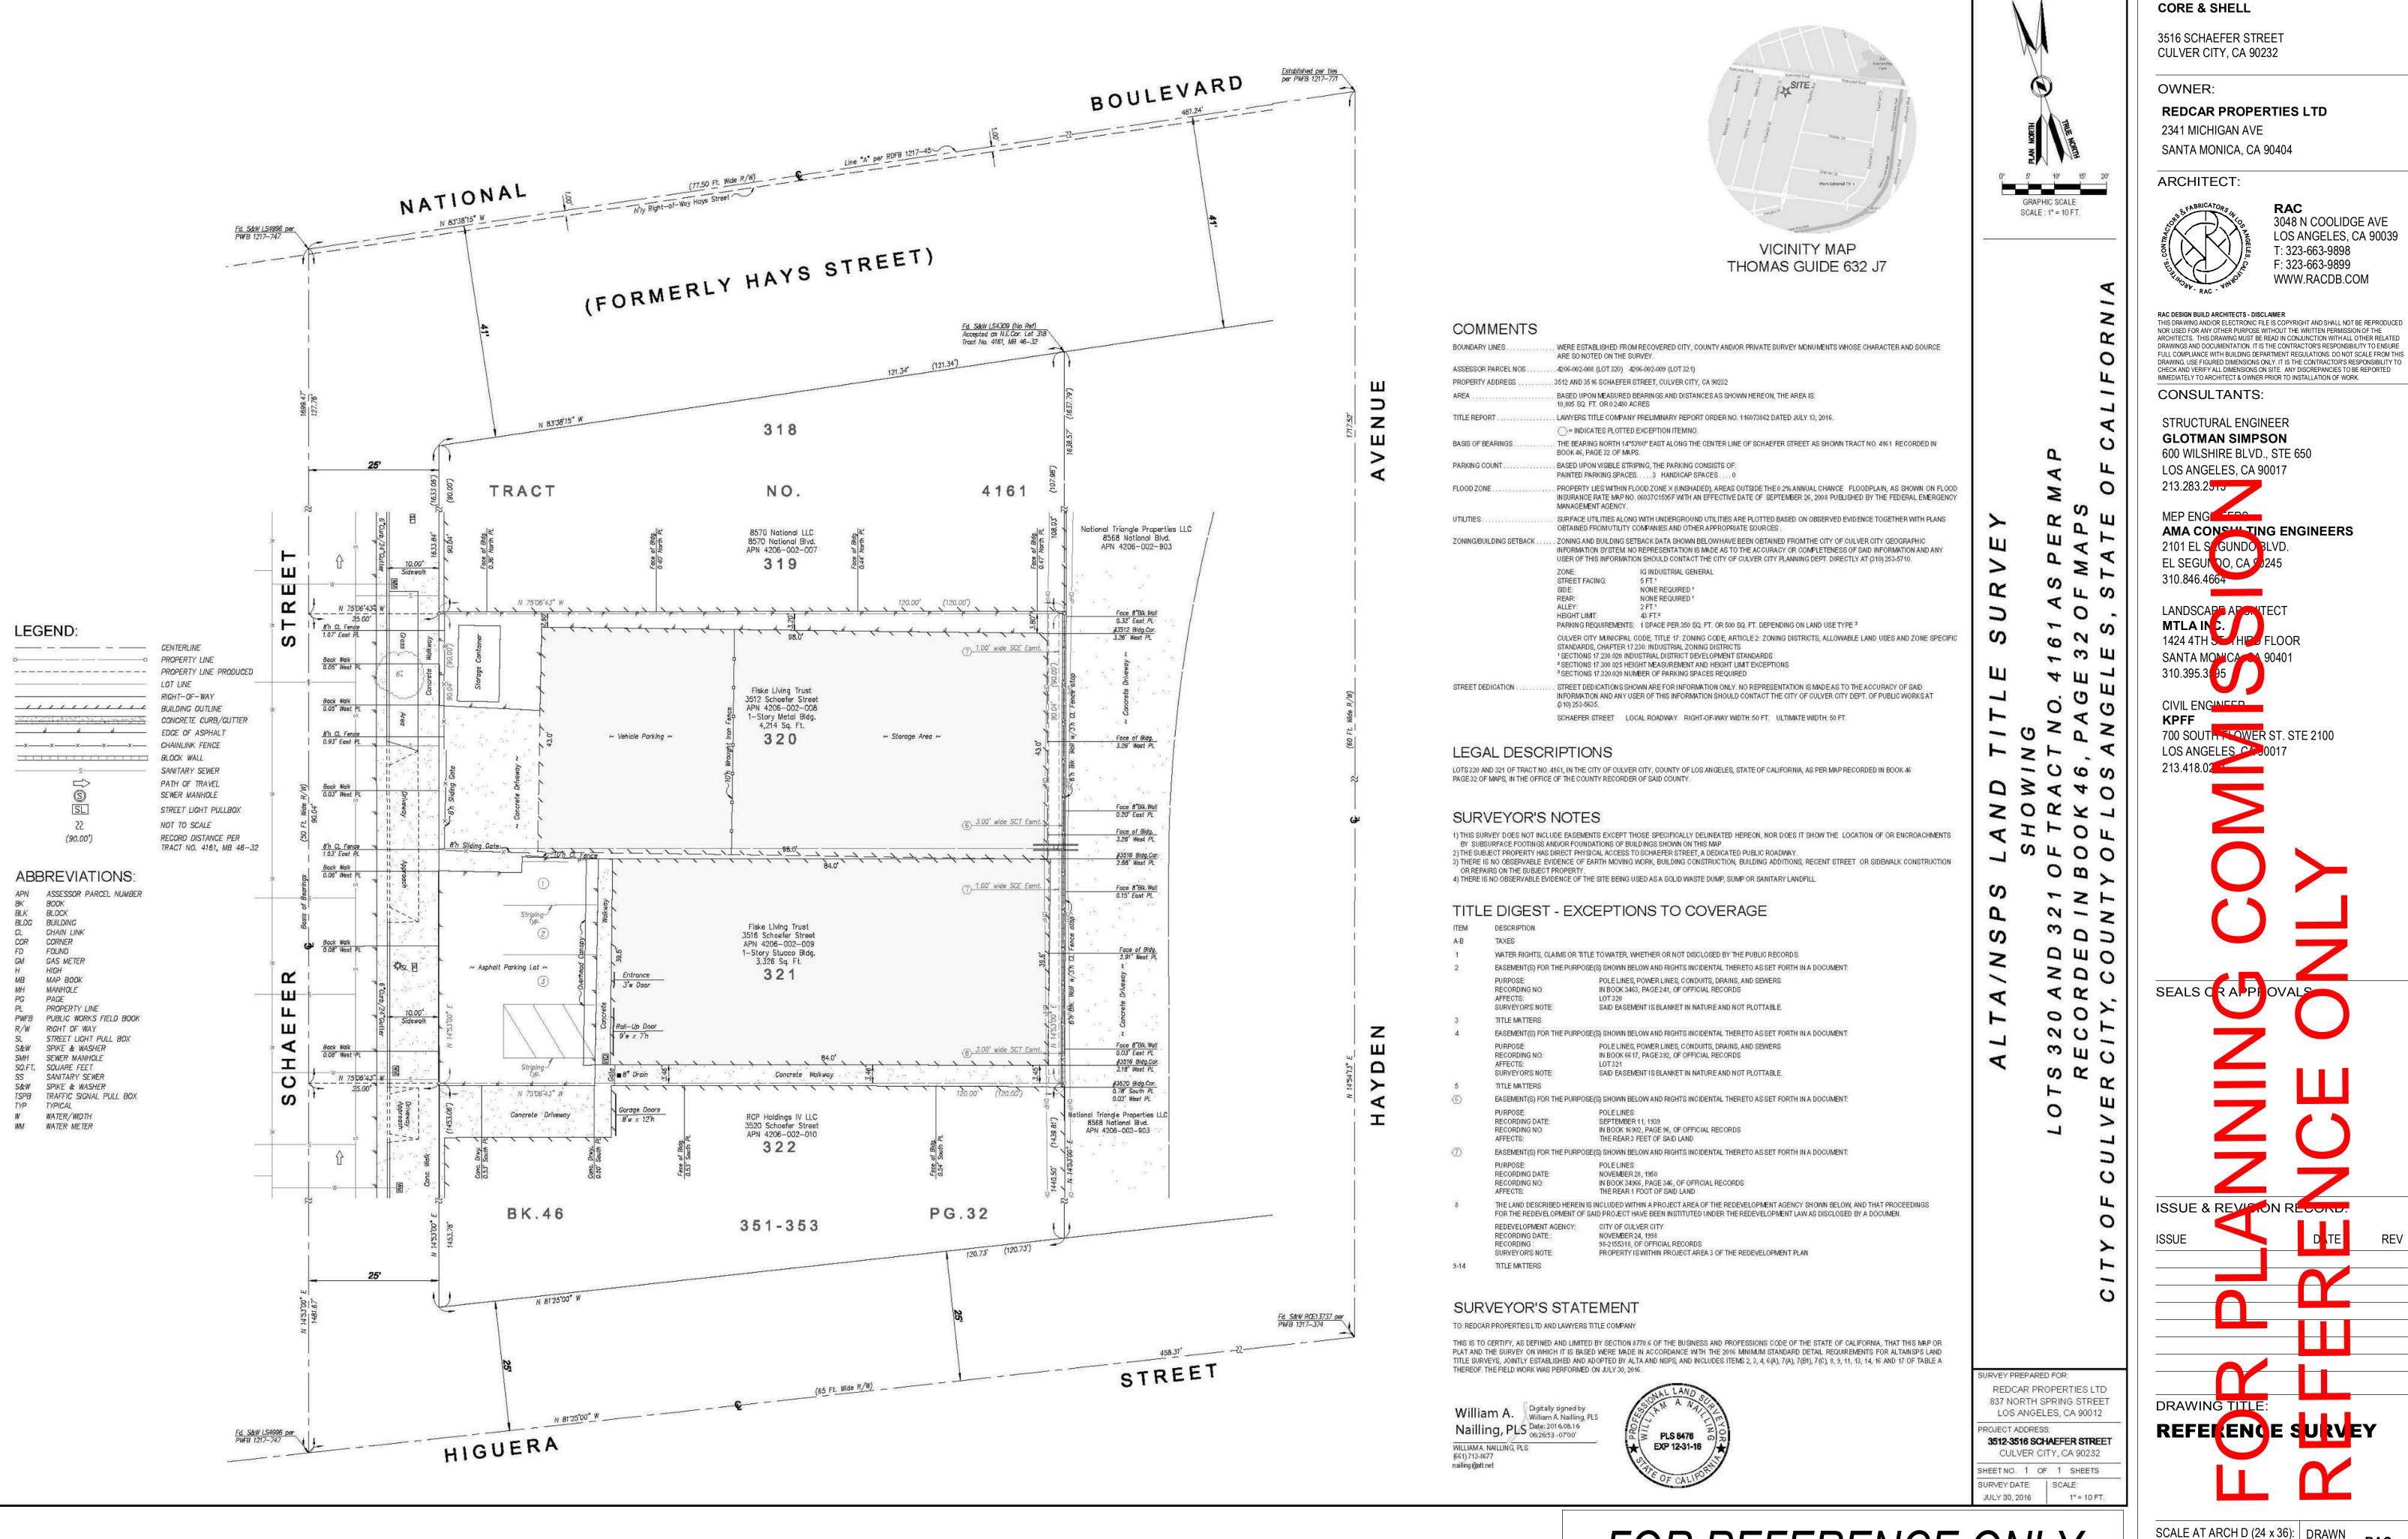

FOR REFERENCE ONLY

SCHAEFER 3516 CORE & SHELL

3516 SCHAEFER STREET

REDCAR PROPERTIES LTD 2341 MICHIGAN AVE



3048 N COOLIDGE AVE LOS ANGELES, CA 90039 T: 323-663-9898 F: 323-663-9899 WWW.RACDB.COM

RAC DESIGN BUILD ARCHITECTS - DISCLAIMER THIS DRAWING AND/OR ELECTRONIC FILE IS COPYRIGHT AND SHALL NOT BE REPRODUCED. NOR USED FOR ANY OTHER PURPOSE WITHOUT THE WRITTEN PERMISSION OF THE ARCHITECTS. THIS DRAWING MUST BE READ IN CONJUNCTION WITH ALL OTHER RELATED.

CONSULTANTS:

STRUCTURAL ENGINEER **GLOTMAN SIMPSON** 600 WILSHIRE BLVD., STE 650 LOS ANGELES, CA 90017

213.283.2513 AMA CONSTITUTING ENGINEERS 2101 EL S. GUNDO BLVD.

LANDSCAPE APP


700 SOUTH FLOWER ST. STE 2100

DRAWING TITLE

SCALE AT ARCH D (24 x 36): DRAWN 1" = 10'-0"

SHEET NUMBER: **R110**

© 2018 RAC DESIGN BUILD, INC.

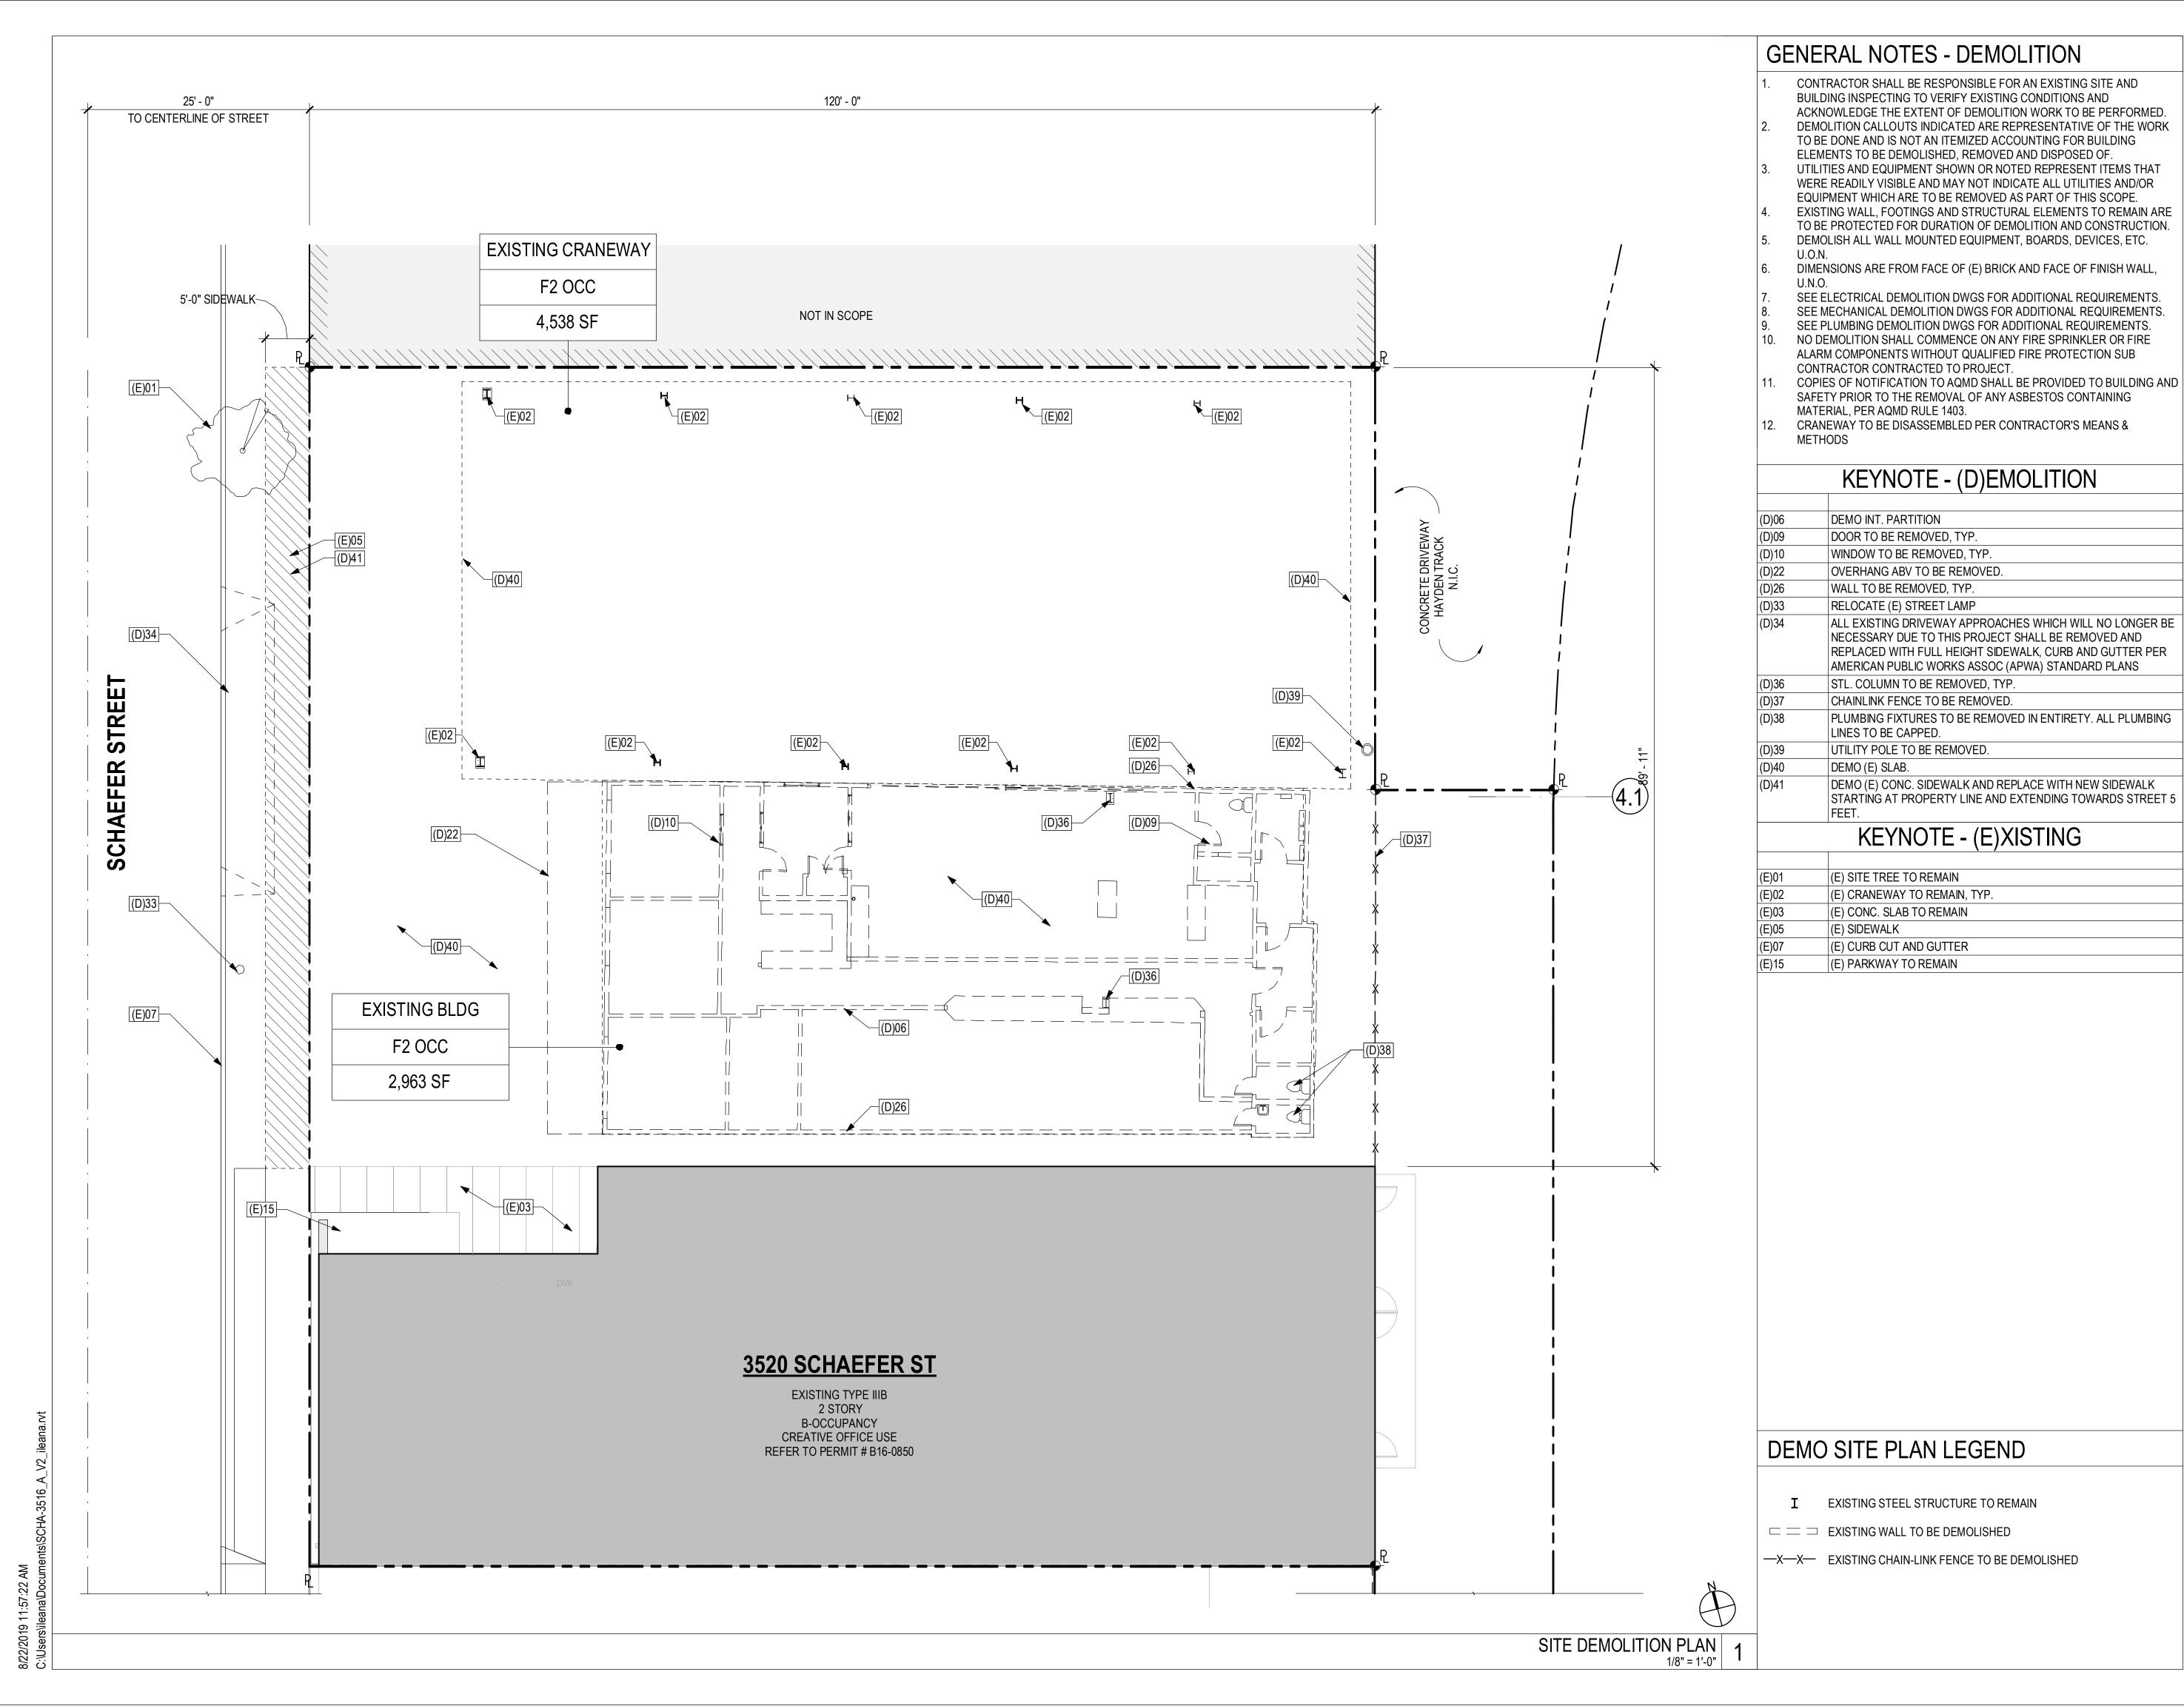

SCHAEFER 3516 CORE & SHELL

3516 SCHAEFER STREET CULVER CITY, CA 90232

OWNER:

REDCAR PROPERTIES LTD

2341 MICHIGAN AVE SANTA MONICA, CA 90404

ARCHITECT:



3048 N COOLIDGE AVE LOS ANGELES, CA 90039 T: 323-663-9898 F: 323-663-9899 WWW.RACDB.COM

RAC DESIGN BUILD ARCHITECTS - DISCLAIMER

THIS DRAWING AND/OR ELECTRONIC FILE IS COPYRIGHT AND SHALL NOT BE REPRODUCED NOR USED FOR ANY OTHER PURPOSE WITHOUT THE WRITTEN PERMISSION OF THE ARCHITECTS. THIS DRAWING MUST BE READ IN CONJUNCTION WITH ALL OTHER RELATED DRAWINGS AND DOCUMENTATION. IT IS THE CONTRACTOR'S RESPONSIBILITY TO ENSURE FULL COMPLIANCE WITH BUILDING DEPARTMENT REGULATIONS. DO NOT SCALE FROM THIS DRAWING, USE FIGURED DIMENSIONS ONLY. IT IS THE CONTRACTOR'S RESPONSIBILITY TO CHECK AND VERIFY ALL DIMENSIONS ON SITE. ANY DISCREPANCIES TO BE REPORTED IMMEDIATELY TO ARCHITECT & OWNER PRIOR TO INSTALLATION OF WORK.

CONSULTANTS:

STRUCTURAL ENGINEER

GLOTMAN SIMPSON

600 WILSHIRE BLVD., STE 650

LOS ANGELES, CA 90017

213.283.2513

MEP ENGINEERS

AMA CONSULTING ENGINEERS

2101 EL SEGUNDO BLVD.

EL SEGUNDO, CA 50245

310 846 4664

LANDSCAPE APOINTECT
MTLA IN C.
1424 4TH ST. (HIP.) FLOOR
SANTA MONICA: 04, 90401
310.395.3:95

CIVIL ENGINEED

KPFF

700 SOUTH FLOWER ST. STE 2100

LOS ANGELES C. J0017

SEALS OR APPLOVALS

ISSUE & REVISION RECORD.

ISSUE DITE

DRAWING TITLE:

(E) SITE PLAN

DEMOLITION

SCALE AT ARCH D (24 x 36): DRAWN
As indicated BY:

SHEET NUMBER:

D101

SCHAEFER 3516 **CORE & SHELL**

3516 SCHAEFER STREET

CULVER CITY, CA 90232

OWNER:

REDCAR PROPERTIES LTD 2341 MICHIGAN AVE SANTA MONICA, CA 90404

ARCHITECT:



RAC 3048 N COOLIDGE AVE LOS ANGELES, CA 90039 T: 323-663-9898 F: 323-663-9899 WWW.RACDB.COM

RAC DESIGN BUILD ARCHITECTS - DISCLAIMER

THIS DRAWING AND/OR ELECTRONIC FILE IS COPYRIGHT AND SHALL NOT BE REPRODUCED

NOR USED FOR ANY OTHER PURPOSE WITHOUT THE WRITTEN PERMISSION OF THE ARCHITECTS. THIS DRAWING MUST BE READ IN CONJUNCTION WITH ALL OTHER RELATED DRAWINGS AND DOCUMENTATION. IT IS THE CONTRACTOR'S RESPONSIBILITY TO ENSURE DRAWING, USE FIGURED DIMENSIONS ONLY. IT IS THE CONTRACTOR'S RESPONSIBILITY TO CHECK AND VERIFY ALL DIMENSIONS ON SITE. ANY DISCREPANCIES TO BE REPORTED IMMEDIATELY TO ARCHITECT & OWNER PRIOR TO INSTALLATION OF WORK.

CONSULTANTS:

STRUCTURAL ENGINEER **GLOTMAN SIMPSON** 600 WILSHIRE BLVD., STE 650 LOS ANGELES, CA 90017 213.283.2513

MEP ENG AMA CONSTITUTING ENGINEERS 2101 EL S. GUNDO BLVD.


700 SOUTH TLOWER ST. STE 2100



SCALE AT ARCH D (24 x 36): DRAWN BY: RAC

SHEET NUMBER: A100

PROPOSED SITE PLAN 1" = 30'-0"

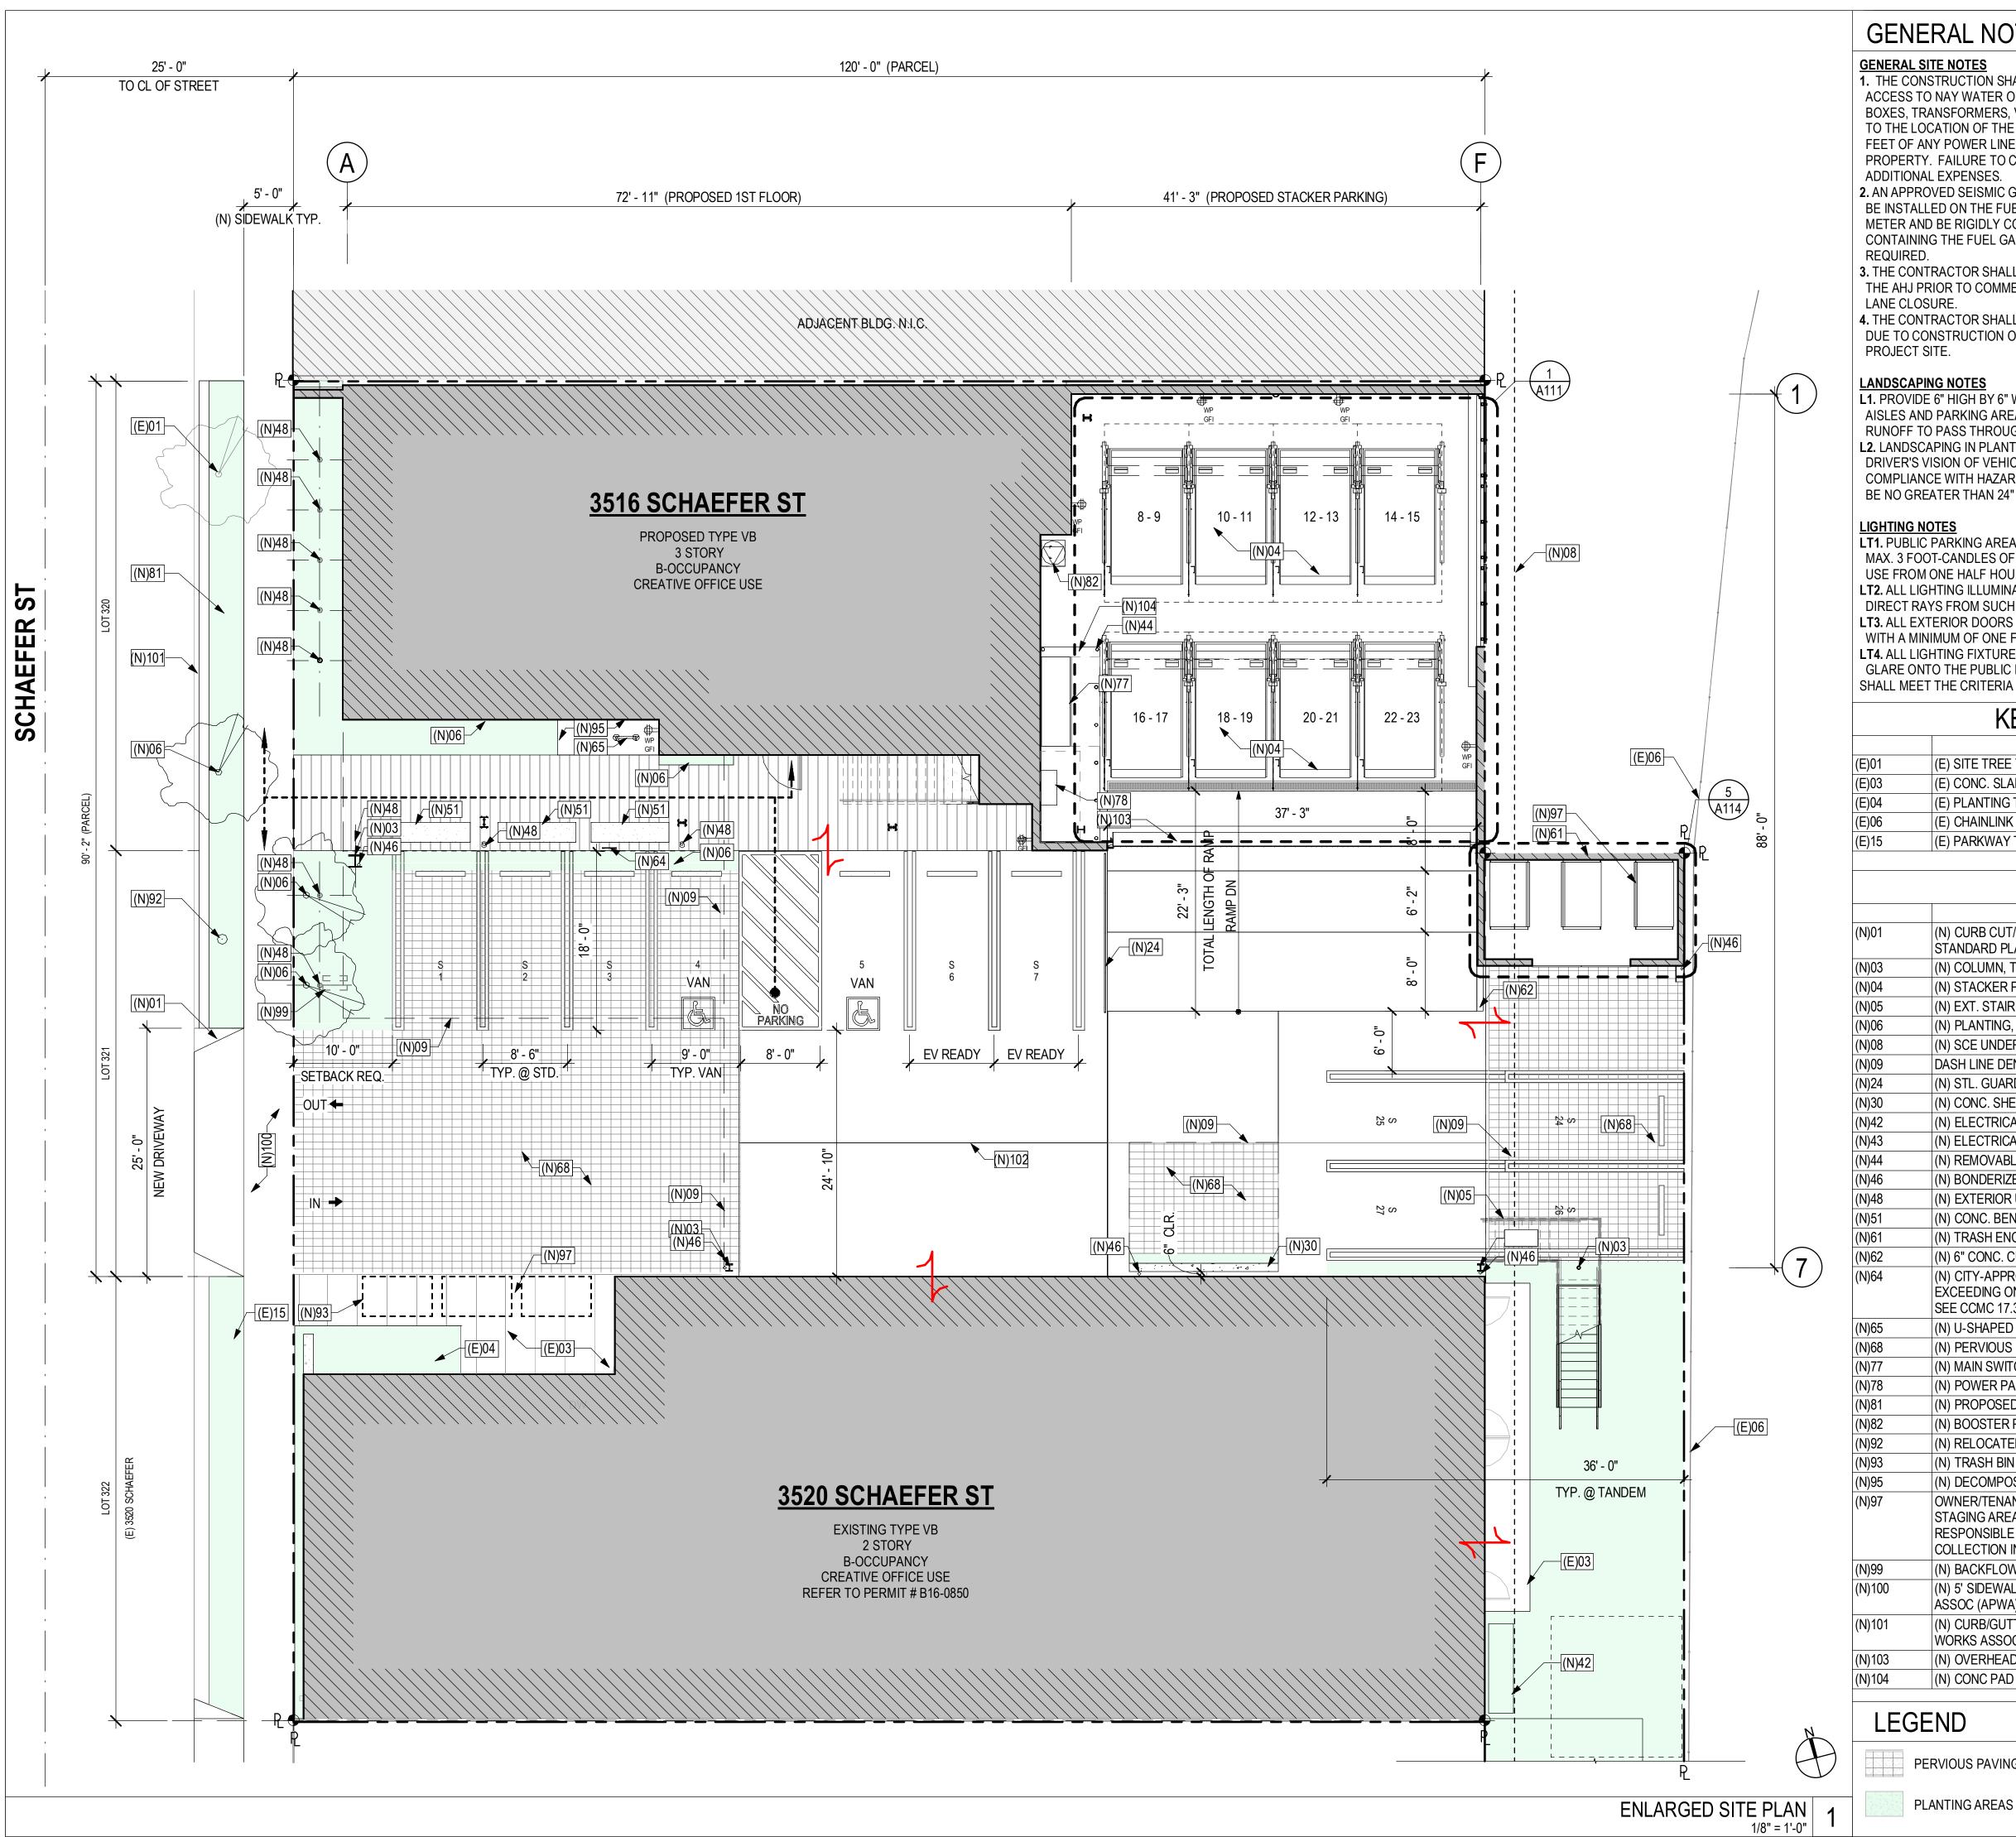

GENERAL NOTES - SITE PLAN

GENERAL SITE NOTES

1. THE CONSTRUCTION SHALL NOT RESTRICT A FIVE FOOT CLEAR AND UNOBSTRUCTED ACCESS TO NAY WATER OR POWER DISTRIBUTION FACILITIES (POWER POLES, PULL-BOXES, TRANSFORMERS, VAULTS, PUMPS, VALVES, METERS, APPURTENANCES, ETC.) OR TO THE LOCATION OF THE HOOK-UP. THE CONSTRUCTION SHALL NOT BE WITHIN TEN FEET OF ANY POWER LINES, WHETHER OR NOT THE LINES ARE LOCATED ON THE PROPERTY. FAILURE TO COMPLY MAY CAUSE CONSTRUCTION DELAYS AND/OR

2. AN APPROVED SEISMIC GAS SHUT OFF VALVE OR EXCESS FLOW SHUT OFF VALVE WILL BE INSTALLED ON THE FUEL GAS LINE ON THE DOWN STREAM SIDE OF THE UTILITY METER AND BE RIGIDLY CONNECTED TO THE EXTERIOR OF THE BUILDING OR STRUCTURE CONTAINING THE FUEL GAS PIPING. (SMMC 8.32.070) SEPARATE PLUMBING PERMIT IS

- 3. THE CONTRACTOR SHALL OBTAIN ALL REQUIRED CITY ENCROACHMENT PERMITS FROM THE AHJ PRIOR TO COMMENCING ANY WORK IN THE PUBLIC RIGHT-OF-WAY, INCLUDING
- 4. THE CONTRACTOR SHALL REPAIR ANY DAMAGE TO PUBLIC STREETS AND/OR SIDEWALKS DUE TO CONSTRUCTION OR BY CONSTRUCTION VEHICLES TRAVELING TO OR FROM THE

LANDSCAPING NOTES

L1. PROVIDE 6" HIGH BY 6" WIDE CURB AROUND LANDSCAPED AREAS ADJACENT TO DRIVE AISLES AND PARKING AREAS. CURBS SHALL BE DESIGNED TO ALLOW FOR STORM WATER RUNOFF TO PASS THROUGH.

L2. LANDSCAPING IN PLANTERS AT ENDS OF PARKING AISLES SHALL NOT OBSTRUCT A DRIVER'S VISION OF VEHICULAR AND PEDESTRIAN CROSS-TRAFFIC AND SHALL BE BUILT IN COMPLIANCE WITH HAZARDOUS VISUAL OBSTRUCTION GUIDELINES. MAXIMUM HEIGHT TO BE NO GREATER THAN 24" ABOVE PAVEMENT SURFACE.

LT1. PUBLIC PARKING AREAS SHALL BE PROVIDED WITH A MIN. 0.5 FOOT-CANDLES AND MAX. 3 FOOT-CANDLES OF LIGHT OVER THE PARKING SURFACE DURING THE HOURS OF USE FROM ONE HALF HOUR BEFORE DUSK UNTIL ONE HALF HOUR AFTER DAWN. LT2. ALL LIGHTING ILLUMINATING PARKING AREAS SHALL BE ARRANGED SO THAT ALL

DIRECT RAYS FROM SUCH LIGHTING FALL ENTIRELY WITHIN SUCH PARKING LOT. LT3. ALL EXTERIOR DOORS ARE TO BE ILLUMINATED, DURING THE HOURS OF DARKNESS. WITH A MINIMUM OF ONE FOOT-CANDLE OF LIGHT.


LT4. ALL LIGHTING FIXTURES SHALL BE SHIELDED SO AS NOT TO PRODUCE OBTRUSIVE GLARE ONTO THE PUBLIC RIGHT-OF-WAY OR ADJACENT PROPERTIES. ALL LUMINARIES SHALL MEET THE CRITERIA OF THE IESNA FOR "CUT OFF" OF "FULL CUT OFF" LUMINARIES


KEYNOTE - (E)XISTING

(E)01	(E) SITE TREE TO REMAIN
(E)03	(E) CONC. SLAB TO REMAIN
(E)04	(E) PLANTING TO REMAIN
(E)06	(E) CHAINLINK FENCE
(E)15	(E) PARKWAY TO REMAIN

KEYNOTE - (N)EW

(N)01	(N) CURB CUT/DRIVEWAY PER AMERICAN PUBLIC WORKS ASSOC (APWA) STANDARD PLANS
(N)03	(N) COLUMN, TYP. SEE STRUCT.
(N)04	(N) STACKER PARKING
(N)05	(N) EXT. STAIR
(N)06	(N) PLANTING, REFER TO LANDSCAPE DWGS
(N)08	(N) SCE UNDERGROUND EASEMENT
(N)09	DASH LINE DENOTES FLOOR ABOVE
(N)24	(N) STL. GUARDRAIL
(N)30	(N) CONC. SHEAR WALL
(N)42	(N) ELECTRICAL SWITCH GEAR
(N)43	(N) ELECTRICAL TRANSFORMER VAULT BELOW GRADE
(N)44	(N) REMOVABLE BOLLARD
(N)46	(N) BONDERIZED SHT. MTL DOWNSPOUT
(N)48	(N) EXTERIOR UPLIGHT, SEE SPEC
(N)51	(N) CONC. BENCH SEATING, T.I. ONLY
(N)61	(N) TRASH ENCLOSURE
(N)62	(N) 6" CONC. CURB
(N)64	(N) CITY-APPROVED "LOADING ONLY" SIGN W/ DESIGNATED TIME PERIOD NOT EXCEEDING ONE-HALF HOUR PER DAY DURING NORMAL BUSINESS HOURS, SEE CCMC 17.320.050.C.1.B.
(N)65	(N) U-SHAPED BIKE RACK, SHORT TERM
(N)68	(N) PERVIOUS SURFACE, SEE SPEC.
(N)77	(N) MAIN SWITCHGEAR
(N)78	(N) POWER PACK FOR HYDRAULIC SYSTEM PER PARK PLUS
(N)81	(N) PROPOSED PARKWAY, UNDER SEPARATE PERMIT
(N)82	(N) BOOSTER PUMP, REFER TO PLUMBING DWGS
(N)92	(N) RELOCATED STREET LAMP
(N)93	(N) TRASH BIN STAGING AREA
(N)95	(N) DECOMPOSED GRANITE
(N)97	OWNER/TENANT SHALL BE RESPONSIBLE FOR BRINGING TRASH BINS TO THE STAGING AREA DURING COLLECTION SERVICE DAYS AND SHALL BE RESPONSIBLE TO BRING BACK THE TRASH BINS IMMEDIATELY UPON TRASH COLLECTION INSIDE TRASH ENCLOSURE FOR STORAGE.
(N)99	(N) BACKFLOW PREVENTER, REFER TO CIVIL DWGS
(N)100	(N) 5' SIDEWALK ALONG PROJECT FRONTAGE PER AMERICAN PUBLIC WORKS ASSOC (APWA) STANDARD PLANS
(N)101	(N) CURB/GUTTER TO REPLACE (E) CURB/GUTTER PER AMERICAN PUBLIC WORKS ASSOC (APWA) STANDARD PLANS
(N)103	(N) OVERHEAD ROLLING DOOR
(N)104	(N) CONC PAD AT ELECTRICAL EQUIPMENT

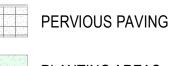

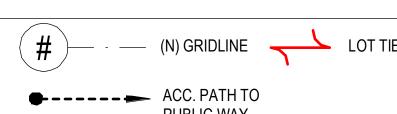

SCHAEFER 3516 CORE & SHELL

3516 SCHAEFER STREET

CULVER CITY, CA 90232

OWNER:

REDCAR PROPERTIES LTD

2341 MICHIGAN AVE SANTA MONICA, CA 90404

ARCHITECT:



3048 N COOLIDGE AVE LOS ANGELES, CA 90039 T: 323-663-9898 F: 323-663-9899 WWW.RACDB.COM

RAC DESIGN BUILD ARCHITECTS - DISCLAIMER

THIS DRAWING AND/OR ELECTRONIC FILE IS COPYRIGHT AND SHALL NOT BE REPRODUCED NOR USED FOR ANY OTHER PURPOSE WITHOUT THE WRITTEN PERMISSION OF THE ARCHITECTS. THIS DRAWING MUST BE READ IN CONJUNCTION WITH ALL OTHER RELATED DRAWINGS AND DOCUMENTATION. IT IS THE CONTRACTOR'S RESPONSIBILITY TO ENSURE DRAWING, USE FIGURED DIMENSIONS ONLY. IT IS THE CONTRACTOR'S RESPONSIBILITY TO CHECK AND VERIFY ALL DIMENSIONS ON SITE. ANY DISCREPANCIES TO BE REPORTED IMMEDIATELY TO ARCHITECT & OWNER PRIOR TO INSTALLATION OF WORK

CONSULTANTS:

STRUCTURAL ENGINEER **GLOTMAN SIMPSON** 600 WILSHIRE BLVD., STE 650 LOS ANGELES, CA 90017 213.283.2513

MEP ENG AMA CONSTITUTING ENGINEERS 2101 EL S. GUNDO BLVD. EL SEGUI DO, CA 90245

LANDSCAPE APP 1424 4TH THIN FLOOR


310.846.4664

700 SOUTH FLOWER ST. STE 2100 LOS ANGELES C

SCALE AT ARCH D (24 x 36): DRAWN As indicated

SHEET NUMBER:

A101

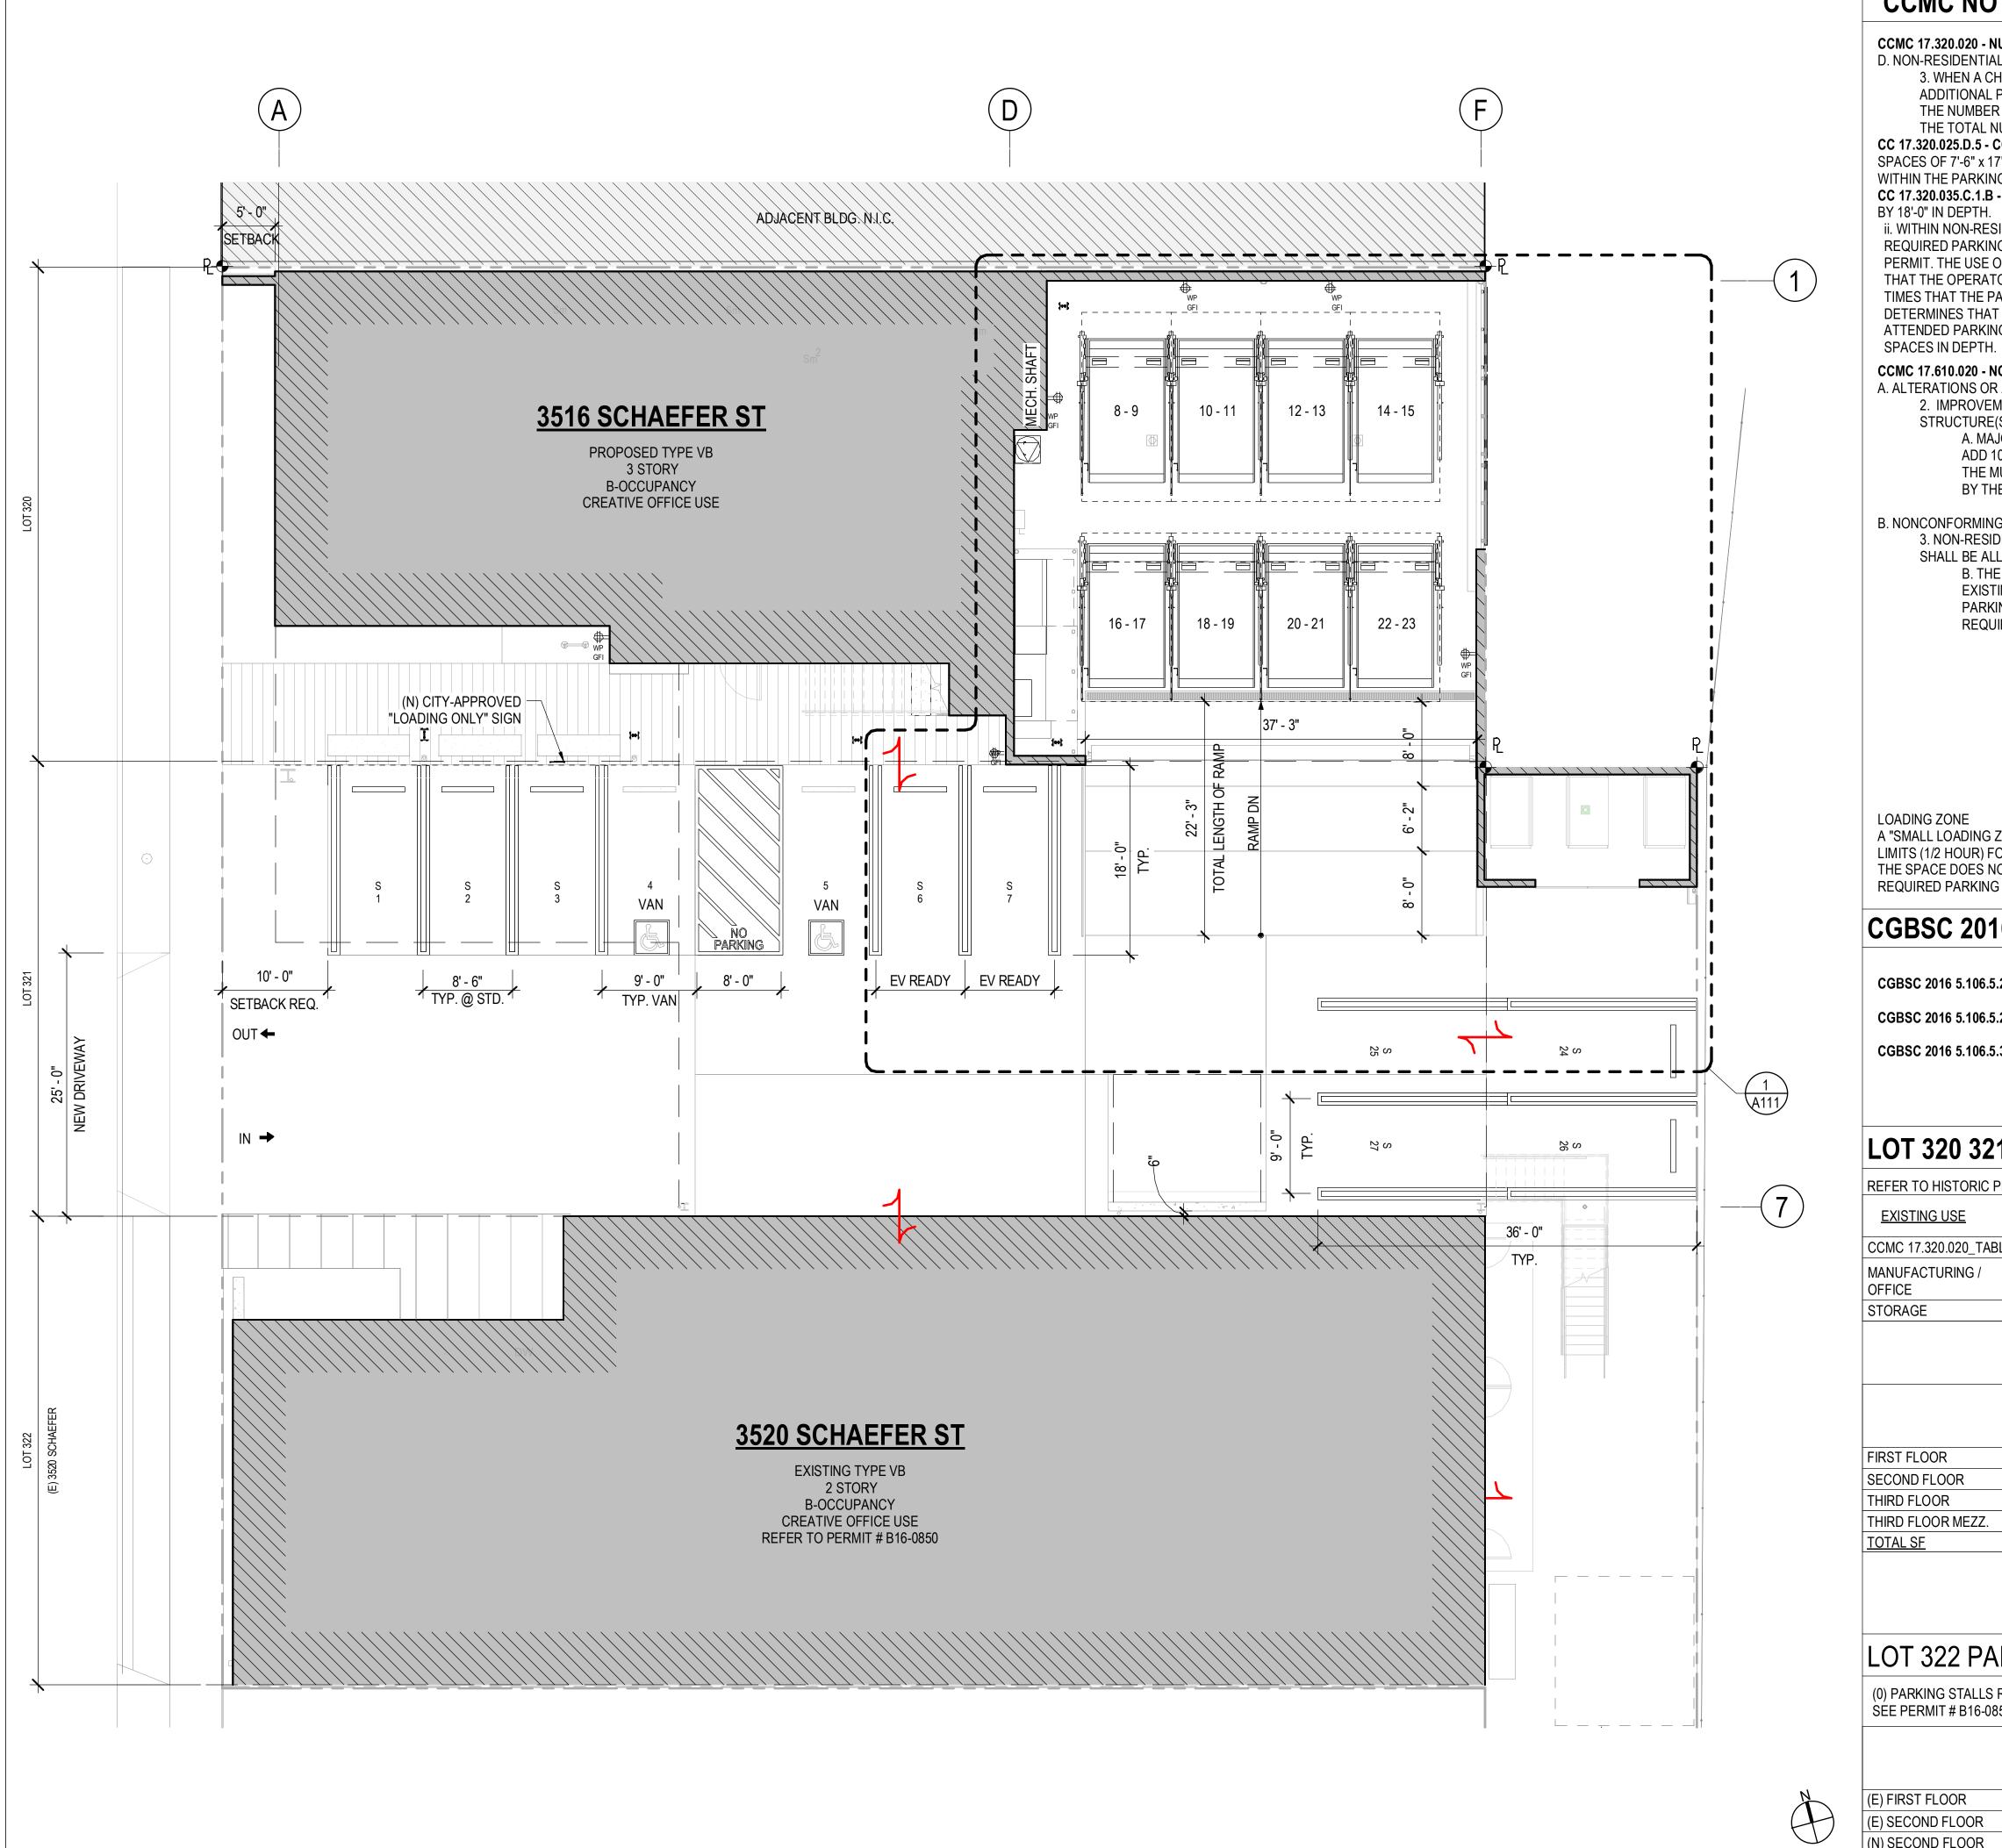

CCMC NOTES FOR REFERENCE

CCMC 17.320.020 - NUMBER OF PARKING SPACES REQUIRED

D. NON-RESIDENTIAL CHANGE OF USE, EXPANSE OF STRUCTURE

3. WHEN A CHANGE OF USE REQUIRES MORE OFF-STREET PARKING THAN THE PREVIOUS USE, ADDITIONAL PARKING SPACES SHALL BE PROVIDED EQUIVALENT TO THE DIFFERENCE BETWEEN THE NUMBER OF SPACES REQUIRED BY THIS TITLE FOR THE IMMEDIATELY PREVIOUS USE AND THE TOTAL NUMBER OF SPACES REQUIRED BY THE NEW USE.

CC 17.320.025.D.5 - COMPACT SPACES. EXCEPT AS OTHERWISE PROVIDED IN SECTION 17.320.035 COMPACT SPACES OF 7'-6" x 17'-6" MAY BE PROVIDED FOR UP TO 30% OF REQUIRED ON-SITE OR OFF-SITE PARKING WITHIN THE PARKING DISTRICTS.

CC 17.320.035.C.1.B - TANDEM PARKING SPACES. EACH TANDEM PARKING SPACE SHALL BE 9'-0" IN WIDTH BY 18'-0" IN DEPTH.

ii. WITHIN NON-RESIDENTIAL DISTRICTS, TANDEM PARKING MAY BE PROVIDED FOR REQUIRED PARKING SPACES WHERE AUTHORIZED THROUGH AN ADMINISTRATIVE USE PERMIT. THE USE OF THE TANDEM PARKING FOR NON-RESIDENTIAL USES SHALL REQUIRE THAT THE OPERATOR OF THE PARKING FACILITY PROVIDE A VALET OR ATTENDANT AT ALL TIMES THAT THE PARKING IS ACCESSIBLE TO USERS, EXCEPT WHERE THE DIRECTOR DETERMINES THAT THE NATURE OF THE USE AND ITS OPERATION WILL NOT REQUIRE ATTENDED PARKING. TANDEM PARKING MAY BE ARRANGED TO BE NO MORE THAN 3

CCMC 17.610.020 - NONCONFORMING STRUCTURES

A. ALTERATIONS OR ADDITIONS

2. IMPROVEMENTS TO NONCONFORMING MULTIPLE-FAMILY AND NON-RESIDENTIAL PRIMARY STRUCTURE(S).

A. MAJOR IMPROVEMENT DEFINED: A MAJOR IMPROVEMENT IS AN IMPROVEMENT THAT WILL ADD 10% OR MORE, WITH A MINIMUM OF 750 SF, TO THE EXISTING GROSS FLOOR AREA OF THE MULTIPLE-FAMILY OR NON-RESIDENTIAL STRUCTURE(S) ON THE SITE, AS DETERMINED BY THE BUILDING OFFICIAL.

B. NONCONFORMING DUE TO PARKING

3. NON-RESIDENTIAL STRUCTURES AND USES. STRUCTURES WITH PARKING SPACE DEFICIENCIES SHALL BE ALLOWED TO EXPAND OR ACCOMMODATE A CHANGE OF USE, PROVIDED THAT:

B. THE EXPANSION OR NEW USE HAS A GREATER PARKING REQUIREMENT THAN THE EXISTING OR PREVIOUS USE OR STRUCTURE, AND A SUFFICIENT NUMBER OF ADDITIONAL PARKING SPACES HAVE BEEN PROVIDED TO ACCOMMODATE THE NET INCREASE OF REQUIRED SPACES IN THE FOLLOWING MANNER:

i. THE NET NEW PARKING SPACES SHALL EQUAL THE NUMBER OF SPACES DIRECTLY REQUIRED BY THE CHANGE IN USE ONLY.

ii. THE NUMBER OF ADDITIONAL PARKING SPACES SHALL EQUAL THE NUMBER OF SPACES DIRECTLY REQUIRED BY THE EXPANSION AREA ONLY iii. WHERE THERE ARE 2 OR MORE NONCONFORMING STRUCTURES ON A SITE, BUT NOT ALL STRUCTURES ARE PROPOSED FOR ADDITIONS, CHANGES, OR INTENSIFICATIONS, PARKING NONCONFORMITIES FOR THE STRUCTURES NOT PROPOSED FOR ADDITIONS, CHANGES, OR INTENSIFICATIONS MAY REMAIN AS THEY ARE.

A "SMALL LOADING ZONE" MAY OCCUPY A STANDARD SIZE PARKING STALL WITH RESTRICTED TIME LIMITS (1/2 HOUR) FOR DELIVERIES. SEE SECTION 17.320.050.C.1.B. FOR SIGN POSTING REQUIREMENTS. THE SPACE DOES NOT HAVE TO BE IN ADDITION TO REQUIRED PARKING, BUT CAN SERVE AS REQUIRED PARKING OUTSIDE THE LOADING SPACE TIMES.

CGBSC 2016 NOTES FOR REFERENCE

CGBSC 2016 5.106.5.2 DESIGNATED PARKING FOR CLEAN AIR VEHICLES - 3 REQUIRED

ANY COMBINATION CARPOOL VAN POOL VEHICLES

CGBSC 2016 5.106.5.2.1 PARKING STALL MARKING CLEAN AIR/ VANPOOL/ EV

CGBSC 2016 5.106.5.3 ELECTRICAL VEHICLE (EV) CHARGING - 2 CHARGING STATIONS

REQUIRED PER TABLE CGBSC 2016 5.106.5.3.3

LOT 320 321 PARKING CALCULATIONS

REFER TO HISTORIC PERMIT SHEET R001 AND R002, FOR EXISTING PARKING BASIS

EXISTING USE	EXISTIN	<u>G AREA</u>	CHANGE OF USE	
CCMC 17.320.020_TABLE 3-3D			CCMC 17.320.020_TABLE 3-3B	STALLS
MANUFACTURING / OFFICE	(A)+(B.1)+(B.2)	= 2,963 SF	COMMERCIAL USE CREATIVE OFFICE	
STORAGE	D	= 4,538 SF		
	TOTAL EXISTING	= 7,501 SF	7,501 (1/350) = 21.43	21
			TOTAL C.O.U. PARKING <u>CREDIT</u>	21
				•

	AREA		PARKING REQUIRMENTS
	(EXCLUDING EXTERIOR DECKS)		
		RATIO	EVALUATION PER CURRENT CODE STALLS
FIRST FLOOR	2,366 SF		
SECOND FLOOR	6,147 SF		
THIRD FLOOR	6,565 SF		
THIRD FLOOR MEZZ.	1,872 SF		
TOTAL SF	16,950 TOTAL SF	1/350	16,950 SF (1/350) = 48.43 48

B; OFFICE (NEW AREA)	48
B; OFFICE (CHANGE OF USE CREDIT)	21
TOTAL PARKING REQUIRED	27

LOT 322 PARKING CALCULATIONS

(0) PARKING STALLS REQUIRED FOR (E) 3520 SCHAEFER

SEE PERMIT # B16-0850

PARKING PLAN

1/8" = 1'-0"

		<u>AREA</u>	PARKING REQUIREMENTS		
		(EXCLUDING EXTERIOR DECKS)	RATIO	EVALUATION PER CURRENT CODE	STALLS
	(E) FIRST FLOOR	4,495 SF			
	(E) SECOND FLOOR	1,484 SF			0
	(N) SECOND FLOOR	135 SF	1/350	135 SF (1/350) = .39	0
1	TOTAL SF	6,114 TOTAL SF			0
			TOTAL	PARKING REQUIRED	0

SCHAEFER 3516 CORE & SHELL

3516 SCHAEFER STREET CULVER CITY, CA 90232

OWNER:

REDCAR PROPERTIES LTD

SANTA MONICA, CA 90404

ARCHITECT:

2341 MICHIGAN AVE



3048 N COOLIDGE AVE LOS ANGELES, CA 90039 T: 323-663-9898 F: 323-663-9899 WWW.RACDB.COM

RAC DESIGN BUILD ARCHITECTS - DISCLAIMER THIS DRAWING AND/OR ELECTRONIC FILE IS COPYRIGHT AND SHALL NOT BE REPRODUCED NOR USED FOR ANY OTHER PURPOSE WITHOUT THE WRITTEN PERMISSION OF THE ARCHITECTS. THIS DRAWING MUST BE READ IN CONJUNCTION WITH ALL OTHER RELATED DRAWINGS AND DOCUMENTATION. IT IS THE CONTRACTOR'S RESPONSIBILITY TO ENSURE DRAWING, USE FIGURED DIMENSIONS ONLY, IT IS THE CONTRACTOR'S RESPONSIBILITY TO CHECK AND VERIFY ALL DIMENSIONS ON SITE. ANY DISCREPANCIES TO BE REPORTED

CONSULTANTS:

IMMEDIATELY TO ARCHITECT & OWNER PRIOR TO INSTALLATION OF WORK.

STRUCTURAL ENGINEER **GLOTMAN SIMPSON** 600 WILSHIRE BLVD., STE 650 LOS ANGELES, CA 90017 213.283.2513

AMA CONSTITUTE ENGINEERS 2101 EL S. GUNDO BLVD. EL SEGUNDO, CA 90245

LANDSCAPE APONTECT 310.395.3:95

310.846.4664


700 SOUTH FLOWER ST. STE 2100

LOS ANGELES 20017

SEALS CRAPPHOVAL

SCALE AT ARCH D (24 x 36): DRAWN 1/8" = 1'-0"

SHEET NUMBER:

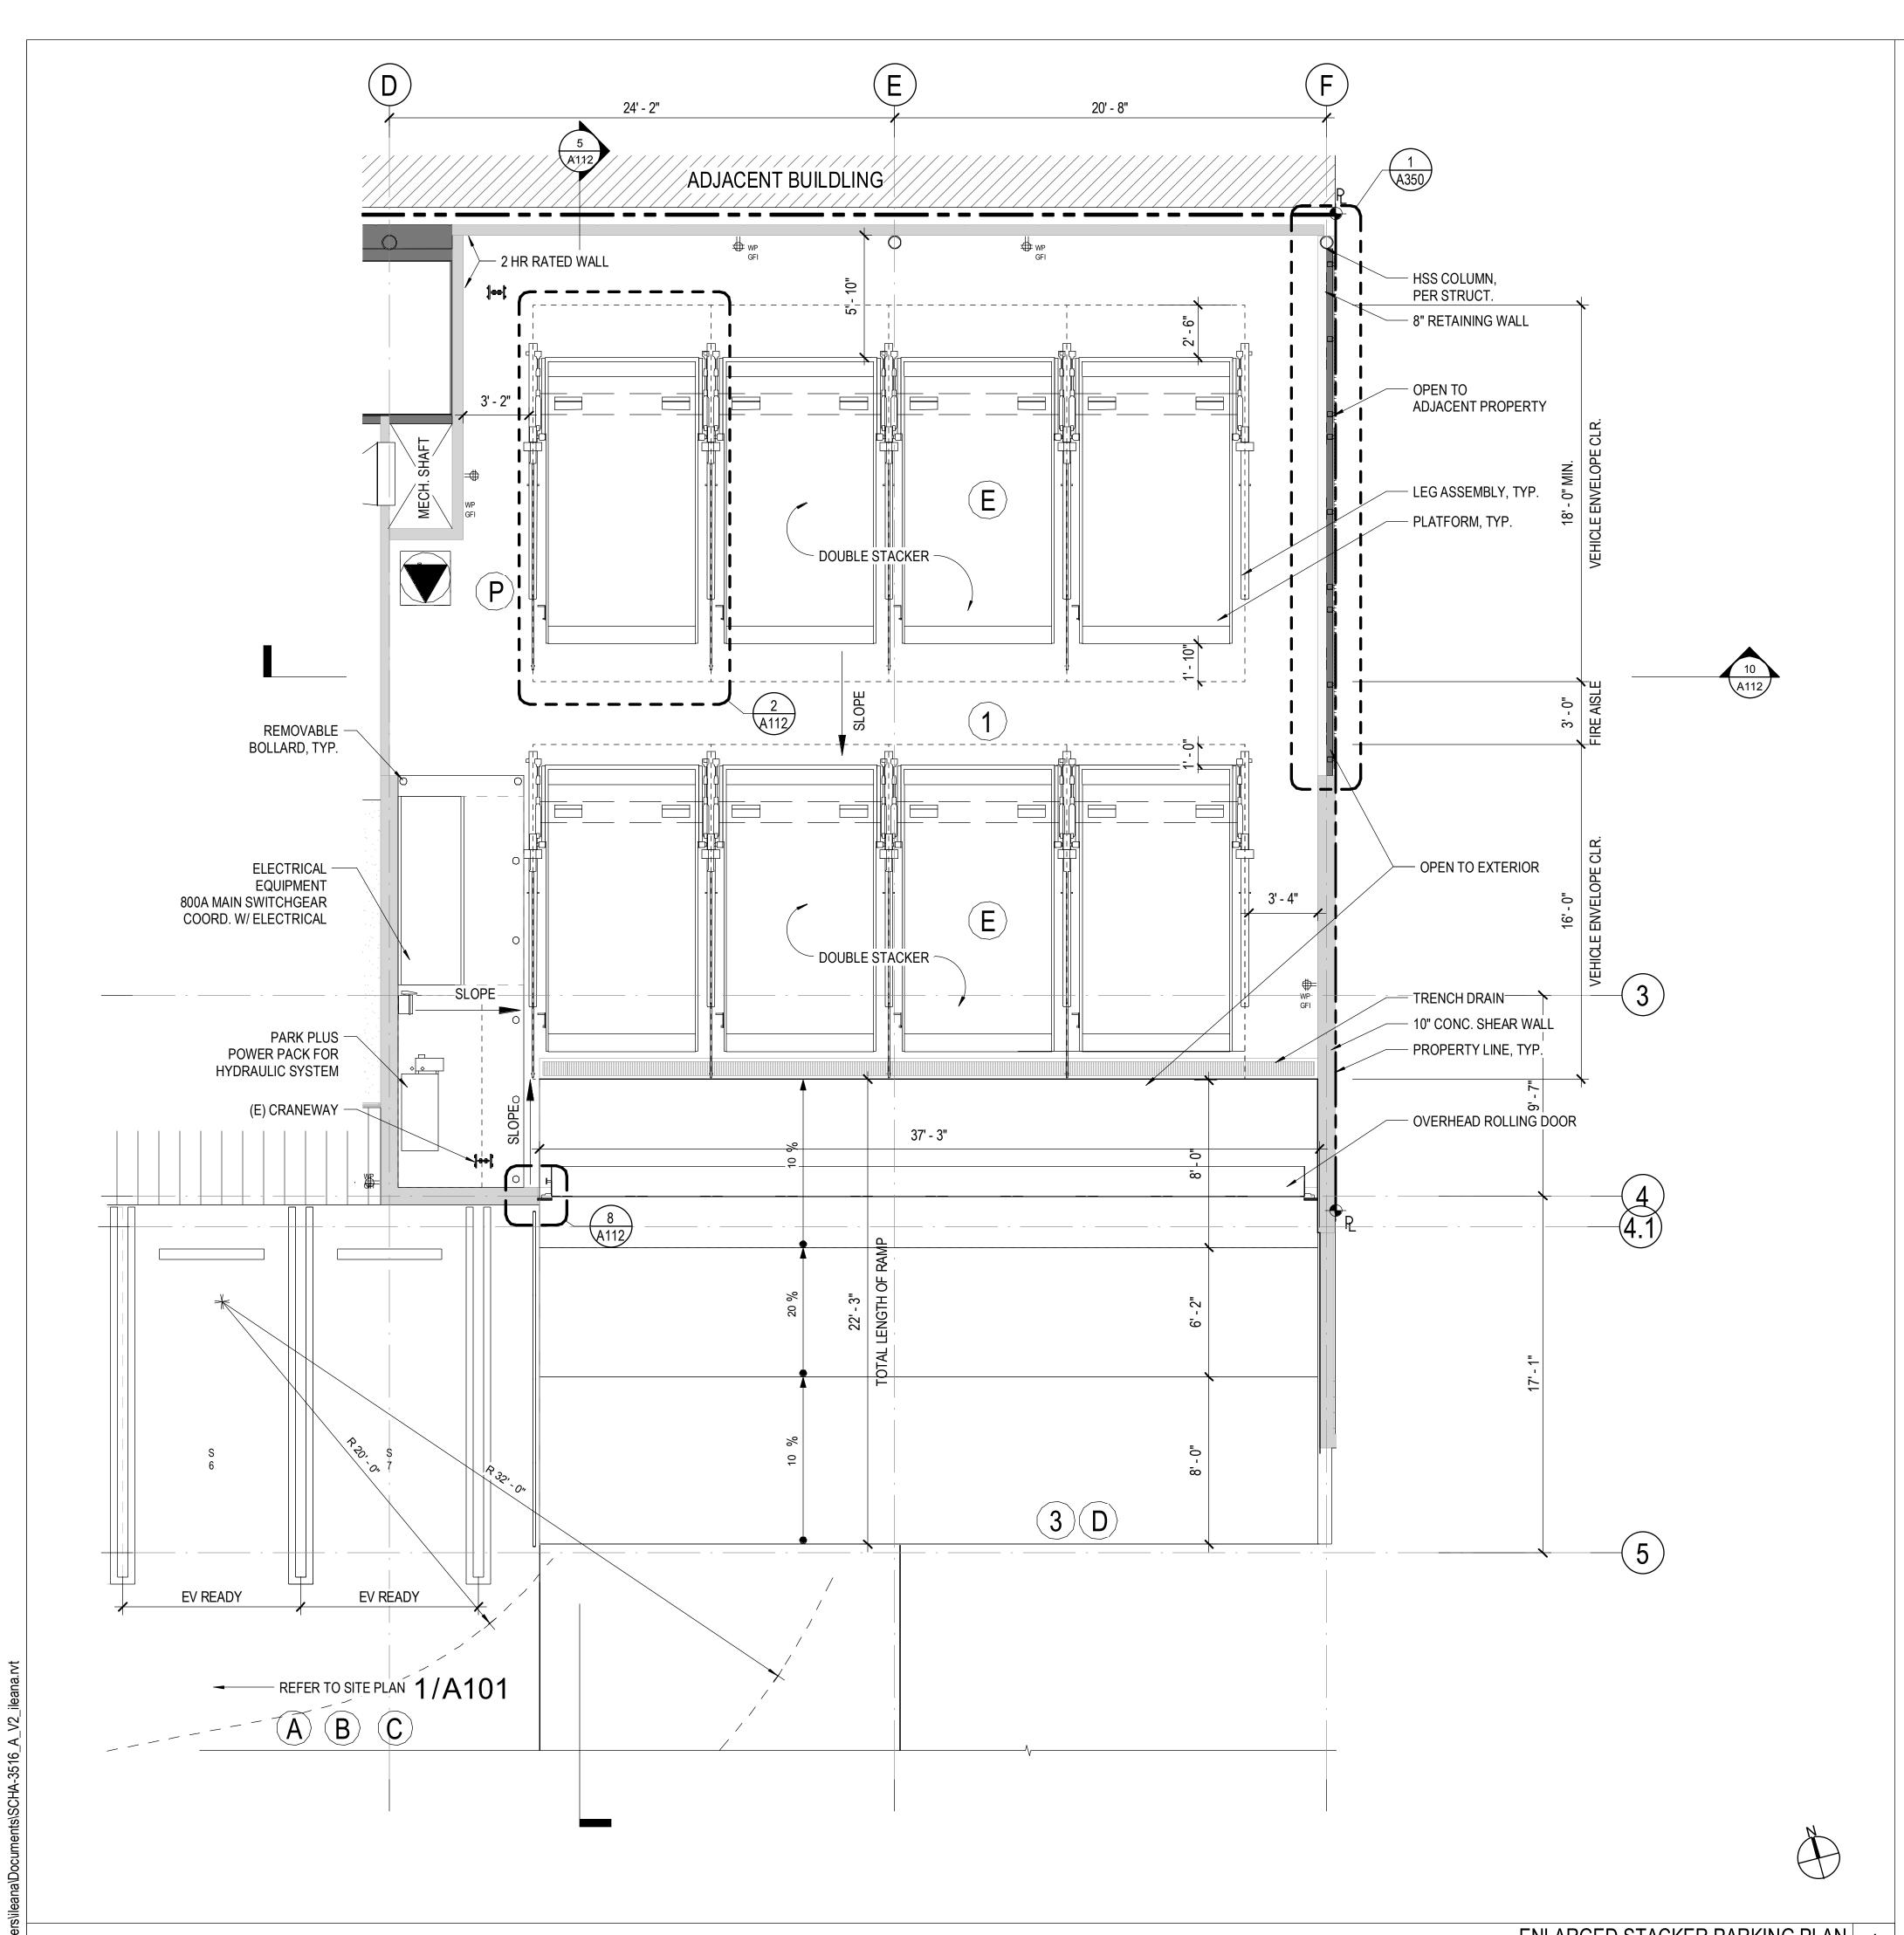

MECHANICAL PARKING DESIGN REQUIREMENTS

FIRE DEPARTMENT DEFINITIONS

- *ALL AISLE DIMENSIONS ARE MEASURED FROM THE VEHICLE ENVELOPE

 *THE MINIMUM VEHICLE ENVELOPE SHALL BE 8'X16', AND MAY EXTEND BEYOND THE LENGTH OF EQUIPMENT PLATFORM
- MAIN AISLE IS AN UNOBSTRUCTED WAY OF EGRESS IN FRONT OF A MECHANICAL CAR STACKER. THE MAIN AISLE IS USED AS A DRIVE AISLE IN FRONT OF A MECHANICAL CAR STACKER FOR ATTENDANTS TO LOAD AND UNLOAD VEHICLES. MUST HAVE MIN CLEARANCE PER TABLE 1A

TABLE 1A			
CAR STACKERS	MAIN AISLE	SIDE AISLE	ACCESS AISLE
2- HIGH	12'-0"*	4'-0"*	36" CLR*

FIRE DEPARTMENT SITE ACCESS

- ANY PERSON OWNING OR HAVING CONTROL OF ANY FACILITY, STRUCTURE, GROUP OF STRUCTURES OR PREMISES USING MECHANICAL PARKING SYSTEMS SHALL MAINTAIN FIRE DEPARTMENT ACCESS IN ACCORDANCE WITH CULVER CITY FIRE DEPARTMENT REQUIREMENTS
- IF ANY PORTION OF THE MECHANICAL PARKING STORAGE AREA IS MORE THAN 150 FEET FROM THE EDGE OF THE ROADWAY OF AN APPROVED STREET, AN APPROVED FIRE LANE SHALL BE PROVIDED SO THAT SUCH PORTION IS WITHIN 150 FEET OF THE EDGE OF THE FIRE LANE. FIRE LANES SHALL BE PAINTED AND STENCILED.
- WHERE ACCESS IS REQUIRED FOR FIRE DEPARTMENT APPARATUS, <u>OVERHEAD</u>

 <u>CLEARANCE SHALL BE NOT LESS THAN 20 FEET WIDE AND 13'-6"</u> AND/OR OPEN TO THE SKY, KNOX BOX AND KEY SYSTEM SHALL BE PROVIDED.

FIRE DEPARTMENT EQUIPMENT ACCESSIBILITY (OPEN GARAGE)

- (D) EACH PLATFORM MUST BE DIRECTLY ACCESSIBLE FROM A MAIN AISLE OR FIRE LANE.
- PROJECT USING TANDEM MECHANICAL PARKING MUST PROVIDE ACCESS TO THE BACK ROW OF PLATFORMS VIA SIDE AISLE, ACCESS AISLES, AND CATWALK. EXCEPTION: TWO LEVEL TANDEM MECHANICAL PARKING INSTALLATIONS DO NOT REQUIRE CATWALKS BUT MUST MAINTAIN MINIMUM VEHICLE ENVELOPE REQUIREMENTS.
- OPEN GARAGE INSTALLATIONS OF MECHANICAL CAR STACKERS MUST MEET REQUIREMENTS A-E.
- OPEN GARAGE MECHANICAL PARKING STORAGE AREAS MUST BE <u>FULLY SPRINKLERED</u> MECHANICAL CAR STACKERS PILES MUST BE <u>18" BELOW AUTOMATIC SPRINKLER HEADS</u>
- *FIRE PROTECTION ENGINEER TO SUBMIT DESIGN FOR APPROVAL.

 INDOOR MECHANICAL PARKING STORAGE AREAS MUST PROVIDE TWO EXITS AT THE LOWER LEVEL WITH A MAXIMUM TRAVEL DISTANCE LIMITED TO 250'.
- ALLOWABLE BUILDING HEIGHTS AND AREA SHALL BE LIMITED PER TABLE 504.3, TABLE 504.4, AND TABLE 506.2 OF CBC FOR S-2 OCCUPANCY REQUIREMENTS FOR OPEN OR ENCLOSED PARKING STRUCTURES. ALLOWABLE AREA SHALL BE CALCULATED USING THE SUM OF EACH TIER OF THE MECHANICAL CAR STACKERS ALLOWABLE VEHICLE ENVELOPE.

TABLE	506.2		
OCC.	S1 CLASS.	TYPE OF CONSTRUCTION	ALLOWABLE AREA
S-2	SPRINKLERED	VB	54,000 SF

AREA OF VEHICLE ENVELOPE = <u>128 SF</u> SUM OF EACH TIER = (2)128 SF = <u>296 SF</u> TOTAL AREA = (8)296 SF = 2,368 SF

ZONING					
INDUSTRIAL	LOT AREA	FAR	MAX AREA (SF)	MAX HEIGHT	MAX STORIES
GENERAL (IG)	10,800 SF	N/A	PENDING PARKING & LAND USE	43 SF	N/A

- MECHANICAL PARKING STORAGE AREAS SHALL BE SEPARATED FROM OTHER USES BY A 2HR FIRE WALL
- MECHANICAL VENTILATION MUST BE PROVIDED PER THE MECHANICAL CODE AT A MINIMUM OF FOUR AIR CHANGES PER HOUR.
- A SMOKE EXHAUST SYSTEM SHALL BE REQUIRED FOR LARGE INDOOR MECHANICAL AREAS WITH TWO OR MORE MECHANICAL CAR STACKER PILES WITH A MINIMUM OF SIX AIR CHANGES PER HOUR.

BUILDING SETE	BACK REQ.		
STREET FACING	SIDE	REAR	ALLEY
5'-0"	N/A	N/A	2'-0"

(2) LONG TERM SPACES, PARKING SPACES AND TWO SHORT TERM PARKING SPACES. LONG TERM SPACES SHALL BE PROVIDED IN INDIVIDUAL BIKE LOCKERS OR BIKE RACKS IN A SECURE LOCKING ENCLOSURE, ACCESSIBLE ONLY TO THE BICYCLE OWNERS, AND SHALL BE LOCATED SO THEY ARE PROTECTED FROM THE WEATHER, EASILY ACCESSED.

(2) SHORT TERM SPACES MAY BE PROVIDED ON THE PROJECT SITE, USING ONE INVERTED U BICYCLE RACK OR SIMILAR. THE SHORT TERM BICYCLE PARKING SPACES SHALL BE PROVIDED 72" AISLES AND 48" BETWEEN BICYCLE PARKING AREAS, WITH A MINIMUM 24" SEPARATION BETWEEN THE BICYCLE RACK AND ANY ADJACENT ENCLOSURE WALL.

SCHAEFER 3516 CORE & SHELL

3516 SCHAEFER STREET CULVER CITY, CA 90232

OWNER:

REDCAR PROPERTIES LTD2341 MICHIGAN AVE

ARCHITECT:



SANTA MONICA, CA 90404

RAC 3048 N COOLIDGE AVE LOS ANGELES, CA 90039 T: 323-663-9898 F: 323-663-9899 WWW.RACDB.COM

RAC DESIGN BUILD ARCHITECTS - DISCLAIMER

THIS DRAWING AND/OR ELECTRONIC FILE IS COPYRIGHT AND SHALL NOT BE REPRODUCED NOR USED FOR ANY OTHER PURPOSE WITHOUT THE WRITTEN PERMISSION OF THE ARCHITECTS. THIS DRAWING MUST BE READ IN CONJUNCTION WITH ALL OTHER RELATED

DRAWINGS AND DOCUMENTATION. IT IS THE CONTRACTOR'S RESPONSIBILITY TO ENSURE

DRAWING, USE FIGURED DIMENSIONS ONLY, IT IS THE CONTRACTOR'S RESPONSIBILITY TO

CHECK AND VERIFY ALL DIMENSIONS ON SITE. ANY DISCREPANCIES TO BE REPORTED IMMEDIATELY TO ARCHITECT & OWNER PRIOR TO INSTALLATION OF WORK.

CONSULTANTS:

STRUCTURAL ENGINEER
GLOTMAN SIMPSON
600 WILSHIRE BLVD., STE 650
LOS ANGELES, CA 90017
213.283.2513

MEP ENGINEERS

AMA CONSULTING ENGINEERS

2101 EL SEGUNDO BLVD.

EL SEGUNDO, CA S 245

310.846.4664

LANDSCAPE APCINTECT
MTLA IN C.
1424 4TH STAHID FLOOR
SANTA MONICA CA 90401
310.395.3.95

CIVIL ENGINEED

KPFF

700 SOUTH TOWER ST. STE 2100

LOS ANGELES CA. J0017

EALS OR APPLOVALS

ISSUE & REVISION RECORD:


DITE


DRAWING TITLE:
ENLARGED STACKER
PARKING PLAN

SCALE AT ARCH D (24 x 36): DRAWN
As indicated BY:

SHEET NUMBER:

A111

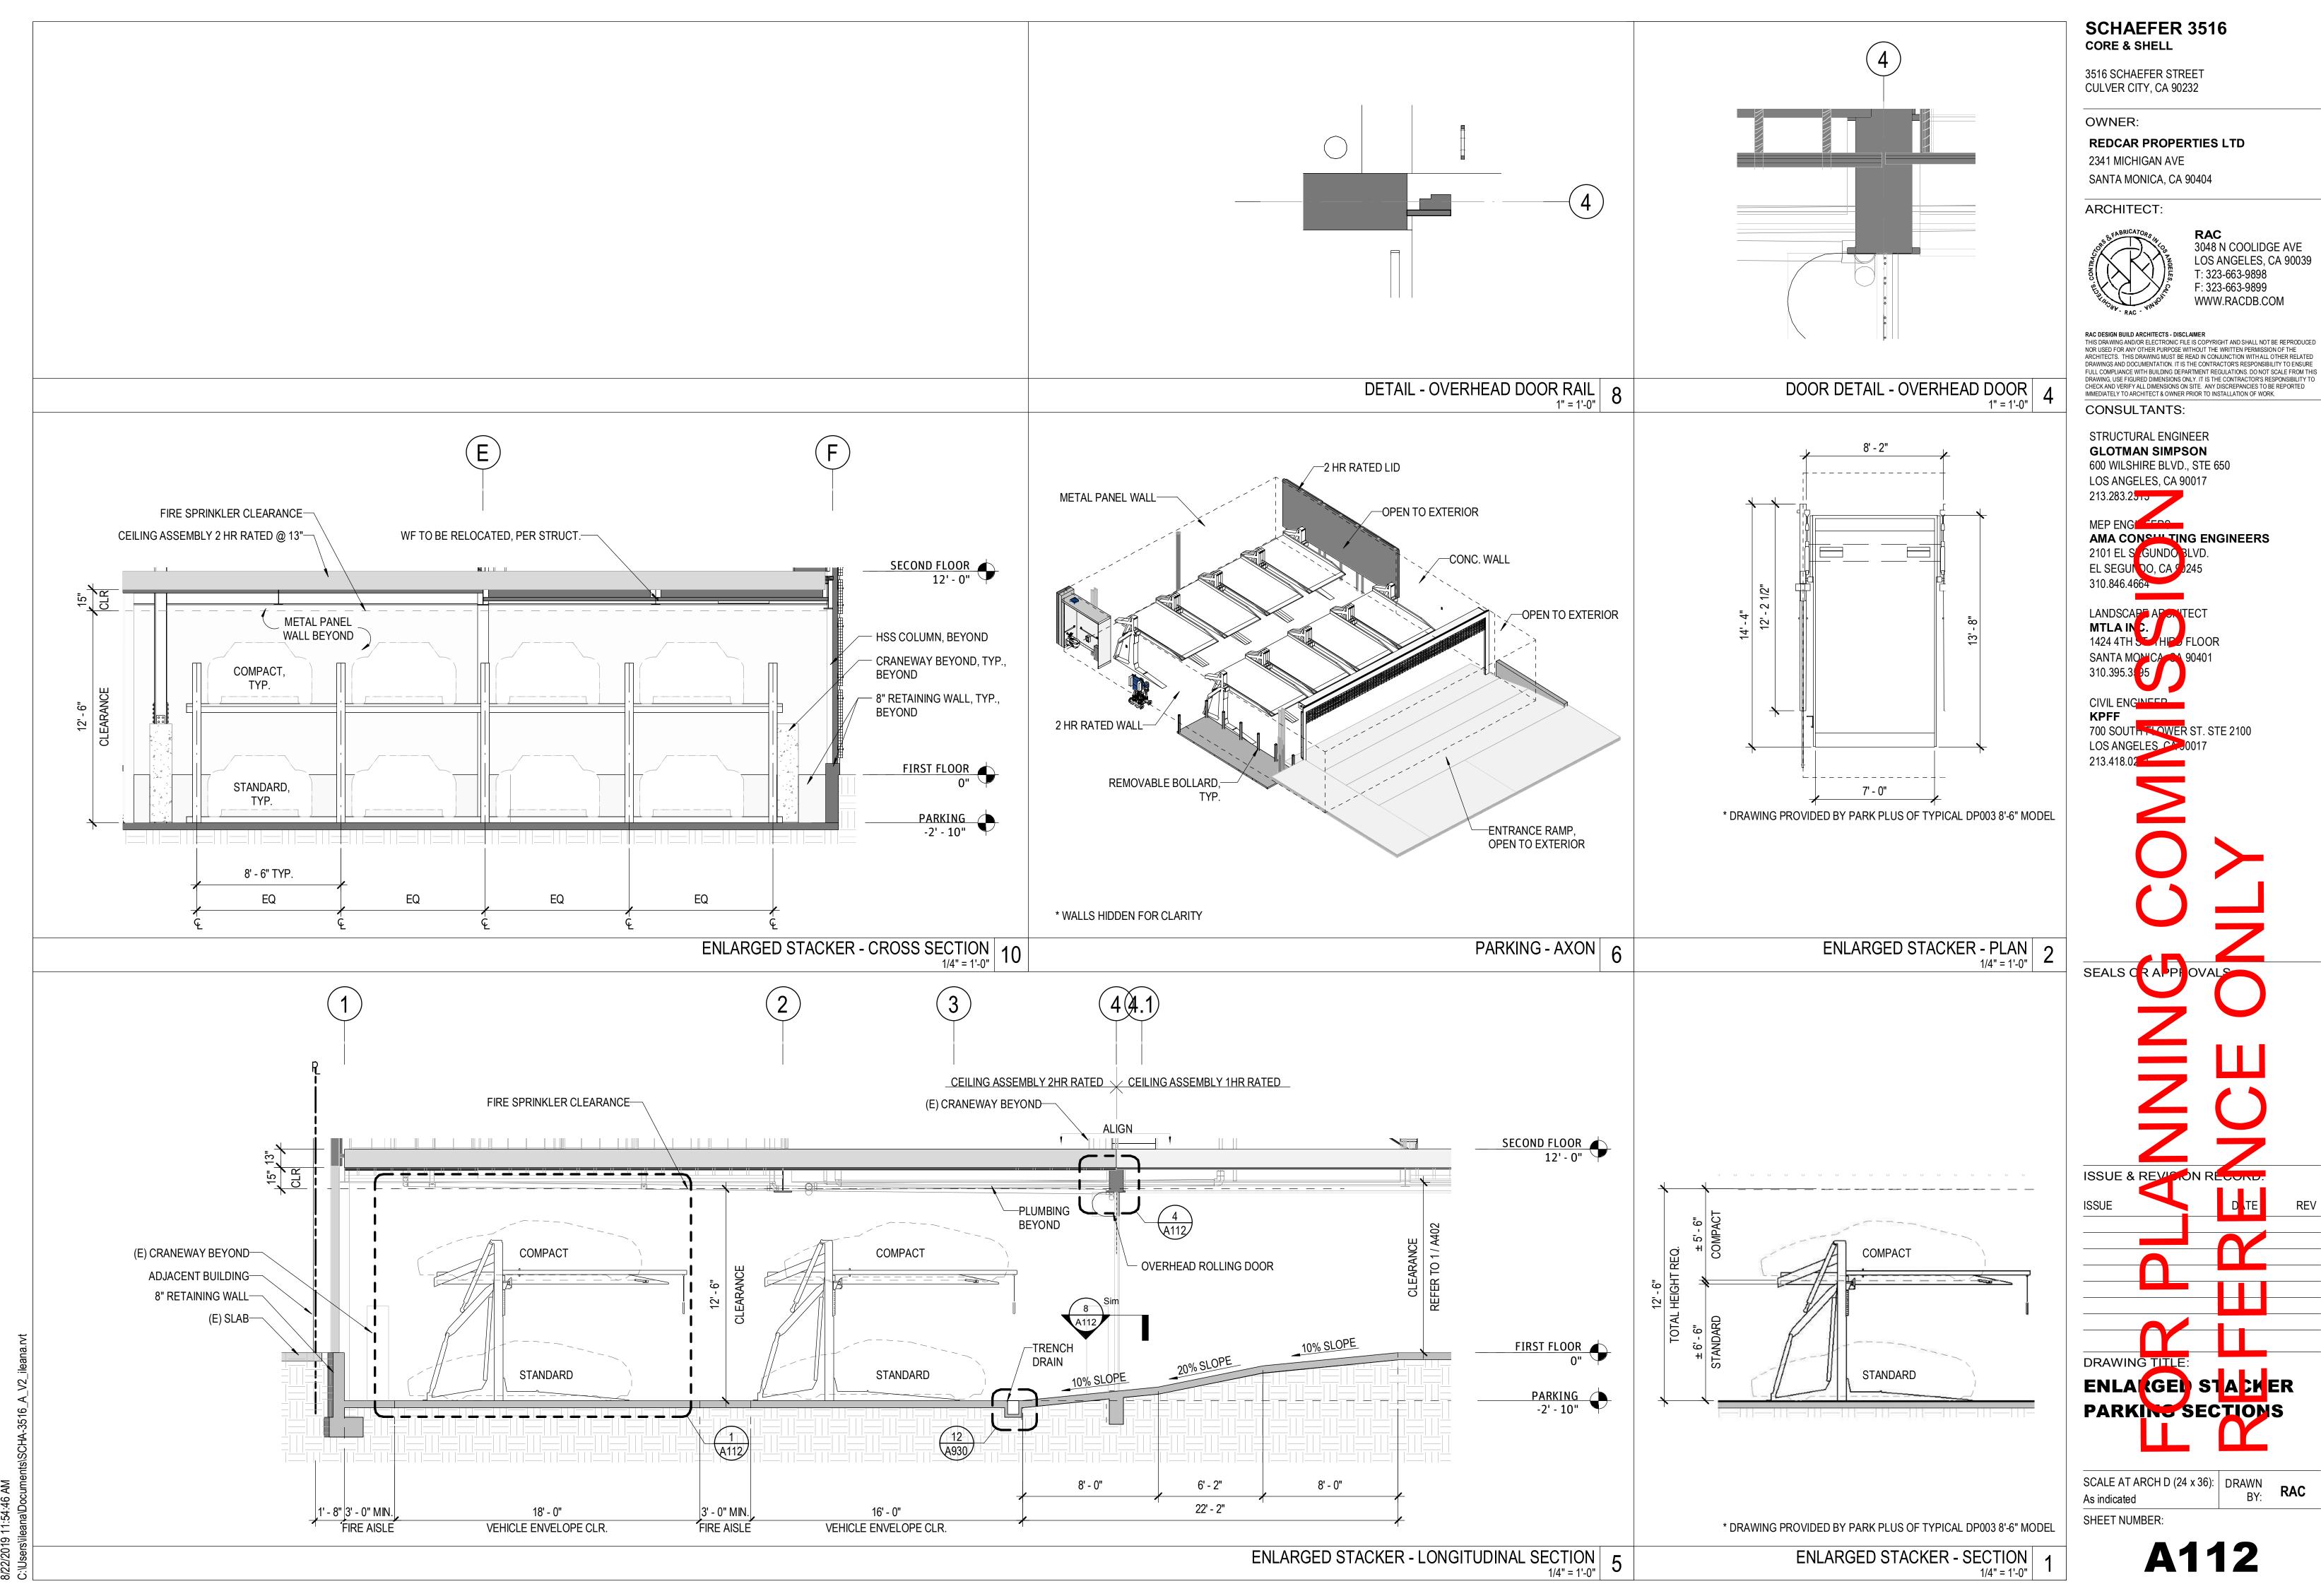

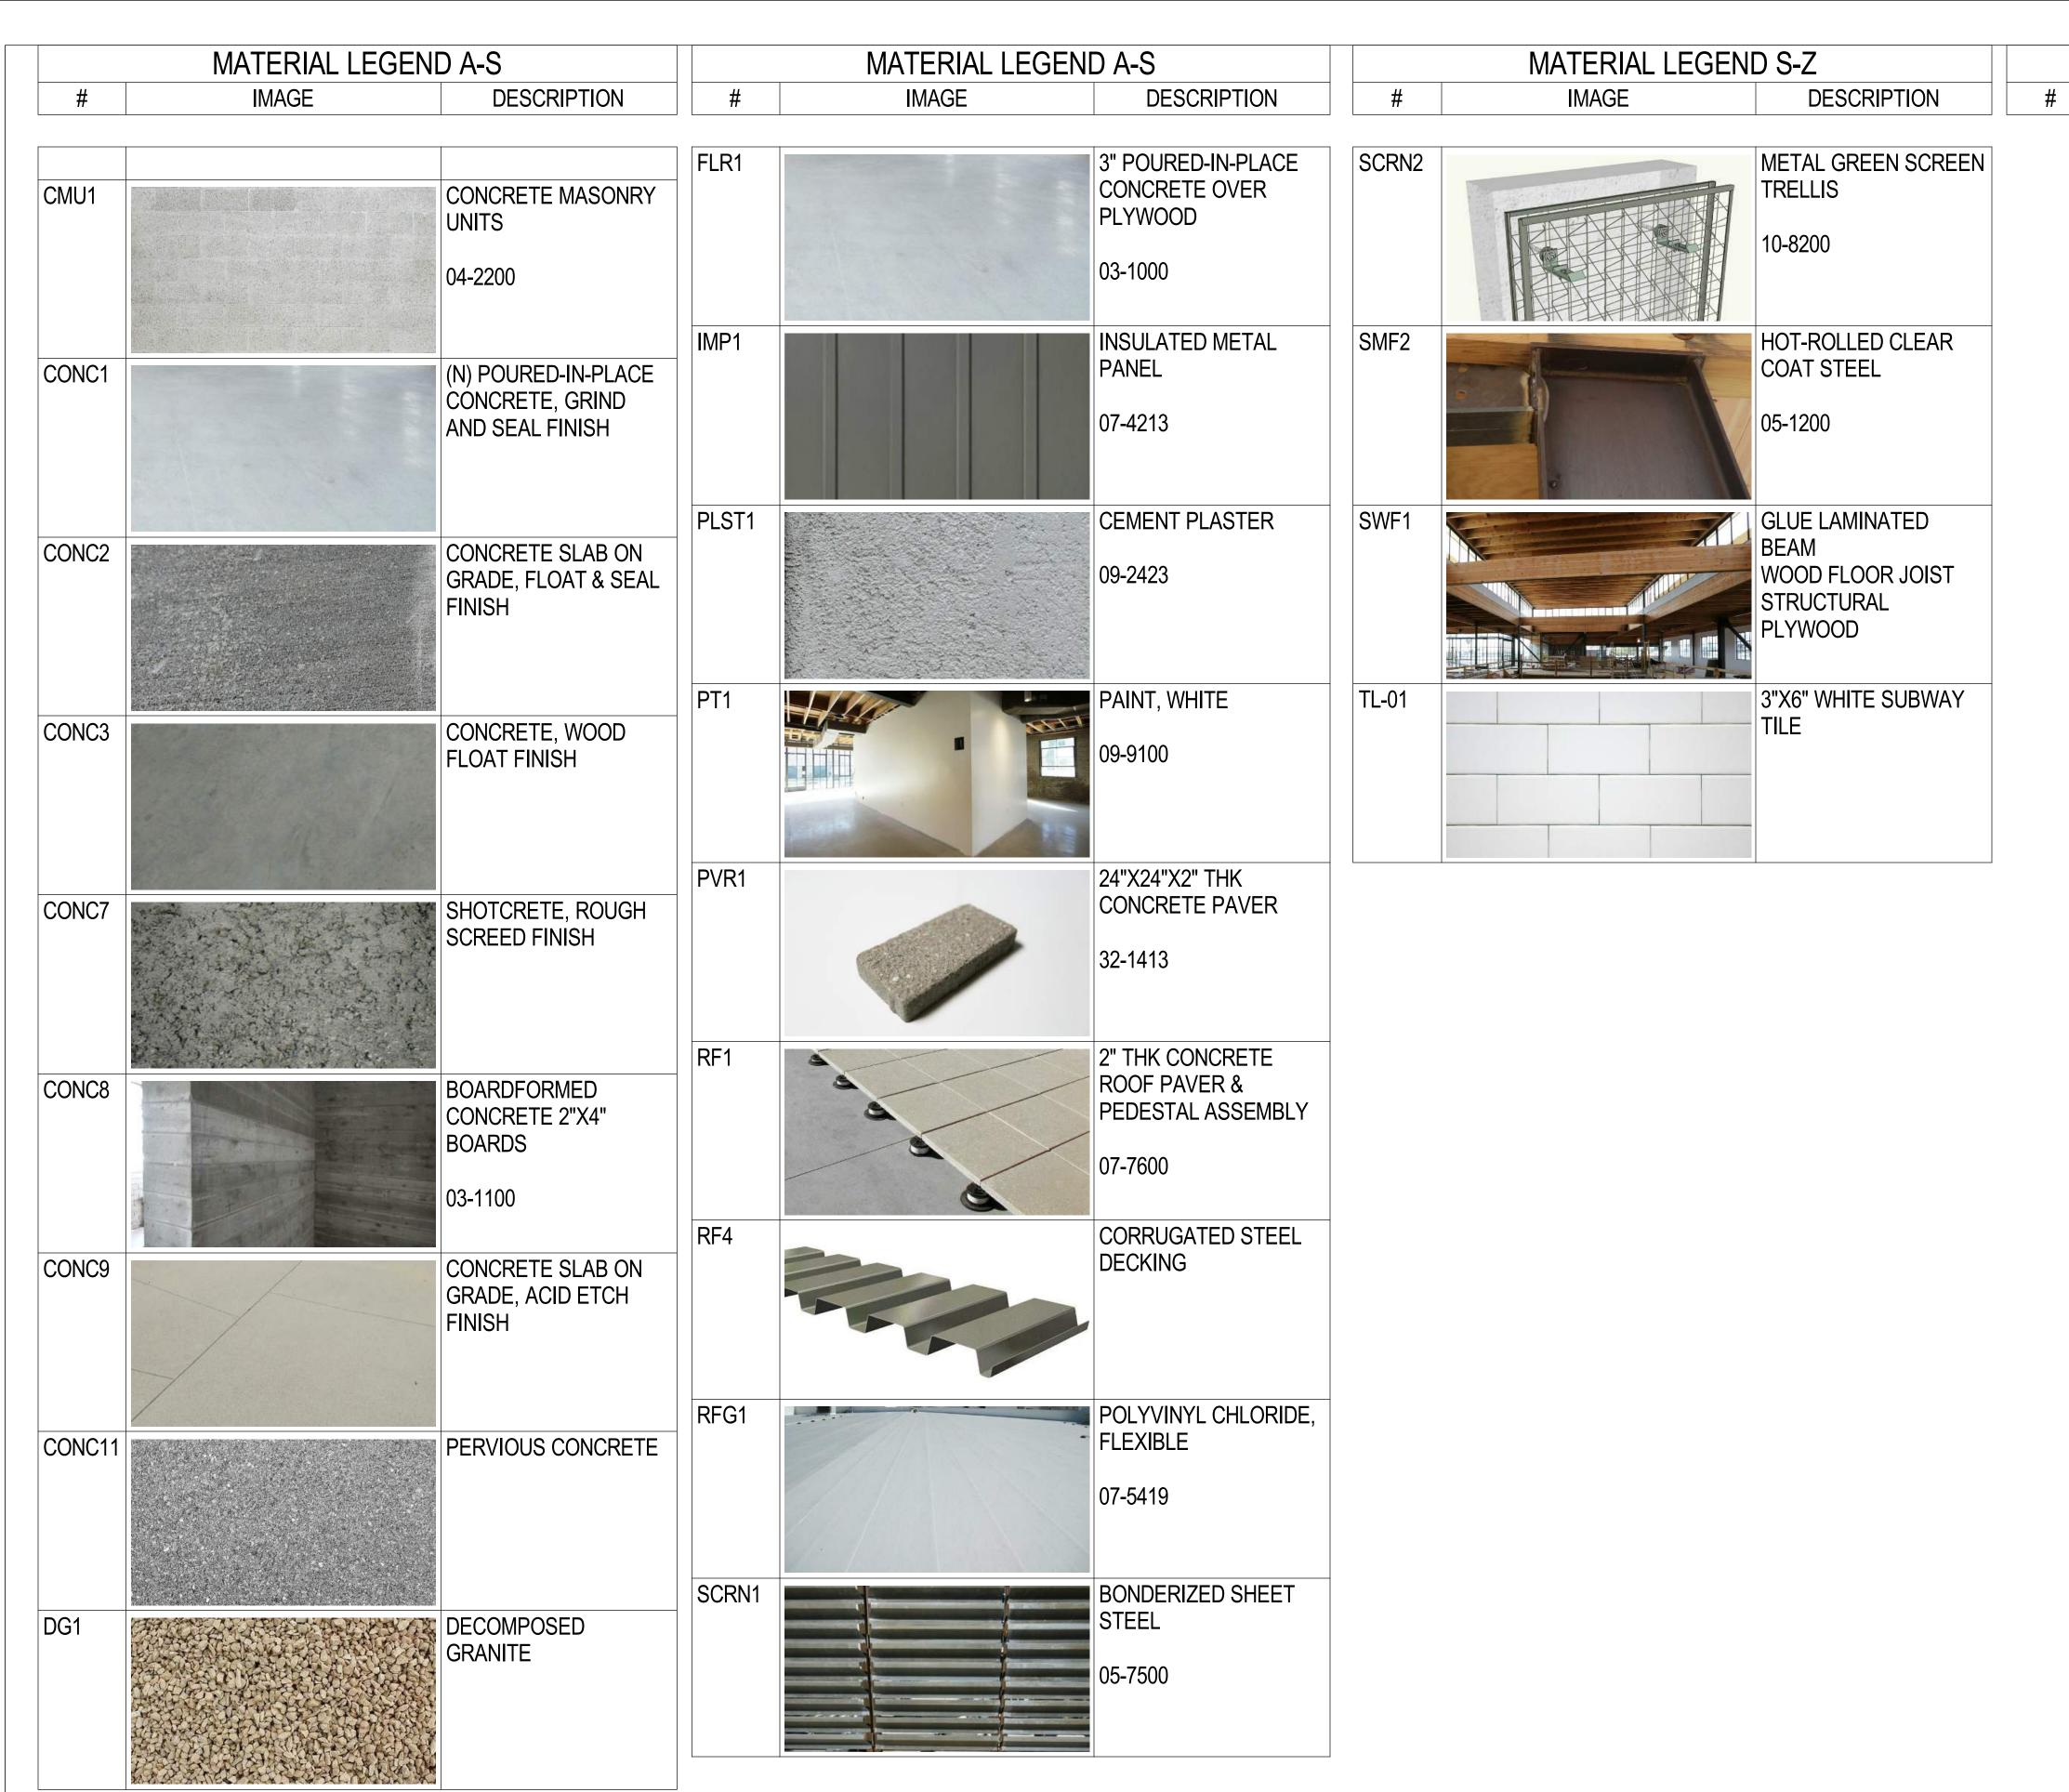

SCHAEFER 3516
CORE & SHELL

3516 SCHAEFER STREET CULVER CITY, CA 90232

OWNER:

MATERIAL LEGEND S-Z

DESCRIPTION

IMAGE

REDCAR PROPERTIES LTD

2341 MICHIGAN AVE SANTA MONICA, CA 90404

ARCHITECT:



RAC 3048 N COOLIDGE AVE LOS ANGELES, CA 90039 T: 323-663-9898 F: 323-663-9899 WWW.RACDB.COM

RAC DESIGN BUILD ARCHITECTS - DISCLAIMER

THIS DRAWING AND/OR ELECTRONIC FILE IS COPYRIGHT AND SHALL NOT BE REPRODUCED NOR USED FOR ANY OTHER PURPOSE WITHOUT THE WRITTEN PERMISSION OF THE ARCHITECTS. THIS DRAWING MUST BE READ IN CONJUNCTION WITH ALL OTHER RELATED DRAWINGS AND DOCUMENTATION. IT IS THE CONTRACTOR'S RESPONSIBILITY TO ENSURE FULL COMPLIANCE WITH BUILDING DEPARTMENT REGULATIONS. DO NOT SCALE FROM THIS DRAWING, USE FIGURED DIMENSIONS ONLY. IT IS THE CONTRACTOR'S RESPONSIBILITY TO CHECK AND VERIFY ALL DIMENSIONS ON SITE. ANY DISCREPANCIES TO BE REPORTED IMMEDIATELY TO ARCHITECT & OWNER PRIOR TO INSTALLATION OF WORK.

CONSULTANTS:

STRUCTURAL ENGINEER
GLOTMAN SIMPSON
600 WILSHIRE BLVD., STE 650
LOS ANGELES, CA 90017
213.283.2513

MEP ENGINEEDS

AMA CONSHITTING ENGINEERS

2101 EL SEGUI DO, CA 9 245

310.846.4664

LANDSCAPE APONTECT
MTLA IN C.
1424 4TH STAHIP FLOOR
SANTA MONICA CA 90401
310.395.3395

SEALS OF A DIVOY

SEALS OR APPHOVALS

ISSUE & REVISION RECORD:

ISSUE D.


DRAWING TITLE:

MATERIAL LESEND

SCALE AT ARCH D (24 x 36): DRAWN

SHEET NUMBER:

A200

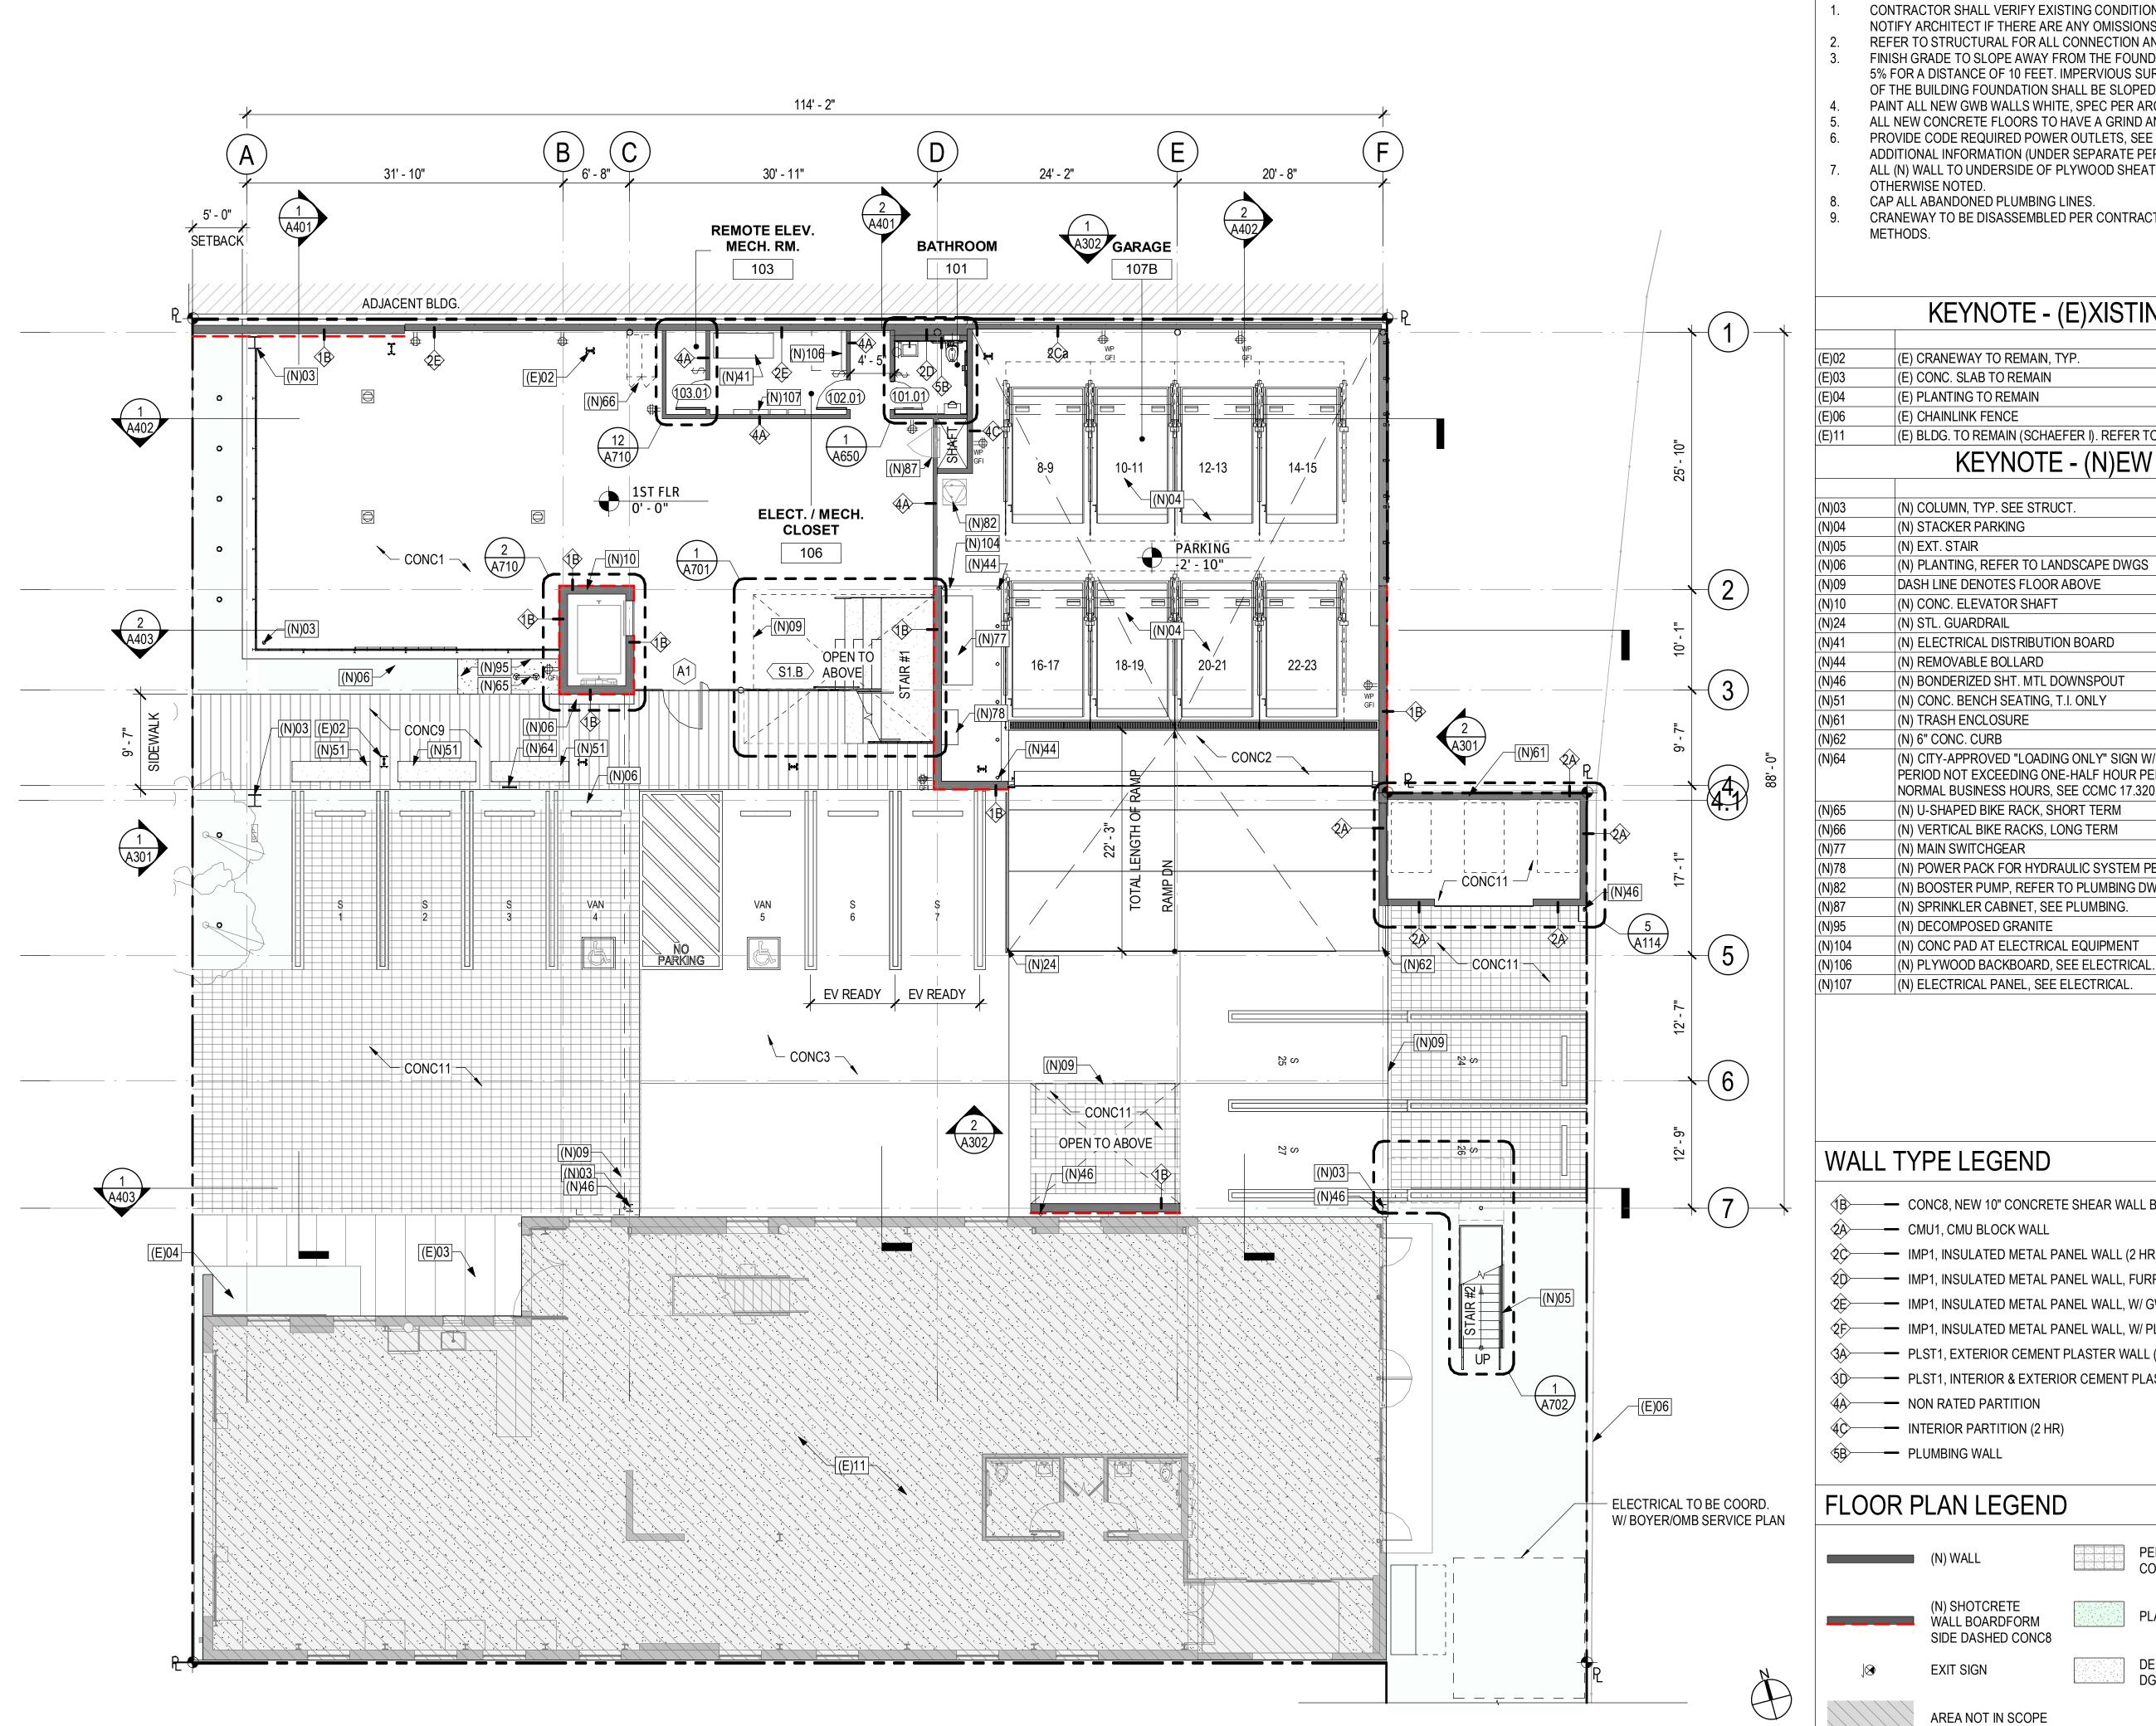

CONTRACTOR SHALL VERIFY EXISTING CONDITIONS AT JOBSITE AND NOTIFY ARCHITECT IF THERE ARE ANY OMISSIONS OR DISCREPANCIES. **SCHAEFER 3516**

REDCAR PROPERTIES LTD

RAC 3048 N COOLIDGE AVE

T: 323-663-9898

F: 323-663-9899

RAC DESIGN BUILD ARCHITECTS - DISCLAIMER
THIS DRAWING AND/OR ELECTRONIC FILE IS COPYRIGHT AND SHALL NOT BE REPRODUCED NOR USED FOR ANY OTHER PURPOSE WITHOUT THE WRITTEN PERMISSION OF THE ARCHITECTS. THIS DRAWING MUST BE READ IN CONJUNCTION WITH ALL OTHER RELATED DRAWINGS AND DOCUMENTATION. IT IS THE CONTRACTOR'S RESPONSIBILITY TO ENSURE

FULL COMPLIANCE WITH BUILDING DEPARTMENT REGULATIONS. DO NOT SCALE FROM THIS DRAWING, USE FIGURED DIMENSIONS ONLY. IT IS THE CONTRACTOR'S RESPONSIBILITY TO CHECK AND VERIFY ALL DIMENSIONS ON SITE. ANY DISCREPANCIES TO BE REPORTED IMMEDIATELY TO ARCHITECT & OWNER PRIOR TO INSTALLATION OF WORK.

WWW.RACDB.COM

LOS ANGELES, CA 90039

CORE & SHELL

OWNER:

ARCHITECT:

CONSULTANTS:

STRUCTURAL ENGINEER **GLOTMAN SIMPSON**

LOS ANGELES, CA 90017

2101 EL S. GUNDO BLVD. EL SEGUNDO, CA 90245

LANDSCAPE APONTECT

700 SOUTH FLOWER ST. STE 2100

310.395.3

213.283.2513

MEP ENG

600 WILSHIRE BLVD., STE 650

AMA CONSULTING ENGINEERS

3516 SCHAEFER STREET

CULVER CITY, CA 90232

2341 MICHIGAN AVE

SANTA MONICA, CA 90404

- REFER TO STRUCTURAL FOR ALL CONNECTION AND MEMBER SIZES. FINISH GRADE TO SLOPE AWAY FROM THE FOUNDATION A MINIMUM OF 5% FOR A DISTANCE OF 10 FEET. IMPERVIOUS SURFACES WITHIN 10 FT
- OF THE BUILDING FOUNDATION SHALL BE SLOPED A MINIMUM OF 2%. PAINT ALL NEW GWB WALLS WHITE, SPEC PER ARCHITECT. ALL NEW CONCRETE FLOORS TO HAVE A GRIND AND SEAL FINISH.
- PROVIDE CODE REQUIRED POWER OUTLETS, SEE ELECTRICAL FOR ADDITIONAL INFORMATION (UNDER SEPARATE PERMIT SUBMITTAL) ALL (N) WALL TO UNDERSIDE OF PLYWOOD SHEATHING UNLESS OTHERWISE NOTED.
- CAP ALL ABANDONED PLUMBING LINES. CRANEWAY TO BE DISASSEMBLED PER CONTRACTOR'S MEANS &

KEYNOTE - (E)XISTING

(E)02	(E) CRANEWAY TO REMAIN, TYP.
(E)03	(E) CONC. SLAB TO REMAIN
(E)04	(E) PLANTING TO REMAIN
(E)06	(E) CHAINLINK FENCE
(E)11	(E) BLDG. TO REMAIN (SCHAEFER I). REFER TO PERMIT # B16-0850.
	KEYNOTE - (N)EW
(N)03	(N) COLUMN, TYP. SEE STRUCT.
(N)04	(N) STACKER PARKING
(N)05	(N) EXT. STAIR
(N)06	(N) PLANTING, REFER TO LANDSCAPE DWGS
(N)09	DASH LINE DENOTES FLOOR ABOVE
(N)10	(N) CONC. ELEVATOR SHAFT
(N)24	(N) STL. GUARDRAIL
(N)41	(N) ELECTRICAL DISTRIBUTION BOARD
(N)44	(N) REMOVABLE BOLLARD
(N)46	(N) BONDERIZED SHT. MTL DOWNSPOUT
(N)51	(N) CONC. BENCH SEATING, T.I. ONLY
(N)61	(N) TRASH ENCLOSURE
(N)62	(N) 6" CONC. CURB
(N)64	(N) CITY-APPROVED "LOADING ONLY" SIGN W/ DESIGNATED TIME PERIOD NOT EXCEEDING ONE-HALF HOUR PER DAY DURING NORMAL BUSINESS HOURS, SEE CCMC 17.320.050.C.1.B.
(N)65	(N) U-SHAPED BIKE RACK, SHORT TERM
(N)66	(N) VERTICAL BIKE RACKS, LONG TERM
(N)77	(N) MAIN SWITCHGEAR
(N)78	(N) POWER PACK FOR HYDRAULIC SYSTEM PER PARK PLUS
(N)82	(N) BOOSTER PUMP, REFER TO PLUMBING DWGS

WALL TYPE LEGEND

— CONC8, NEW 10" CONCRETE SHEAR WALL BOARDFORM

CMU1, CMU BLOCK WALL

(N) DECOMPOSED GRANITE

✓ → IMP1, INSULATED METAL PANEL WALL (2 HR)

— IMP1, INSULATED METAL PANEL WALL, FURRED (1 HR)

— IMP1, INSULATED METAL PANEL WALL, W/ GWB FIN. (1 HR)

— IMP1, INSULATED METAL PANEL WALL, W/ PLST1 FIN. (1 HR)

PLST1, EXTERIOR CEMENT PLASTER WALL (1 HR)


PLST1, INTERIOR & EXTERIOR CEMENT PLASTER WALL (1 HR)

A NON RATED PARTITION

INTERIOR PARTITION (2 HR)

◆B PLUMBING WALL

FLOOR PLAN LEGEND

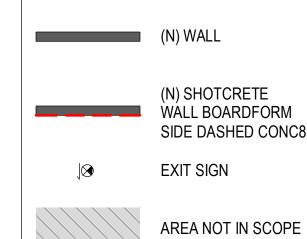

PROPOSED 1ST FLOOR PLAN

(N) SHOTCRETE WALL BOARDFORM SIDE DASHED CONC8

PERMEABLE PAVING CONC11

PLANTING AREAS

DECOMPOSED GRANITE DG1

1/8" = 1'-0" SHEET NUMBER:

DRAWING TITLE:


FIRST FLOOR PI

SCALE AT ARCH D (24 x 36): DRAWN

ISSUE & REVISION RE

A201

© 2018 RAC DESIGN BUILD, INC.

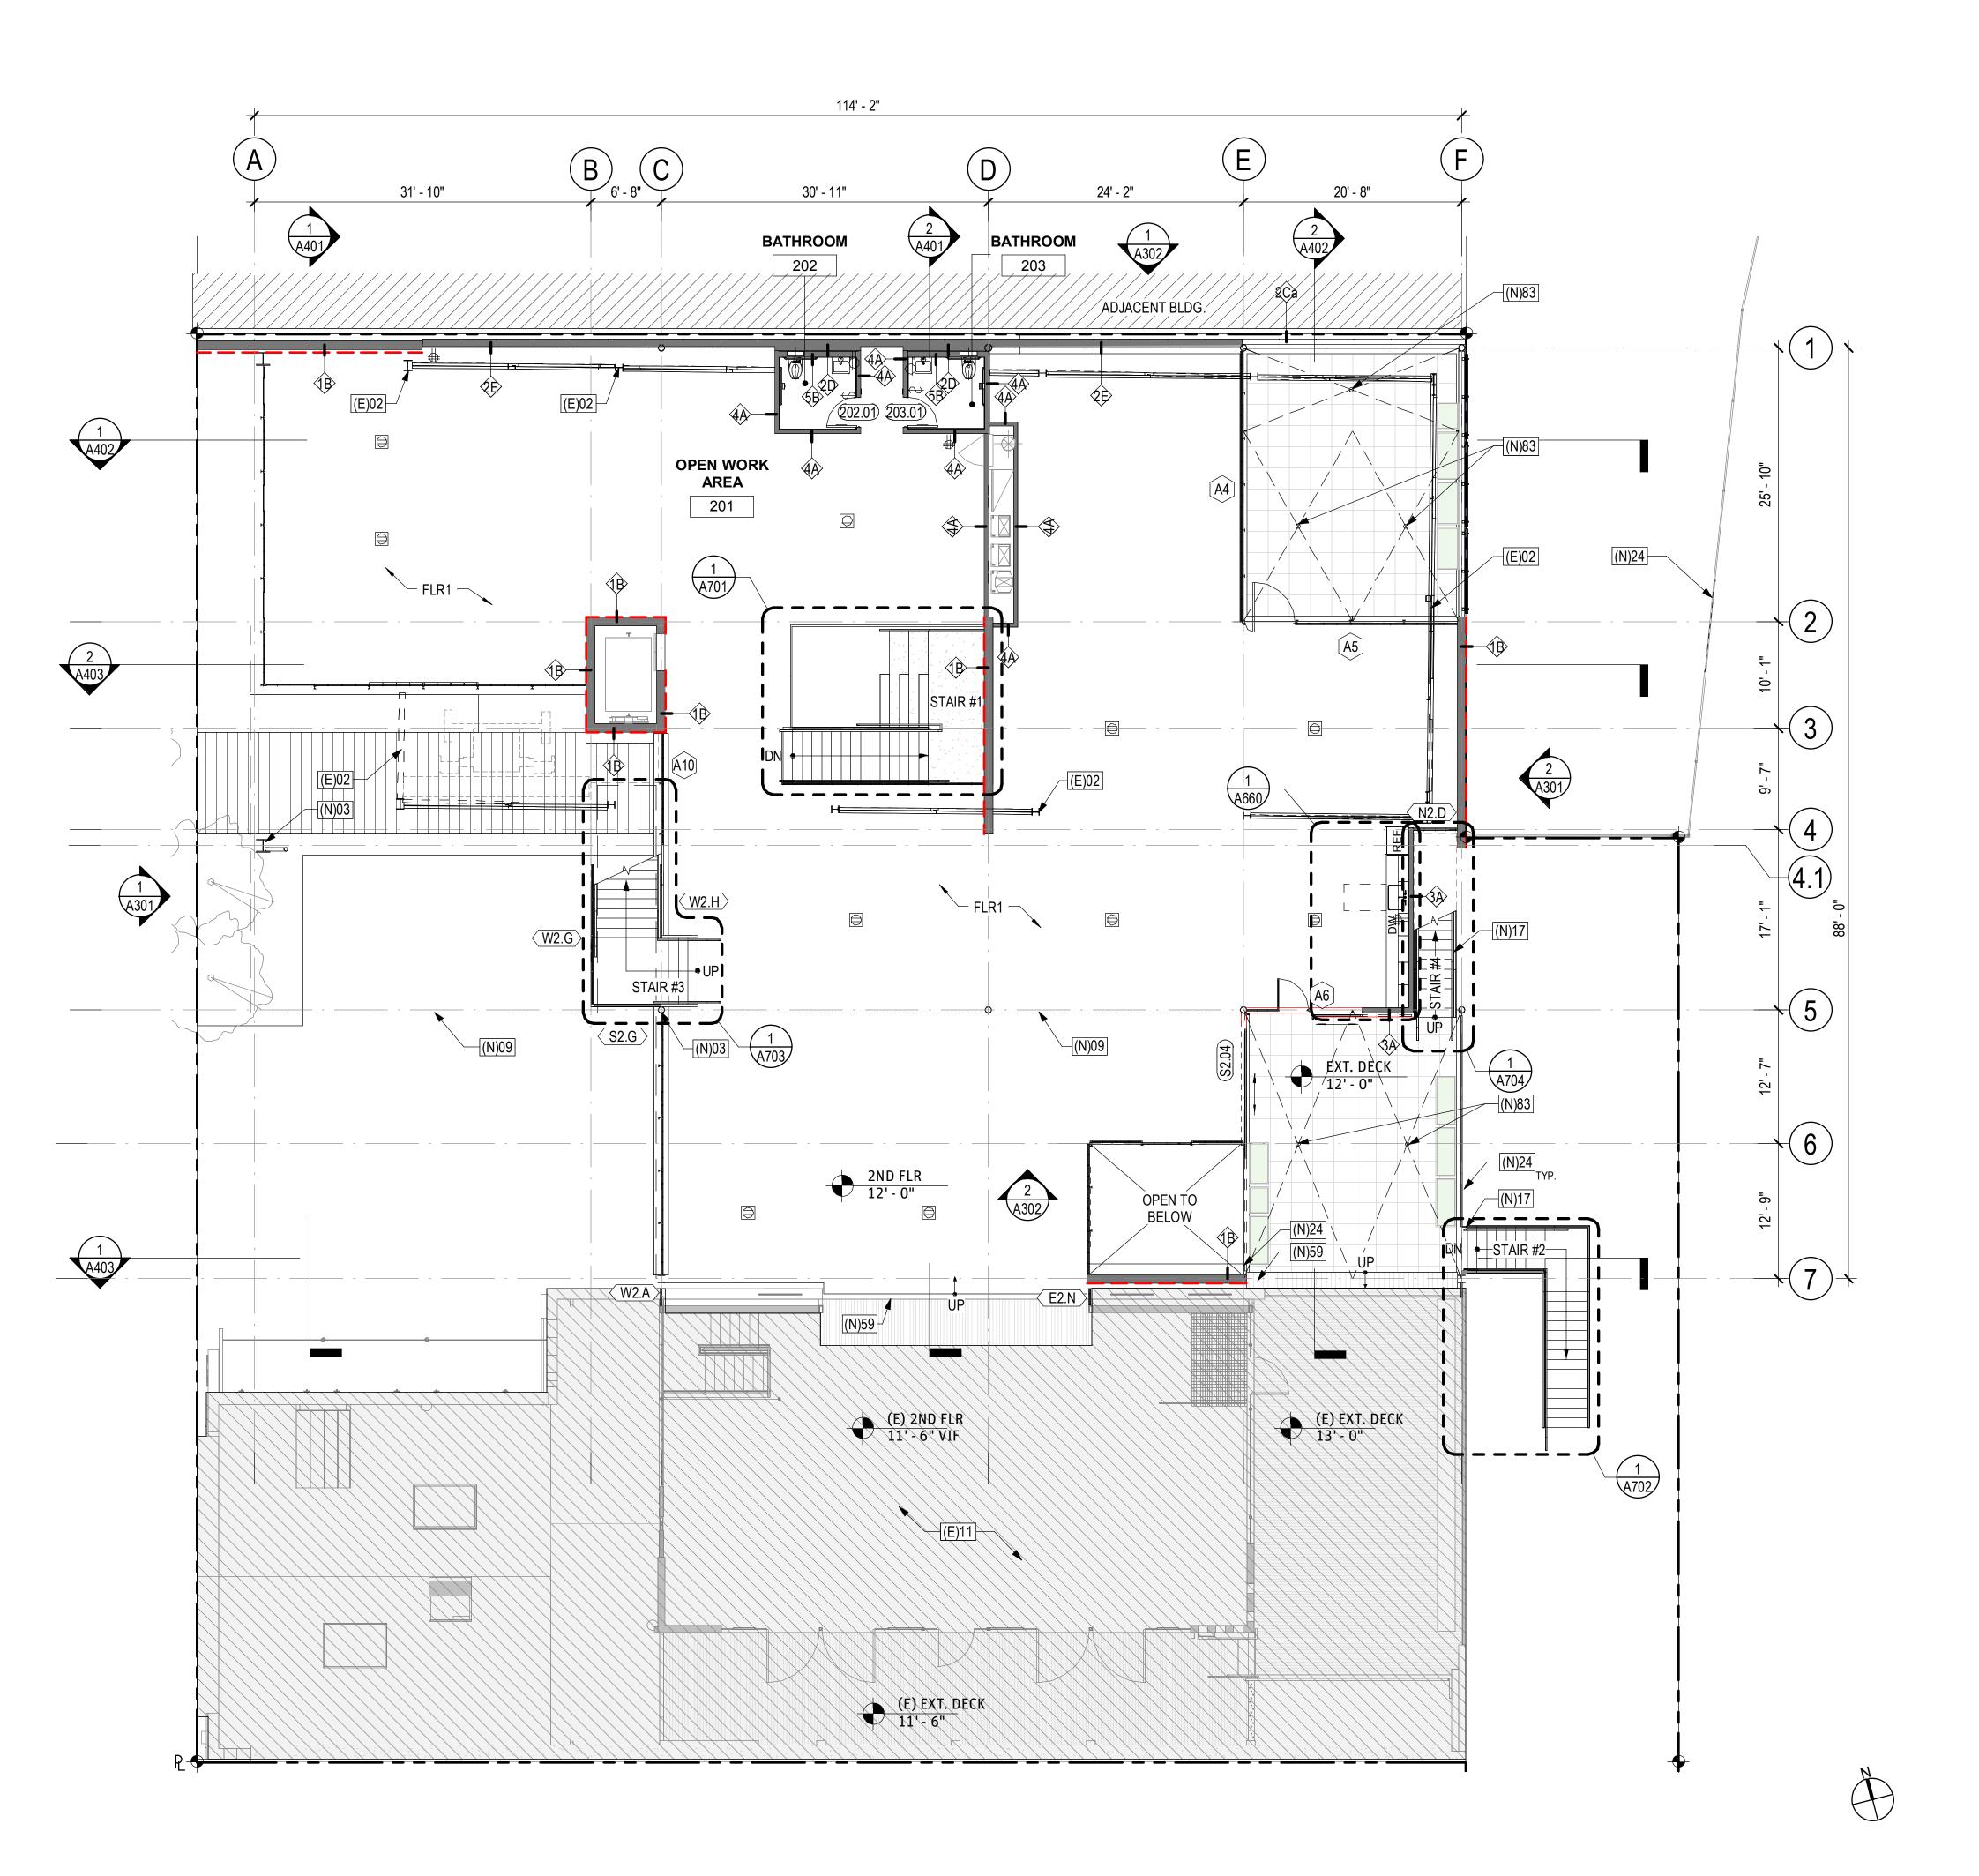

- CONTRACTOR SHALL VERIFY EXISTING CONDITIONS AT JOBSITE AND NOTIFY ARCHITECT IF THERE ARE ANY OMISSIONS OR DISCREPANCIES. REFER TO STRUCTURAL FOR ALL CONNECTION AND MEMBER SIZES.
- FINISH GRADE TO SLOPE AWAY FROM THE FOUNDATION A MINIMUM OF 5% FOR A DISTANCE OF 10 FEET. IMPERVIOUS SURFACES WITHIN 10 FT OF THE BUILDING FOUNDATION SHALL BE SLOPED A MINIMUM OF 2%. PAINT ALL NEW GWB WALLS WHITE, SPEC PER ARCHITECT.
- ALL NEW CONCRETE FLOORS TO HAVE A GRIND AND SEAL FINISH. PROVIDE CODE REQUIRED POWER OUTLETS, SEE ELECTRICAL FOR ADDITIONAL INFORMATION (UNDER SEPARATE PERMIT SUBMITTAL) ALL (N) WALL TO UNDERSIDE OF PLYWOOD SHEATHING UNLESS
- OTHERWISE NOTED. CAP ALL ABANDONED PLUMBING LINES.
- CRANEWAY TO BE DISASSEMBLED PER CONTRACTOR'S MEANS &

KEYNOTE - (E)XISTING

(E) CRANEWAY TO REMAIN, TYP. (E) BLDG. TO REMAIN (SCHAEFER I). REFER TO PERMIT # B16-0850.

KEYNOTE - (N)EW

(N) COLUMN, TYP. SEE STRUCT.
DASH LINE DENOTES FLOOR ABOVE
(N) MTL. STAIR, SEE ENLARGED PLANS AND DETAILS
(N) STL. GUARDRAIL
(N) (2) RISERS AT 4.5" EA, STEP TRANSITION ONTO (E) 3520 SCH BLD
(N) AREA DRAIN & OVERFLOW BELOW DECKING, SLOPE BELOW DECKING 1/4" PER FT.

WALL TYPE LEGEND

NON RATED PARTITION

◆B PLUMBING WALL

— INTERIOR PARTITION (2 HR)

FLOOR PLAN LEGEND

(N) SHOTCRETE WALL BOARDFORM

EXIT SIGN

SIDE DASHED CONC8

AREA NOT IN SCOPE

— CMU1, CMU BLOCK WALL

— CONC8, NEW 10" CONCRETE SHEAR WALL BOARDFORM

— IMP1, INSULATED METAL PANEL WALL, FURRED (1 HR)

PLST1, EXTERIOR CEMENT PLASTER WALL (1 HR)

— IMP1, INSULATED METAL PANEL WALL, W/ GWB FIN. (1 HR)

— IMP1, INSULATED METAL PANEL WALL, W/ PLST1 FIN. (1 HR)

PLST1, INTERIOR & EXTERIOR CEMENT PLASTER WALL (1 HR)

PERMEABLE PAVING CONC11

PLANTING AREAS

— IMP1, INSULATED METAL PANEL WALL (2 HR)

SCHAEFER 3516 **CORE & SHELL**

3516 SCHAEFER STREET CULVER CITY, CA 90232

OWNER:

REDCAR PROPERTIES LTD 2341 MICHIGAN AVE

SANTA MONICA, CA 90404

ARCHITECT:



LOS ANGELES, CA 90039 T: 323-663-9898 F: 323-663-9899 WWW.RACDB.COM

RAC DESIGN BUILD ARCHITECTS - DISCLAIMER
THIS DRAWING AND/OR ELECTRONIC FILE IS COPYRIGHT AND SHALL NOT BE REPRODUCED NOR USED FOR ANY OTHER PURPOSE WITHOUT THE WRITTEN PERMISSION OF THE ARCHITECTS. THIS DRAWING MUST BE READ IN CONJUNCTION WITH ALL OTHER RELATED DRAWINGS AND DOCUMENTATION. IT IS THE CONTRACTOR'S RESPONSIBILITY TO ENSURE

DRAWING, USE FIGURED DIMENSIONS ONLY. IT IS THE CONTRACTOR'S RESPONSIBILITY TO CHECK AND VERIFY ALL DIMENSIONS ON SITE. ANY DISCREPANCIES TO BE REPORTED IMMEDIATELY TO ARCHITECT & OWNER PRIOR TO INSTALLATION OF WORK.

CONSULTANTS:

STRUCTURAL ENGINEER **GLOTMAN SIMPSON** 600 WILSHIRE BLVD., STE 650 LOS ANGELES, CA 90017 213.283.2513

MEP ENG AMA CONSTITUTE ENGINEERS 2101 EL S. GUNDO BLVD. EL SEGUIDO, CA \$2245

700 SOUTH FLOWER ST. STE 2100




SECOND FLOOR PLAN

SCALE AT ARCH D (24 x 36): DRAWN DECOMPOSED GRANITE DG1

1/8" = 1'-0" SHEET NUMBER:

A202

PROPOSED SECOND FLOOR PLAN

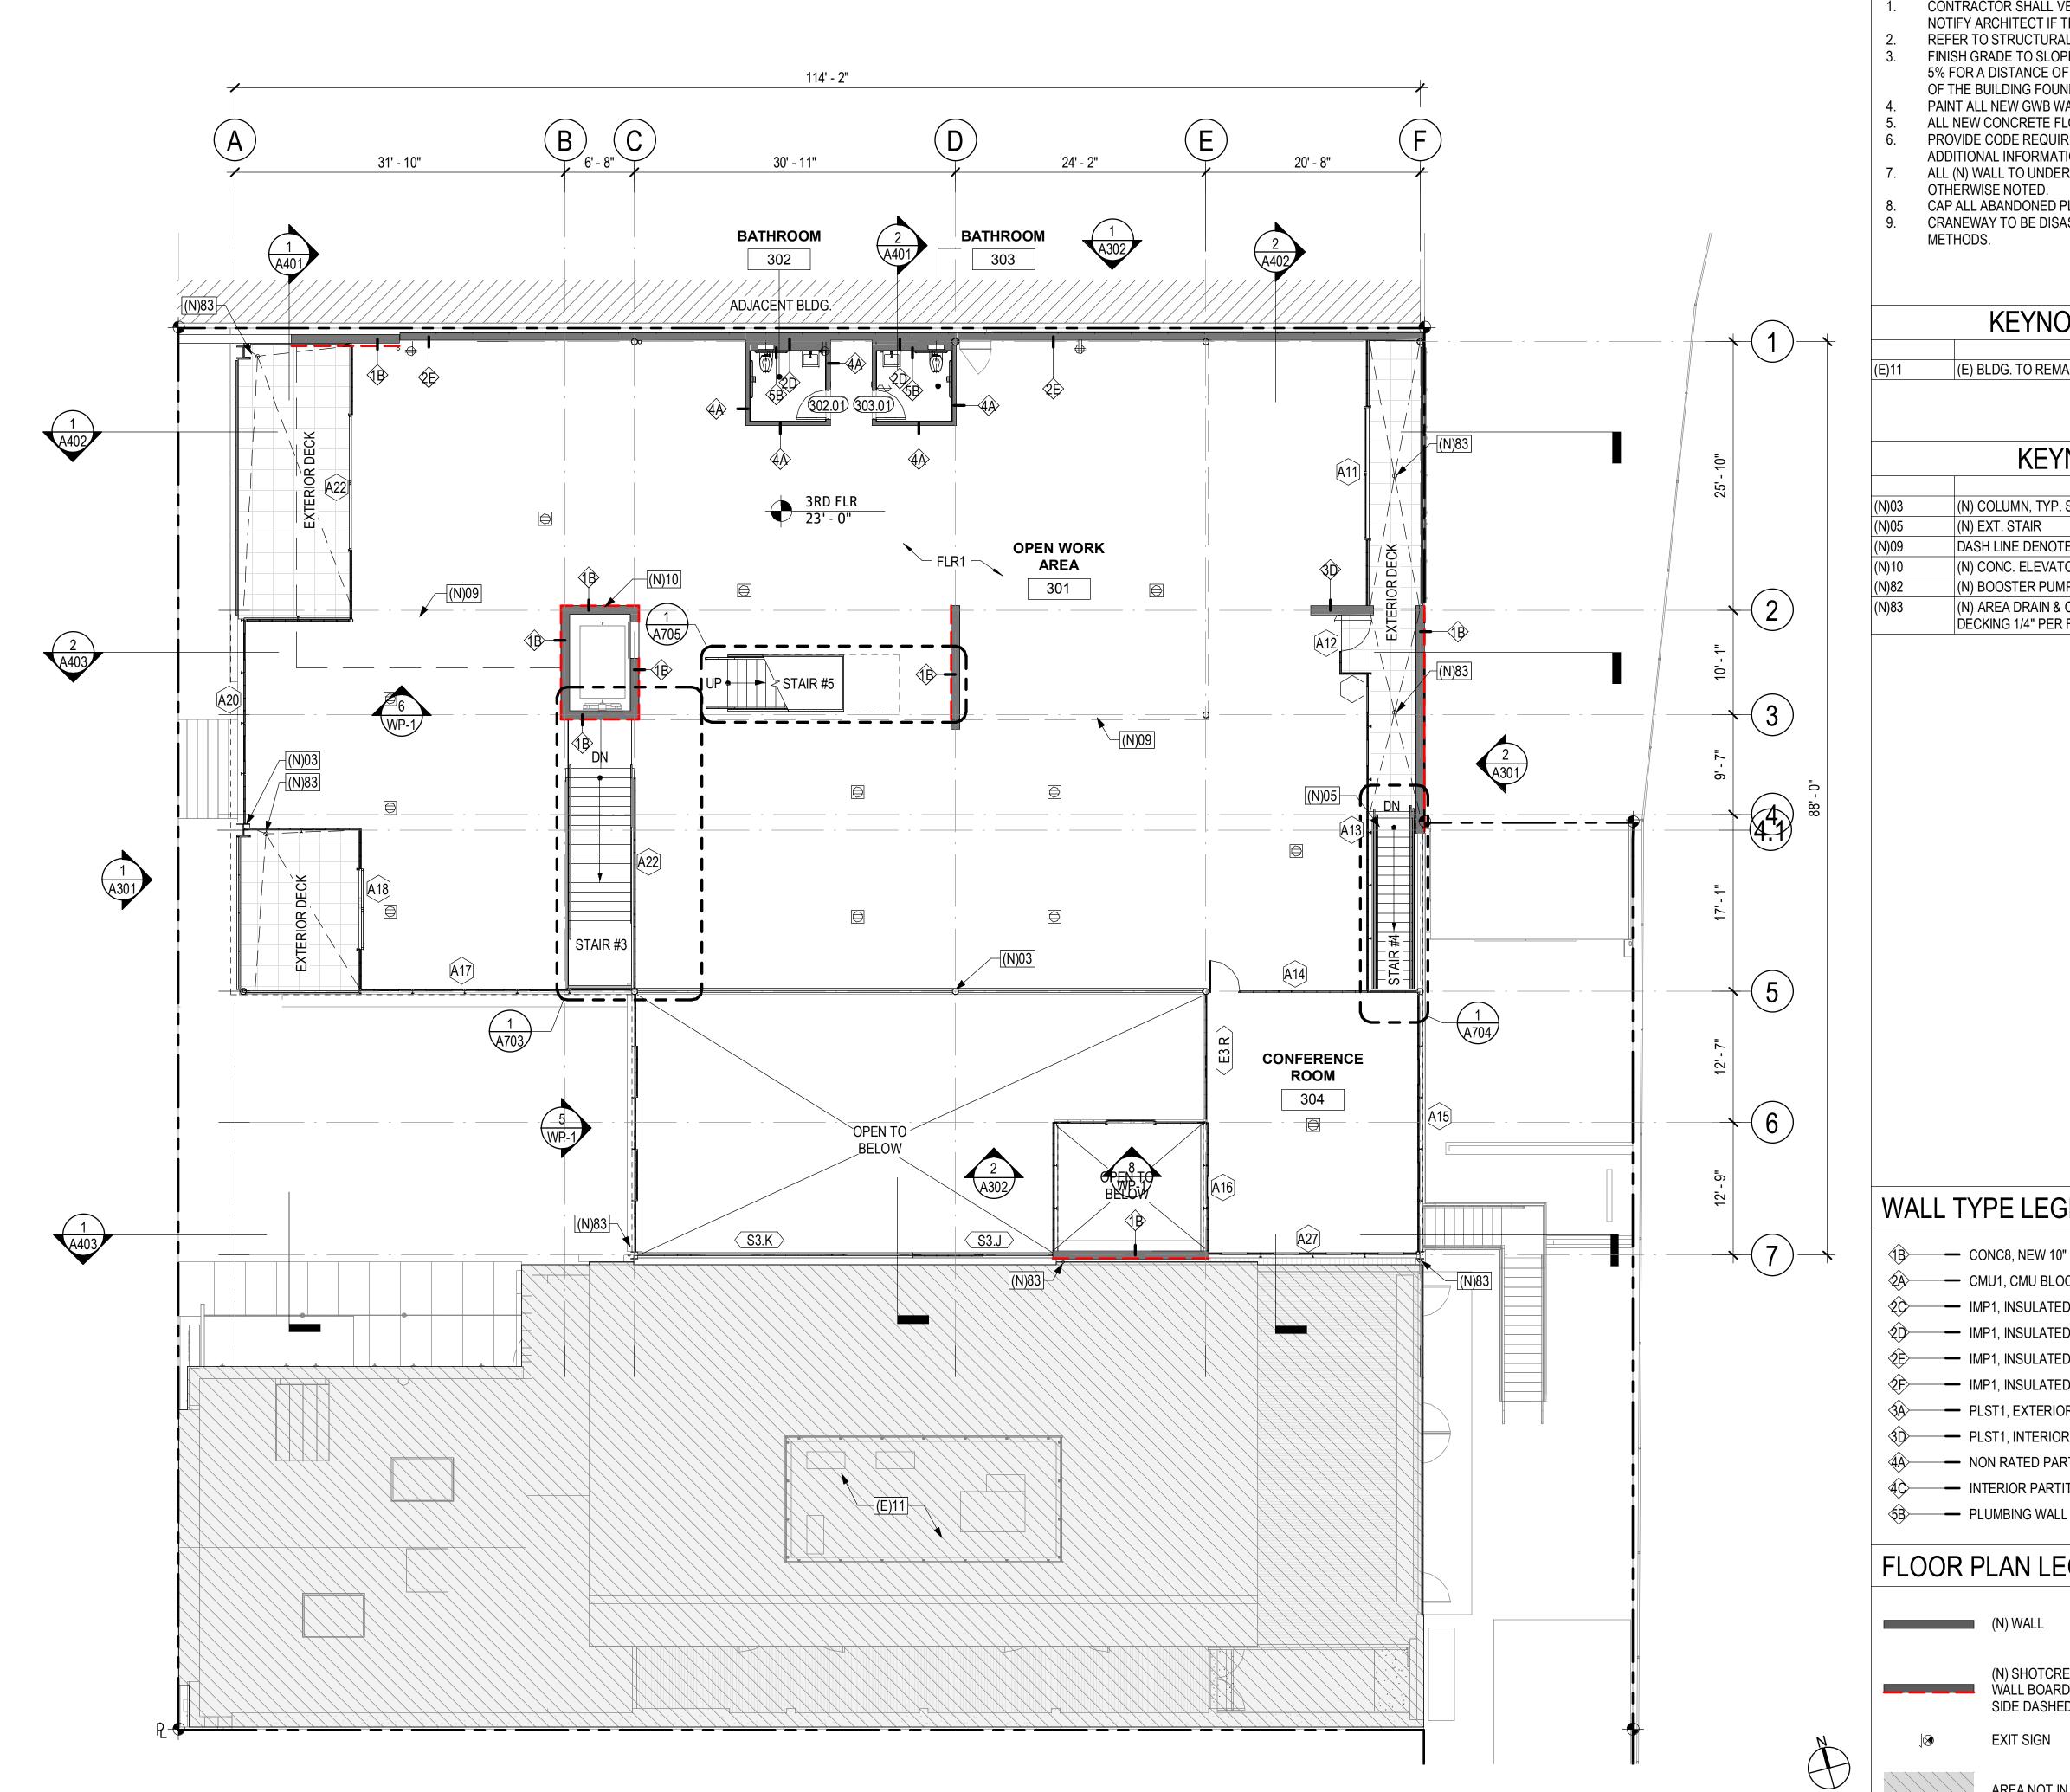

- CONTRACTOR SHALL VERIFY EXISTING CONDITIONS AT JOBSITE AND NOTIFY ARCHITECT IF THERE ARE ANY OMISSIONS OR DISCREPANCIES.
- REFER TO STRUCTURAL FOR ALL CONNECTION AND MEMBER SIZES. FINISH GRADE TO SLOPE AWAY FROM THE FOUNDATION A MINIMUM OF 5% FOR A DISTANCE OF 10 FEET. IMPERVIOUS SURFACES WITHIN 10 FT OF THE BUILDING FOUNDATION SHALL BE SLOPED A MINIMUM OF 2%.
- PAINT ALL NEW GWB WALLS WHITE, SPEC PER ARCHITECT. ALL NEW CONCRETE FLOORS TO HAVE A GRIND AND SEAL FINISH. PROVIDE CODE REQUIRED POWER OUTLETS, SEE ELECTRICAL FOR ADDITIONAL INFORMATION (UNDER SEPARATE PERMIT SUBMITTAL) ALL (N) WALL TO UNDERSIDE OF PLYWOOD SHEATHING UNLESS
- CAP ALL ABANDONED PLUMBING LINES.

CRANEWAY TO BE DISASSEMBLED PER CONTRACTOR'S MEANS & METHODS.

KEYNOTE - (E)XISTING

(E) BLDG. TO REMAIN (SCHAEFER I). REFER TO PERMIT # B16-0850.

KEYNOTE - (N)EW

N)03	(N) COLUMN, TYP. SEE STRUCT.
N)05	(N) EXT. STAIR
N)09	DASH LINE DENOTES FLOOR ABOVE
N)10	(N) CONC. ELEVATOR SHAFT
N)82	(N) BOOSTER PUMP, REFER TO PLUMBING DWGS
N)83	(N) AREA DRAIN & OVERFLOW BELOW DECKING, SLOPE BELOW DECKING 1/4" PER FT.

WALL TYPE LEGEND

CONC8, NEW 10" CONCRETE SHEAR WALL BOARDFORM

CMU1, CMU BLOCK WALL

✓ IMP1, INSULATED METAL PANEL WALL (2 HR)

— IMP1, INSULATED METAL PANEL WALL, FURRED (1 HR)

— IMP1, INSULATED METAL PANEL WALL, W/ GWB FIN. (1 HR)

— IMP1, INSULATED METAL PANEL WALL, W/ PLST1 FIN. (1 HR)


PLST1, EXTERIOR CEMENT PLASTER WALL (1 HR)

PLST1, INTERIOR & EXTERIOR CEMENT PLASTER WALL (1 HR)

NON RATED PARTITION

— INTERIOR PARTITION (2 HR)

FLOOR PLAN LEGEND

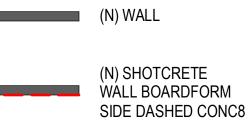

THIRD FLOOR PLAN
1/8" = 1'-0"

(N) SHOTCRETE WALL BOARDFORM

EXIT SIGN

AREA NOT IN SCOPE

PERMEABLE PAVING CONC11

PLANTING AREAS

DECOMPOSED GRANITE DG1

SCHAEFER 3516 **CORE & SHELL**

3516 SCHAEFER STREET CULVER CITY, CA 90232

OWNER:

REDCAR PROPERTIES LTD 2341 MICHIGAN AVE

SANTA MONICA, CA 90404

ARCHITECT:



RAC 3048 N COOLIDGE AVE LOS ANGELES, CA 90039 T: 323-663-9898 F: 323-663-9899 WWW.RACDB.COM

RAC DESIGN BUILD ARCHITECTS - DISCLAIMER
THIS DRAWING AND/OR ELECTRONIC FILE IS COPYRIGHT AND SHALL NOT BE REPRODUCED NOR USED FOR ANY OTHER PURPOSE WITHOUT THE WRITTEN PERMISSION OF THE ARCHITECTS. THIS DRAWING MUST BE READ IN CONJUNCTION WITH ALL OTHER RELATED DRAWINGS AND DOCUMENTATION. IT IS THE CONTRACTOR'S RESPONSIBILITY TO ENSURE FULL COMPLIANCE WITH BUILDING DEPARTMENT REGULATIONS. DO NOT SCALE FROM THIS

DRAWING, USE FIGURED DIMENSIONS ONLY. IT IS THE CONTRACTOR'S RESPONSIBILITY TO CHECK AND VERIFY ALL DIMENSIONS ON SITE. ANY DISCREPANCIES TO BE REPORTED IMMEDIATELY TO ARCHITECT & OWNER PRIOR TO INSTALLATION OF WORK. CONSULTANTS:

STRUCTURAL ENGINEER **GLOTMAN SIMPSON** 600 WILSHIRE BLVD., STE 650 LOS ANGELES, CA 90017 213.283.2513

MEP ENG AMA CONSULTING ENGINEERS 2101 EL S. GUNDO BLVD. EL SEGUNDO, CA 90245


310.395.3

700 SOUTH FLOWER ST. STE 2100

DRAWING TITLE: THIRE FLOOR P

SCALE AT ARCH D (24 x 36): DRAWN 1/8" = 1'-0"

SHEET NUMBER: **A203**

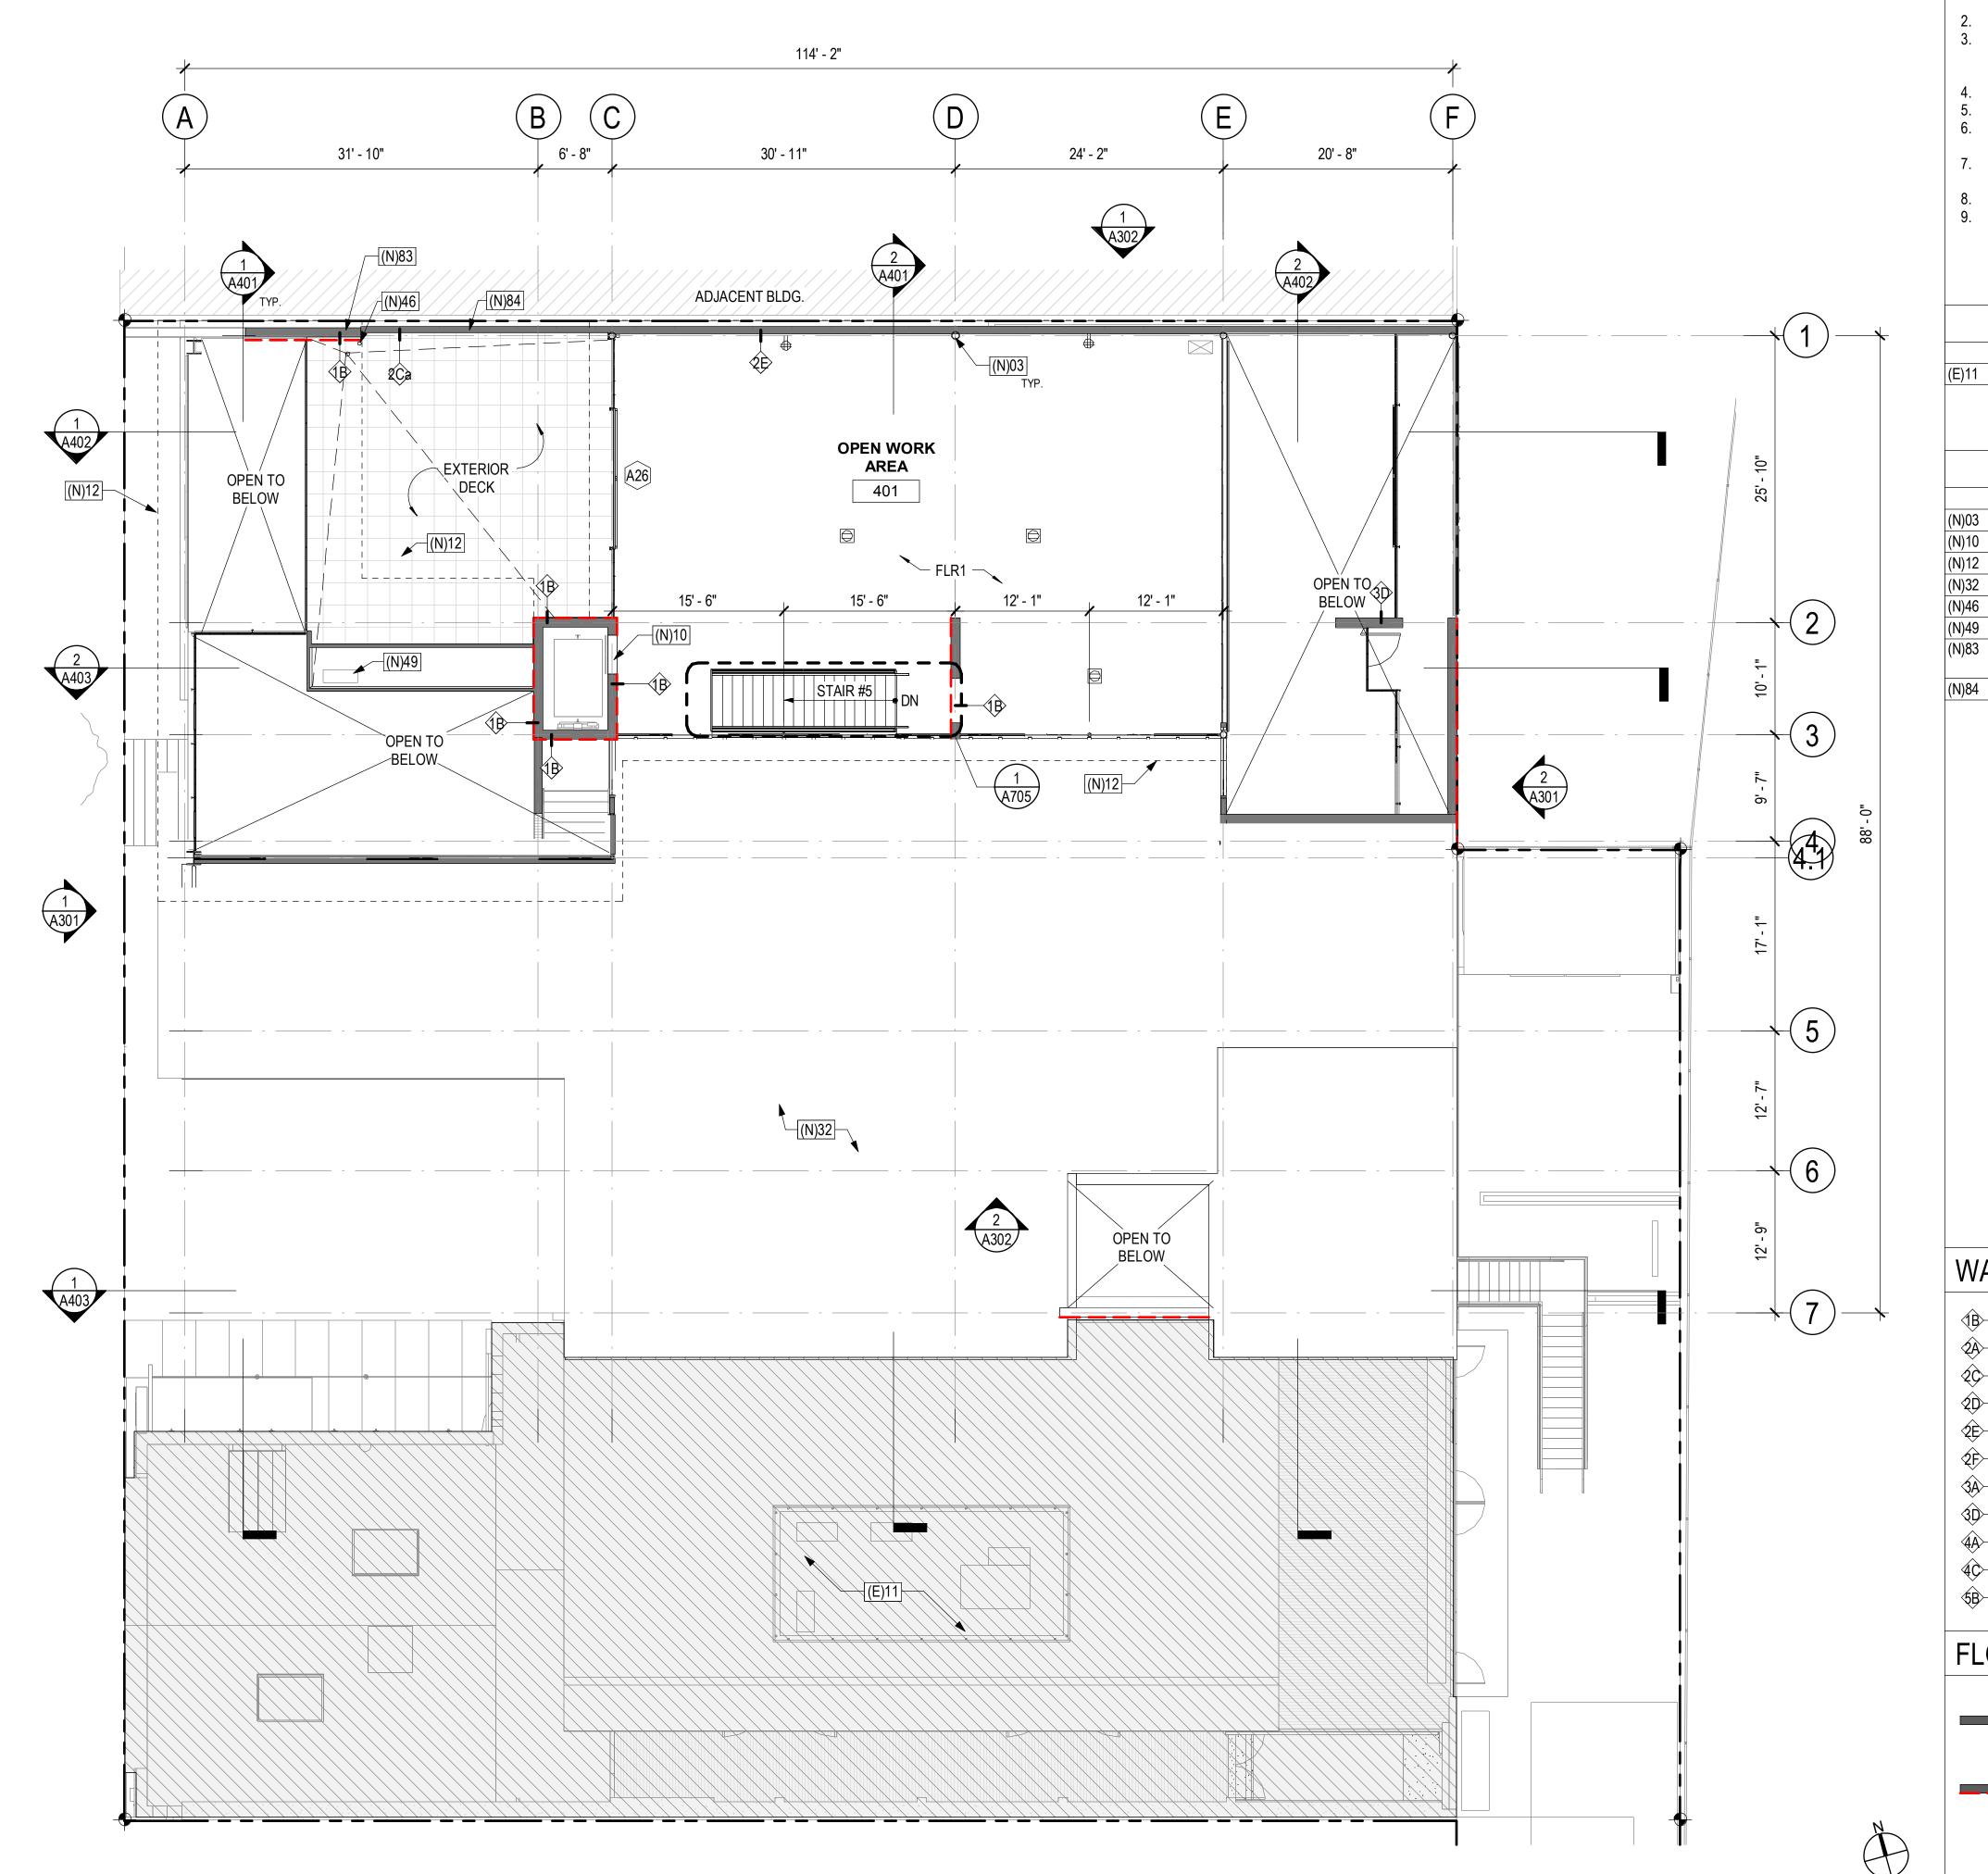

- CONTRACTOR SHALL VERIFY EXISTING CONDITIONS AT JOBSITE AND NOTIFY ARCHITECT IF THERE ARE ANY OMISSIONS OR DISCREPANCIES.
- REFER TO STRUCTURAL FOR ALL CONNECTION AND MEMBER SIZES. FINISH GRADE TO SLOPE AWAY FROM THE FOUNDATION A MINIMUM OF 5% FOR A DISTANCE OF 10 FEET. IMPERVIOUS SURFACES WITHIN 10 FT OF THE BUILDING FOUNDATION SHALL BE SLOPED A MINIMUM OF 2%.
- ALL NEW CONCRETE FLOORS TO HAVE A GRIND AND SEAL FINISH. PROVIDE CODE REQUIRED POWER OUTLETS, SEE ELECTRICAL FOR ADDITIONAL INFORMATION (UNDER SEPARATE PERMIT SUBMITTAL) ALL (N) WALL TO UNDERSIDE OF PLYWOOD SHEATHING UNLESS

PAINT ALL NEW GWB WALLS WHITE, SPEC PER ARCHITECT.

- OTHERWISE NOTED. CAP ALL ABANDONED PLUMBING LINES.
- CRANEWAY TO BE DISASSEMBLED PER CONTRACTOR'S MEANS & METHODS.

KEYNOTE - (E)XISTING

(E) BLDG. TO REMAIN (SCHAEFER I). REFER TO PERMIT # B16-0850.

KEYNOTE - (N)EW

(N)03	(N) COLUMN, TYP. SEE STRUCT.
(N)10	(N) CONC. ELEVATOR SHAFT
(N)12	(N) LINE OF ROOF ABOVE.
(N)32	(N) SLOPE ROOF, MATCH (E) SLOPE OF ADJ. BLDG. (SCHAEFER I)
(N)46	(N) BONDERIZED SHT. MTL DOWNSPOUT
(N)49	(N) MECHANICAL UNIT, UNDER SEPARATE PERMIT
(N)83	(N) AREA DRAIN & OVERFLOW BELOW DECKING, SLOPE BELOW DECKING 1/4" PER FT.
(N)84	(N) TOP OF WALL 42" AFF

WALL TYPE LEGEND

— CONC8, NEW 10" CONCRETE SHEAR WALL BOARDFORM

CMU1, CMU BLOCK WALL

✓C — IMP1, INSULATED METAL PANEL WALL (2 HR)

— IMP1, INSULATED METAL PANEL WALL, FURRED (1 HR)

— IMP1, INSULATED METAL PANEL WALL, W/ GWB FIN. (1 HR)

— IMP1, INSULATED METAL PANEL WALL, W/ PLST1 FIN. (1 HR)


PLST1, EXTERIOR CEMENT PLASTER WALL (1 HR)

PLST1, INTERIOR & EXTERIOR CEMENT PLASTER WALL (1 HR)

← NON RATED PARTITION

— INTERIOR PARTITION (2 HR) ◆B PLUMBING WALL

FLOOR PLAN LEGEND

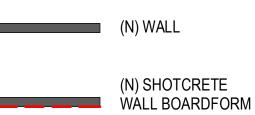

EXIT SIGN

SIDE DASHED CONC8

AREA NOT IN SCOPE

PLANTING AREAS

DECOMPOSED GRANITE DG1

SHEET NUMBER:

A204

THIRD FLOOR MEZZANINE FLOORPLAN

SCHAEFER 3516 **CORE & SHELL**

3516 SCHAEFER STREET CULVER CITY, CA 90232

OWNER: REDCAR PROPERTIES LTD

2341 MICHIGAN AVE SANTA MONICA, CA 90404

ARCHITECT:



RAC 3048 N COOLIDGE AVE LOS ANGELES, CA 90039 T: 323-663-9898

F: 323-663-9899 WWW.RACDB.COM

RAC DESIGN BUILD ARCHITECTS - DISCLAIMER
THIS DRAWING AND/OR ELECTRONIC FILE IS COPYRIGHT AND SHALL NOT BE REPRODUCED NOR USED FOR ANY OTHER PURPOSE WITHOUT THE WRITTEN PERMISSION OF THE ARCHITECTS. THIS DRAWING MUST BE READ IN CONJUNCTION WITH ALL OTHER RELATED DRAWINGS AND DOCUMENTATION. IT IS THE CONTRACTOR'S RESPONSIBILITY TO ENSURE FULL COMPLIANCE WITH BUILDING DEPARTMENT REGULATIONS. DO NOT SCALE FROM THIS DRAWING, USE FIGURED DIMENSIONS ONLY. IT IS THE CONTRACTOR'S RESPONSIBILITY TO CHECK AND VERIFY ALL DIMENSIONS ON SITE. ANY DISCREPANCIES TO BE REPORTED IMMEDIATELY TO ARCHITECT & OWNER PRIOR TO INSTALLATION OF WORK.

CONSULTANTS:

STRUCTURAL ENGINEER **GLOTMAN SIMPSON** 600 WILSHIRE BLVD., STE 650 LOS ANGELES, CA 90017 213.283.2513


MEP ENG AMA CONSULTING ENGINEERS

700 SOUTH FLOWER ST. STE 2100

DRAWING TITLE THIRU FLOOR MEZZANINE FLOOR

SCALE AT ARCH D (24 x 36): DRAWN 1/8" = 1'-0"

© 2018 RAC DESIGN BUILD, INC.

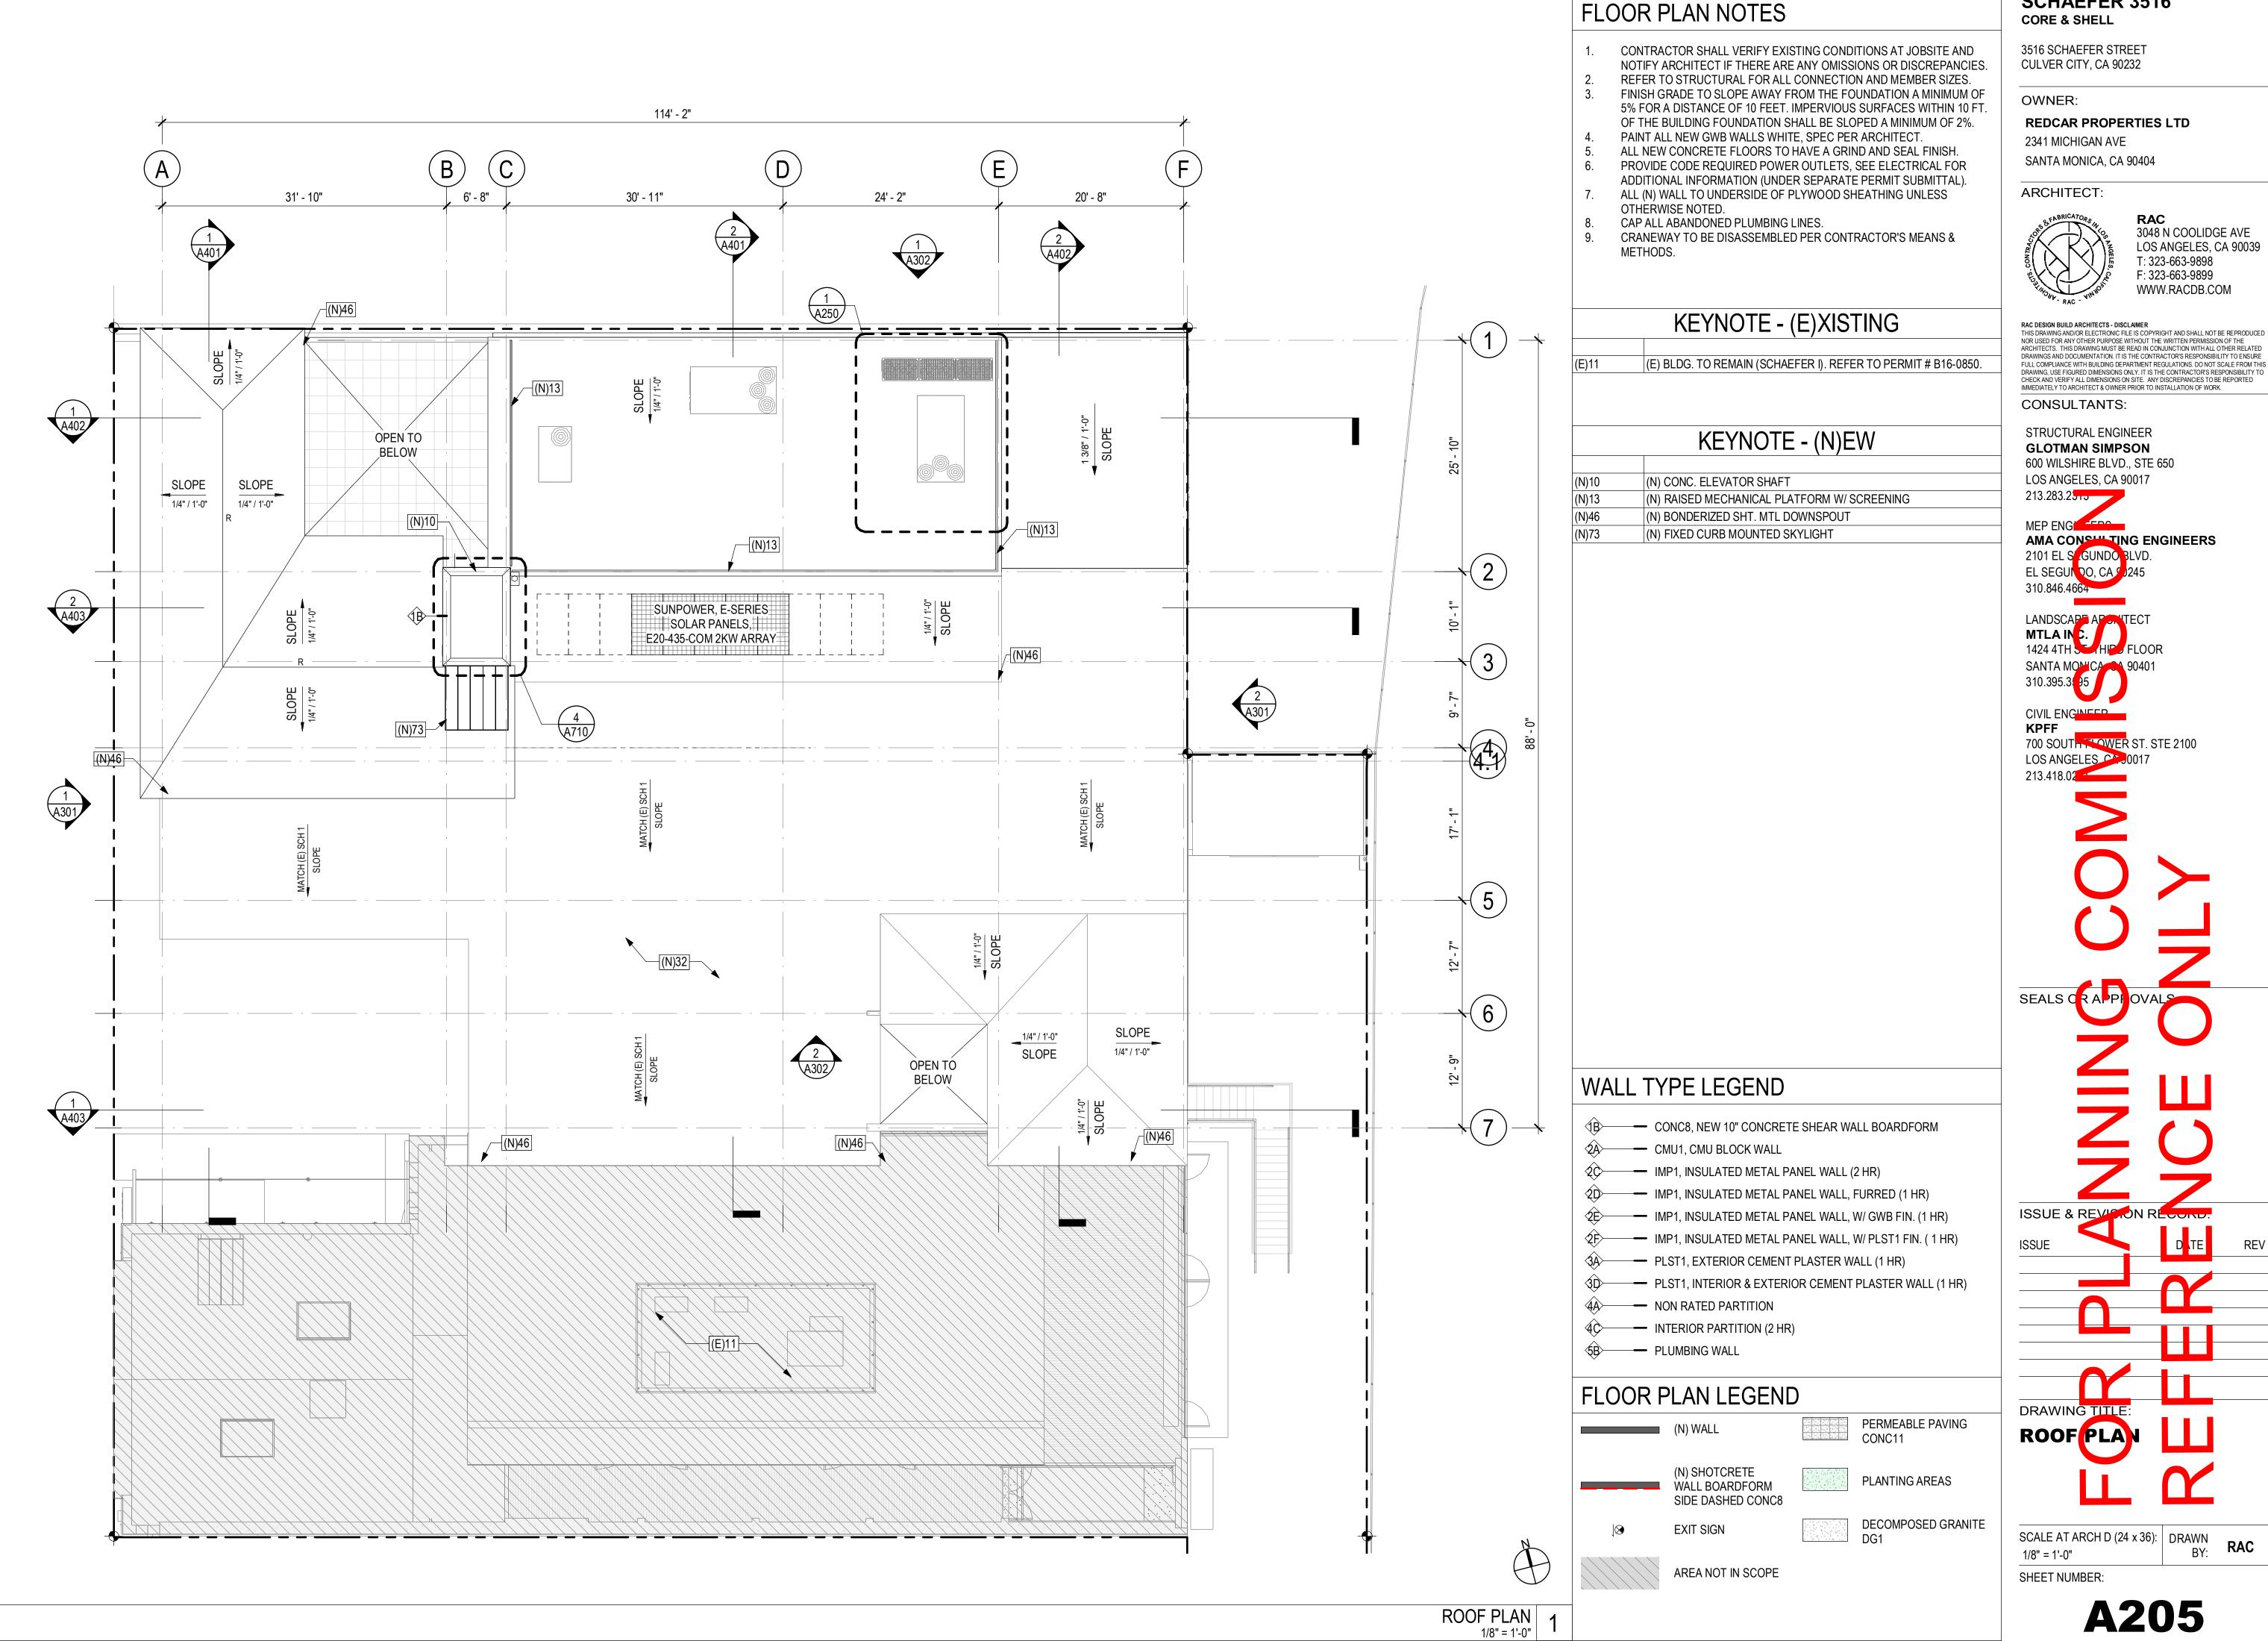

SCHAEFER 3516

3516 SCHAEFER STREET

REDCAR PROPERTIES LTD



RAC 3048 N COOLIDGE AVE LOS ANGELES, CA 90039 T: 323-663-9898 F: 323-663-9899 WWW.RACDB.COM

RAC DESIGN BUILD ARCHITECTS - DISCLAIMER
THIS DRAWING AND/OR ELECTRONIC FILE IS COPYRIGHT AND SHALL NOT BE REPRODUCED NOR USED FOR ANY OTHER PURPOSE WITHOUT THE WRITTEN PERMISSION OF THE ARCHITECTS. THIS DRAWING MUST BE READ IN CONJUNCTION WITH ALL OTHER RELATED DRAWINGS AND DOCUMENTATION. IT IS THE CONTRACTOR'S RESPONSIBILITY TO ENSURE


STRUCTURAL ENGINEER **GLOTMAN SIMPSON** 600 WILSHIRE BLVD., STE 650 LOS ANGELES, CA 90017

AMA CONSULTING ENGINEERS 2101 EL S. GUNDO BLVD. EL SEGUNDO, CA 90245


700 SOUTH FLOWER ST. STE 2100


SCALE AT ARCH D (24 x 36): DRAWN

A205

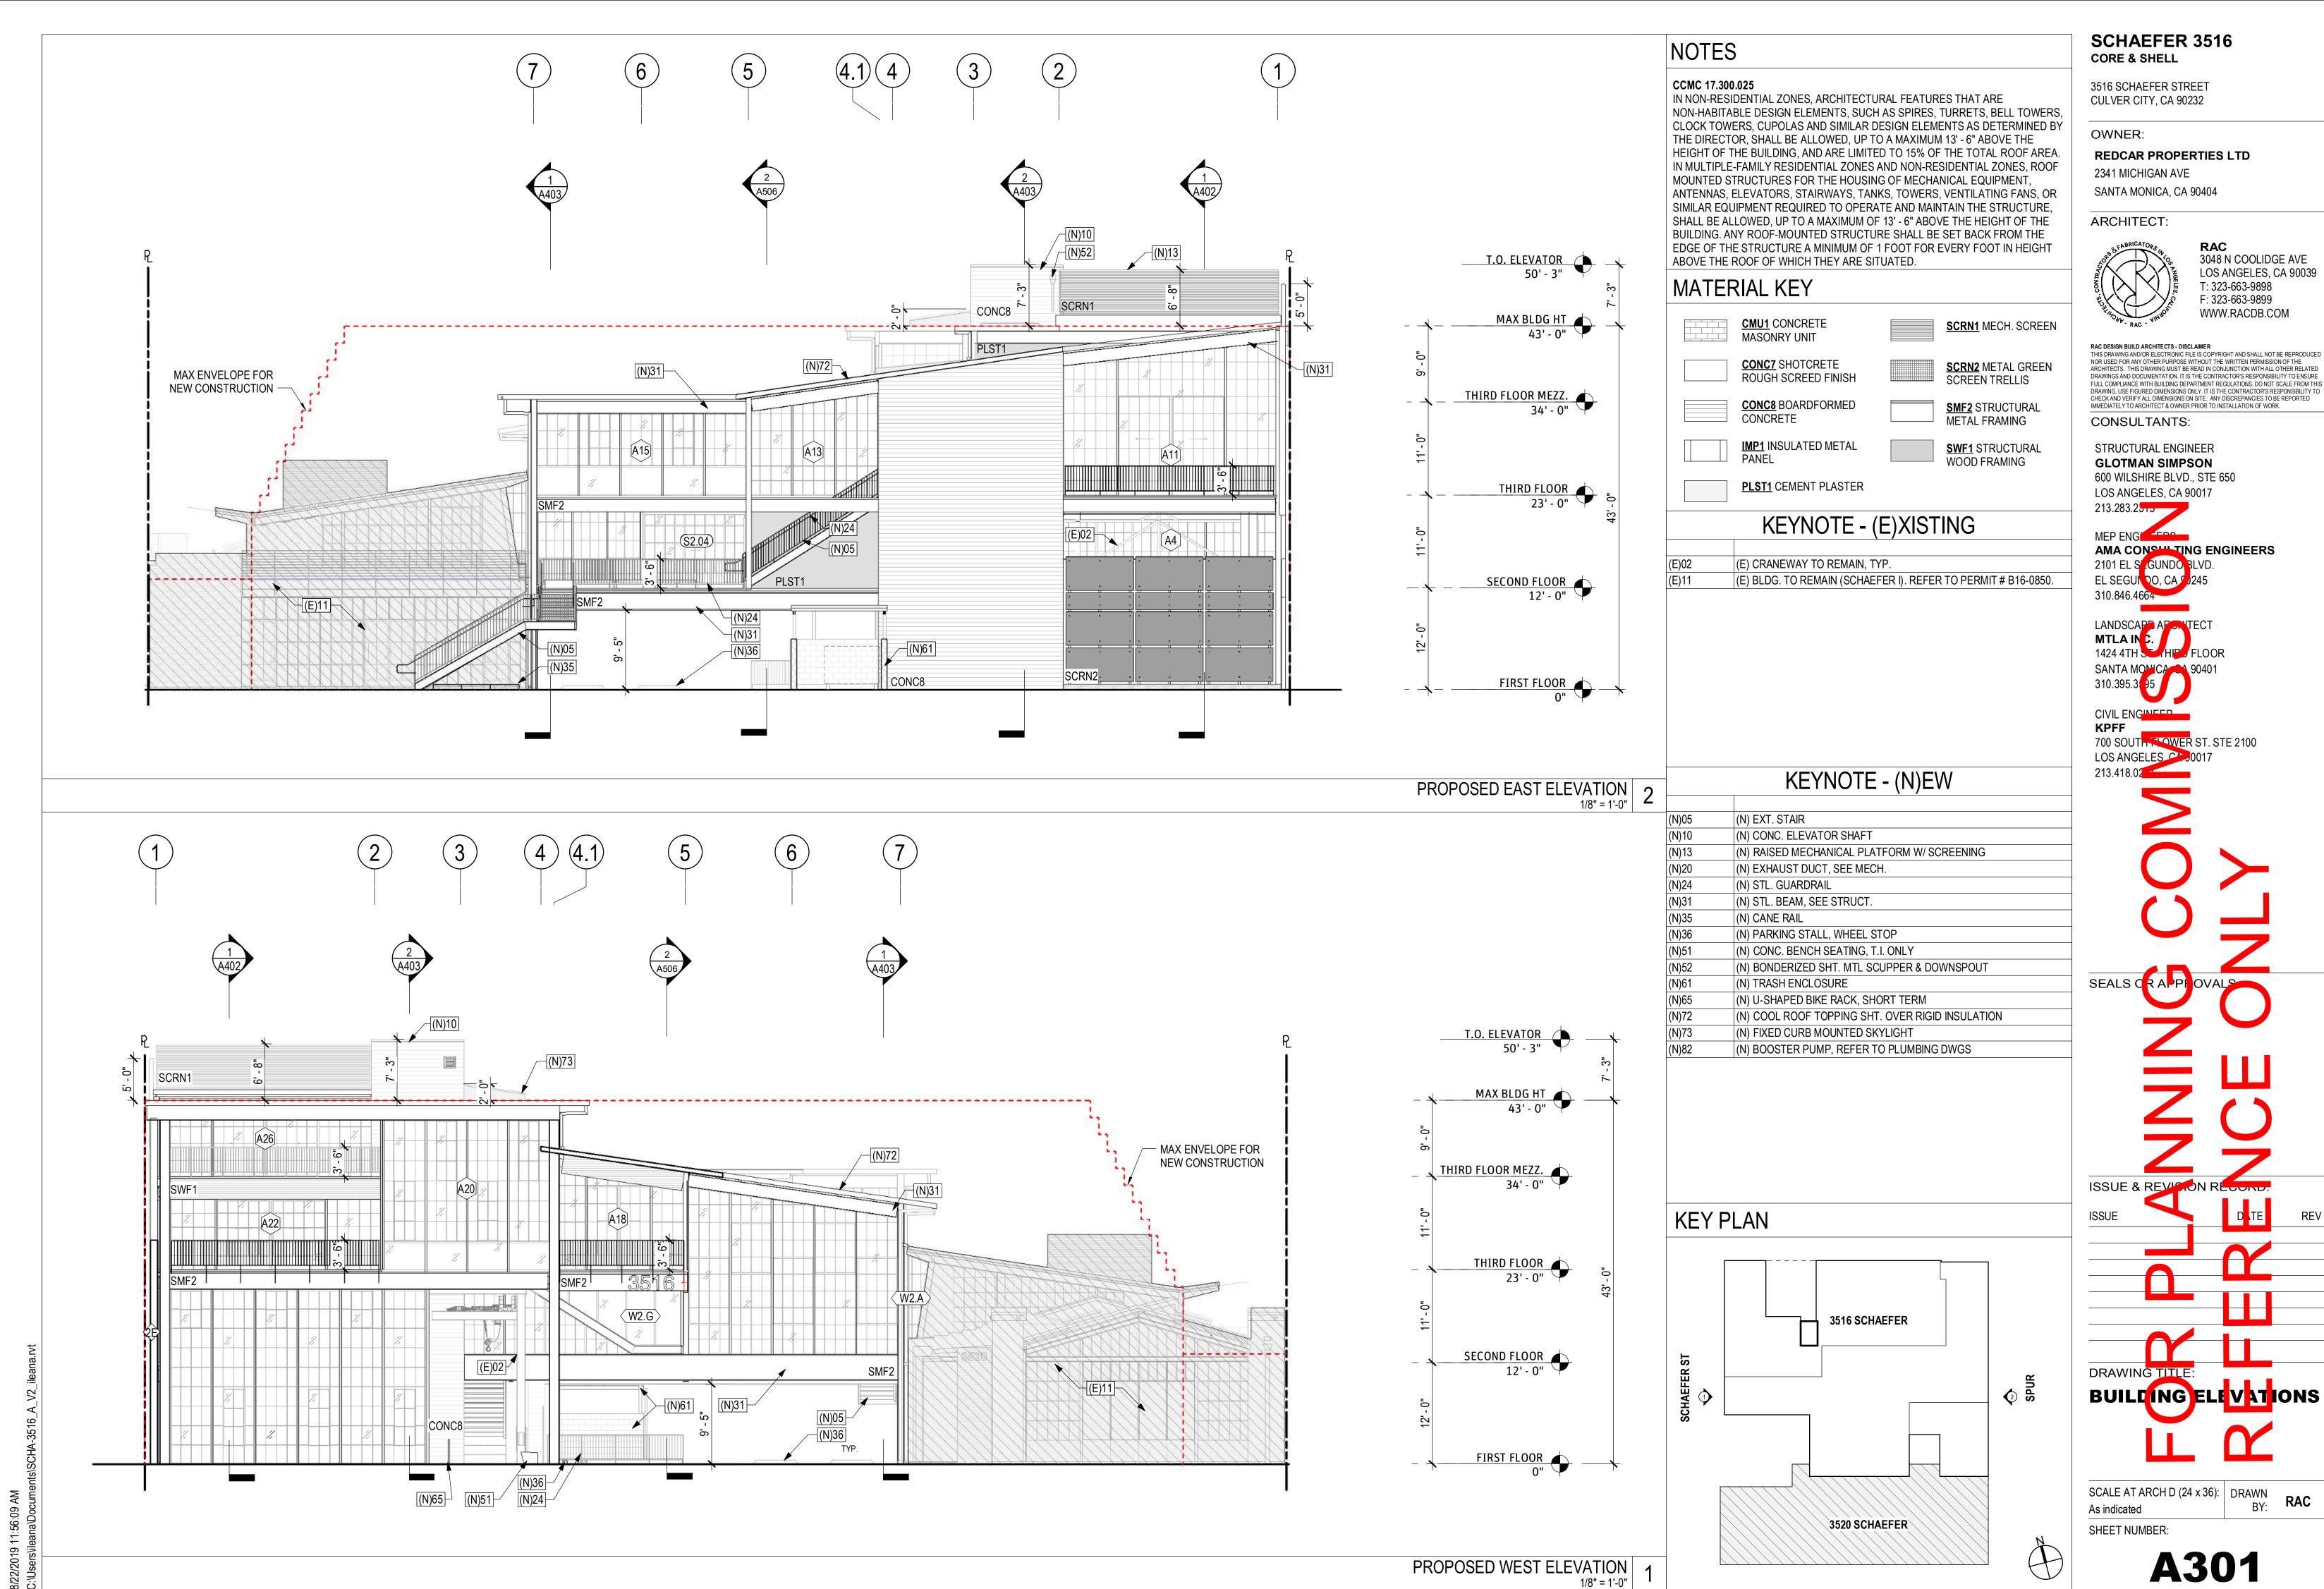

© 2018 RAC DESIGN BUILD, INC.

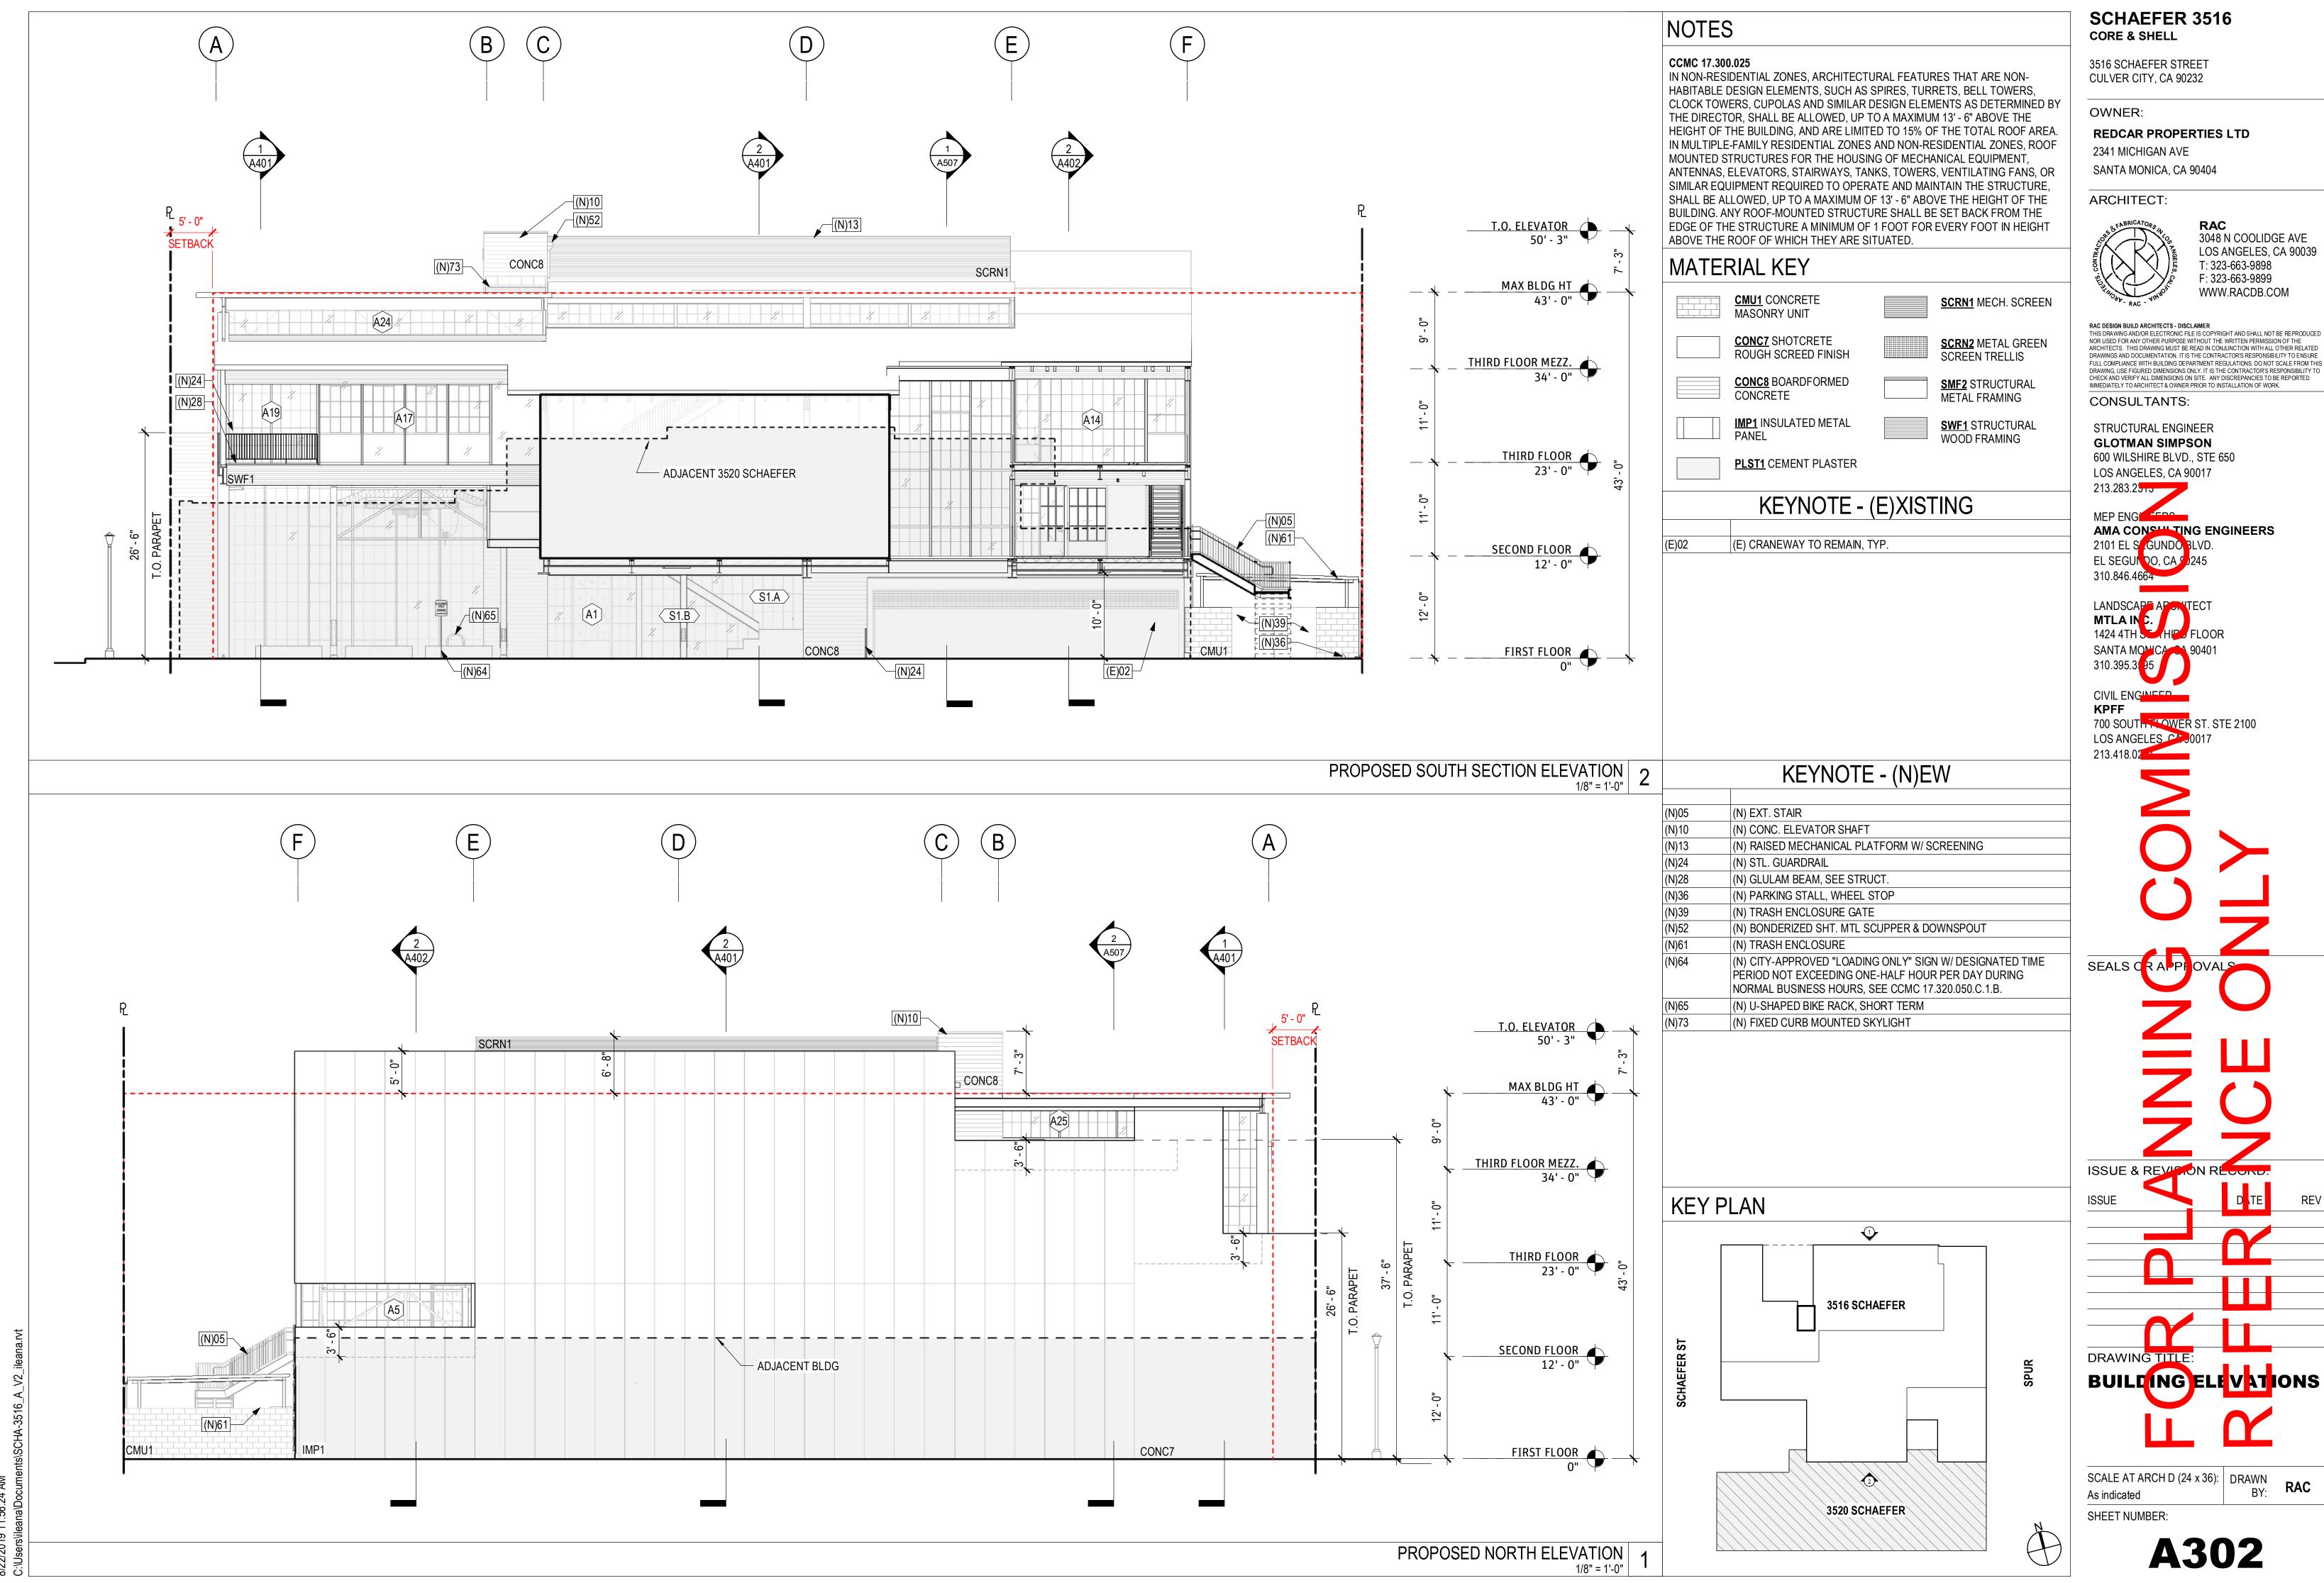

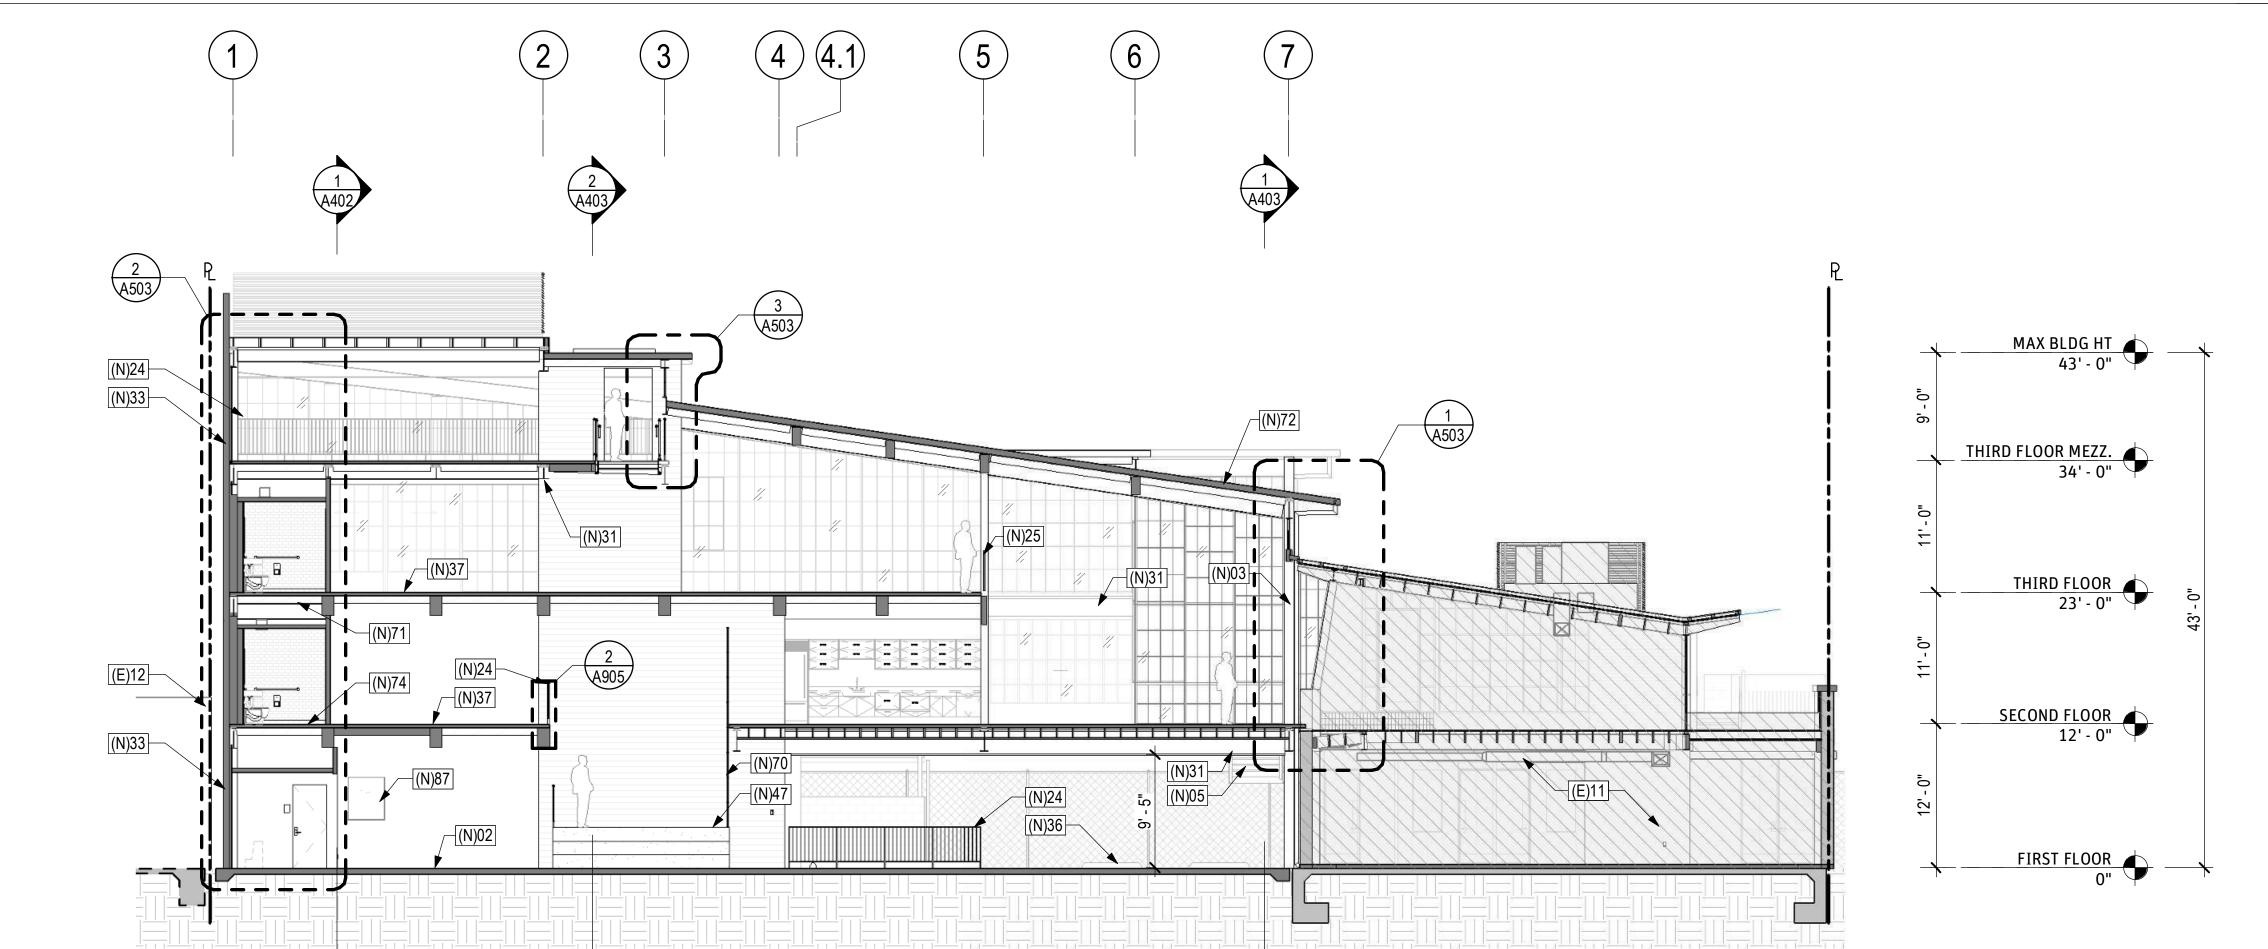

NOTES

CCMC 17.300.025

IN NON-RESIDENTIAL ZONES, ARCHITECTURAL FEATURES THAT ARE NON-HABITABLE DESIGN ELEMENTS, SUCH AS SPIRES, TURRETS, BELL TOWERS, CLOCK TOWERS, CUPOLAS AND SIMILAR DESIGN ELEMENTS AS DETERMINED BY THE DIRECTOR, SHALL BE ALLOWED, UP TO A MAXIMUM 13' - 6" ABOVE THE HEIGHT OF THE BUILDING, AND ARE LIMITED TO 15% OF THE TOTAL ROOF AREA. IN MULTIPLE-FAMILY RESIDENTIAL ZONES AND NON-RESIDENTIAL ZONES, ROOF MOUNTED STRUCTURES FOR THE HOUSING OF MECHANICAL EQUIPMENT, ANTENNAS, ELEVATORS, STAIRWAYS, TANKS, TOWERS, VENTILATING FANS, OR SIMILAR EQUIPMENT REQUIRED TO OPERATE AND MAINTAIN THE STRUCTURE, SHALL BE ALLOWED, UP TO A MAXIMUM OF 13' - 6" ABOVE THE HEIGHT OF THE BUILDING. ANY ROOF-MOUNTED STRUCTURE SHALL BE SET BACK FROM THE EDGE OF THE STRUCTURE A MINIMUM OF 1 FOOT FOR EVERY FOOT IN HEIGHT ABOVE THE ROOF OF WHICH THEY ARE SITUATED.

KEYNOTE - (E)XISTING

(E)02	(E) CRANEWAY TO REMAIN, TYP.
(E)11	(E) BLDG. TO REMAIN (SCHAEFER I). REFER TO PERMIT # B16-0850.
(E)12	ADJACENT BLDG. N.I.C.


KEYNOTE - (N)EW

	(N)02	(N) CONC. SLAB.
	(N)03	(N) COLUMN, TYP. SEE STRUCT.
	(N)05	(N) EXT. STAIR
	(N)10	(N) CONC. ELEVATOR SHAFT
	(N)17	(N) MTL. STAIR, SEE ENLARGED PLANS AND DETAILS
	(N)24	(N) STL. GUARDRAIL
	(N)25	(N) STL. & GLASS GUARDRAIL
	(N)28	(N) GLULAM BEAM, SEE STRUCT.
	(N)30	(N) CONC. SHEAR WALL
	(N)31	(N) STL. BEAM, SEE STRUCT.
	(N)33	(N) INSULATED MTL. PANEL WALL
	(N)36	(N) PARKING STALL, WHEEL STOP
	(N)37	(N) 2.5" THK. CONC. OVER 3/4" THK. PLYWD.
	(N)47	(N) CONC. STEPS & LANDING
	(N)51	(N) CONC. BENCH SEATING, T.I. ONLY
	(N)64	(N) CITY-APPROVED "LOADING ONLY" SIGN W/ DESIGNATED TIME
		PERIOD NOT EXCEEDING ONE-HALF HOUR PER DAY DURING
		NORMAL BUSINESS HOURS, SEE CCMC 17.320.050.C.1.B.
	(N)65	(N) U-SHAPED BIKE RACK, SHORT TERM
	(N)70	(N) EXT. STL. & GLASS ASSEMBLY
	(N)71	(N) EXT. PLYWOOD CLADDING & SOFFIT
	(N)72	(N) COOL ROOF TOPPING SHT. OVER RIGID INSULATION
	(N)73	(N) FIXED CURB MOUNTED SKYLIGHT
	(N)74	(N) ROOF TERRACE, RAISED PEDESTAL PAVERS OVER WP
	(N)82	(N) BOOSTER PUMP, REFER TO PLUMBING DWGS
	(N)87	(N) SPRINKLER CABINET, SEE PLUMBING.

(N) DIFFUSER RETURN, SEE MECHANICAL

KEY PLAN

TRANSVERSE BUILDING SECTION A
1/8" = 1'-0"

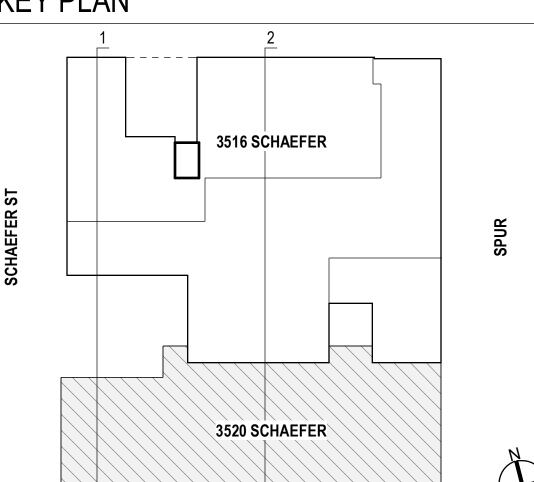

SCHAEFER 3516

CORE & SHELL

3516 SCHAEFER STREET CULVER CITY, CA 90232

OWNER:

REDCAR PROPERTIES LTD

2341 MICHIGAN AVE SANTA MONICA, CA 90404

ARCHITECT:



RAC 3048 N COOLIDGE AVE LOS ANGELES, CA 90039 T: 323-663-9898 F: 323-663-9899 WWW.RACDB.COM

F: 323-663-9899

WWW.RACDB.COM

RAC DESIGN BUILD ARCHITECTS - DISCLAIMER

THIS DRAWING AND/OR ELECTRONIC FILE IS COPYRIGHT AND SHALL NOT BE REPRODUCED NOR USED FOR ANY OTHER PURPOSE WITHOUT THE WRITTEN PERMISSION OF THE

ARCHITECTS. THIS DRAWING MUST BE READ IN CONJUNCTION WITH ALL OTHER RELATED DRAWINGS AND DOCUMENTATION. IT IS THE CONTRACTOR'S RESPONSIBILITY TO ENSURE

DRAWING, USE FIGURED DIMENSIONS ONLY. IT IS THE CONTRACTOR'S RESPONSIBILITY TO CHECK AND VERIFY ALL DIMENSIONS ON SITE. ANY DISCREPANCIES TO BE REPORTED

IMMEDIATELY TO ARCHITECT & OWNER PRIOR TO INSTALLATION OF WORK.

CONSULTANTS:

213.283.2513

STRUCTURAL ENGINEER
GLOTMAN SIMPSON
600 WILSHIRE BLVD., STE 650
LOS ANGELES, CA 90017

MEP ENGINEERS

AMA CONSTITUTING ENGINEERS

2101 EL SAGUNDO BLVD.

EL SEGUNDO, CA 50245

LANDSCAPE APONTECT
MTLA INC.
1424 4TH STAHID FLOOR
SANTA MONICA A 90401
310.395.305

CIVIL ENGINEED

KPFF
700 SOUTH T'OWER ST. STE 2100

SEALS OR APPHOVALS

ISSUE & REVISION RECORD.


ISSUE DITE RE


DRAWING TITLE:
BUILDING SECTIONS

SCALE AT ARCH D (24 x 36): DRAWN
As indicated BY:

SHEET NUMBER:

4401

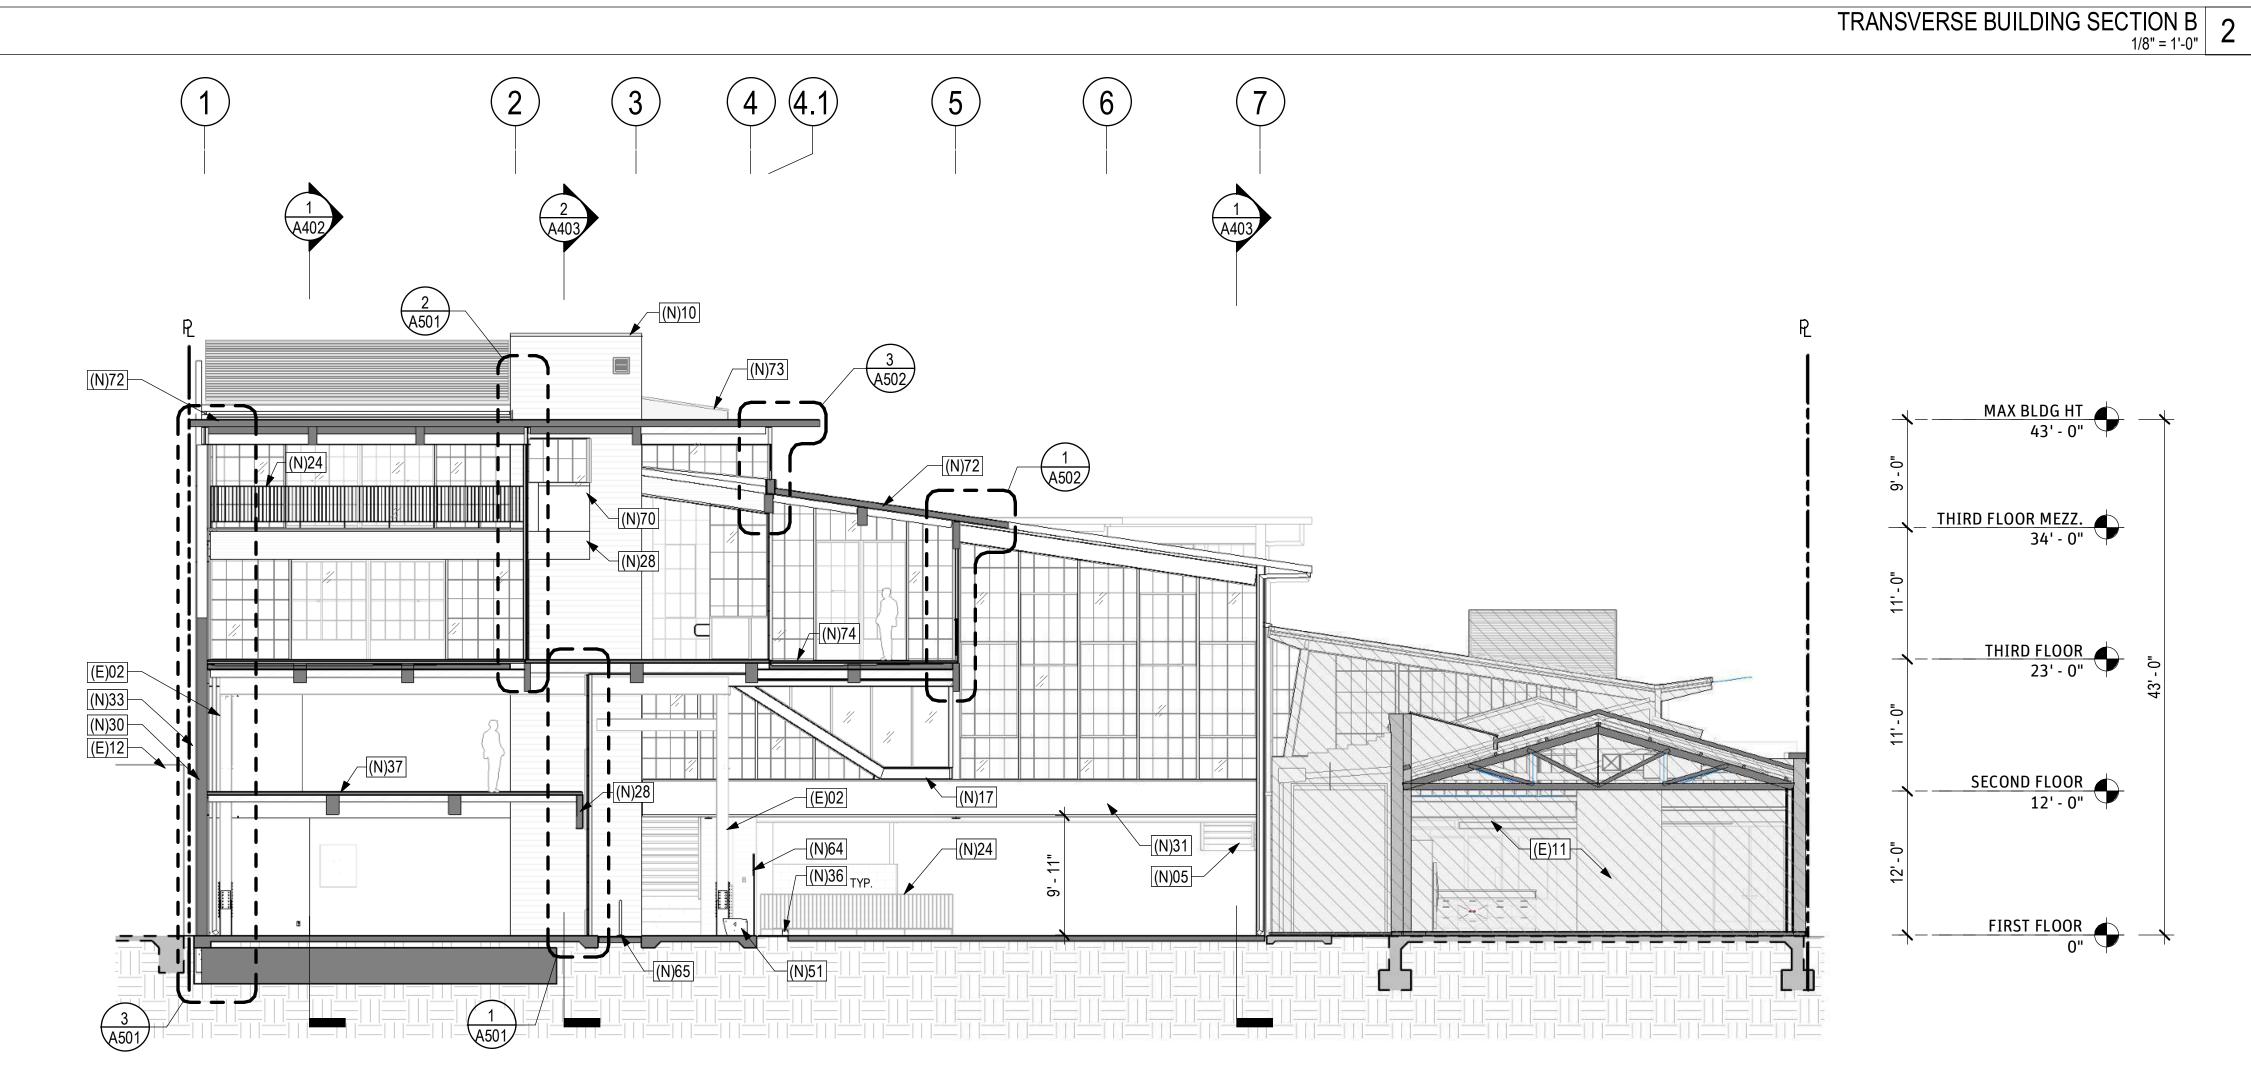

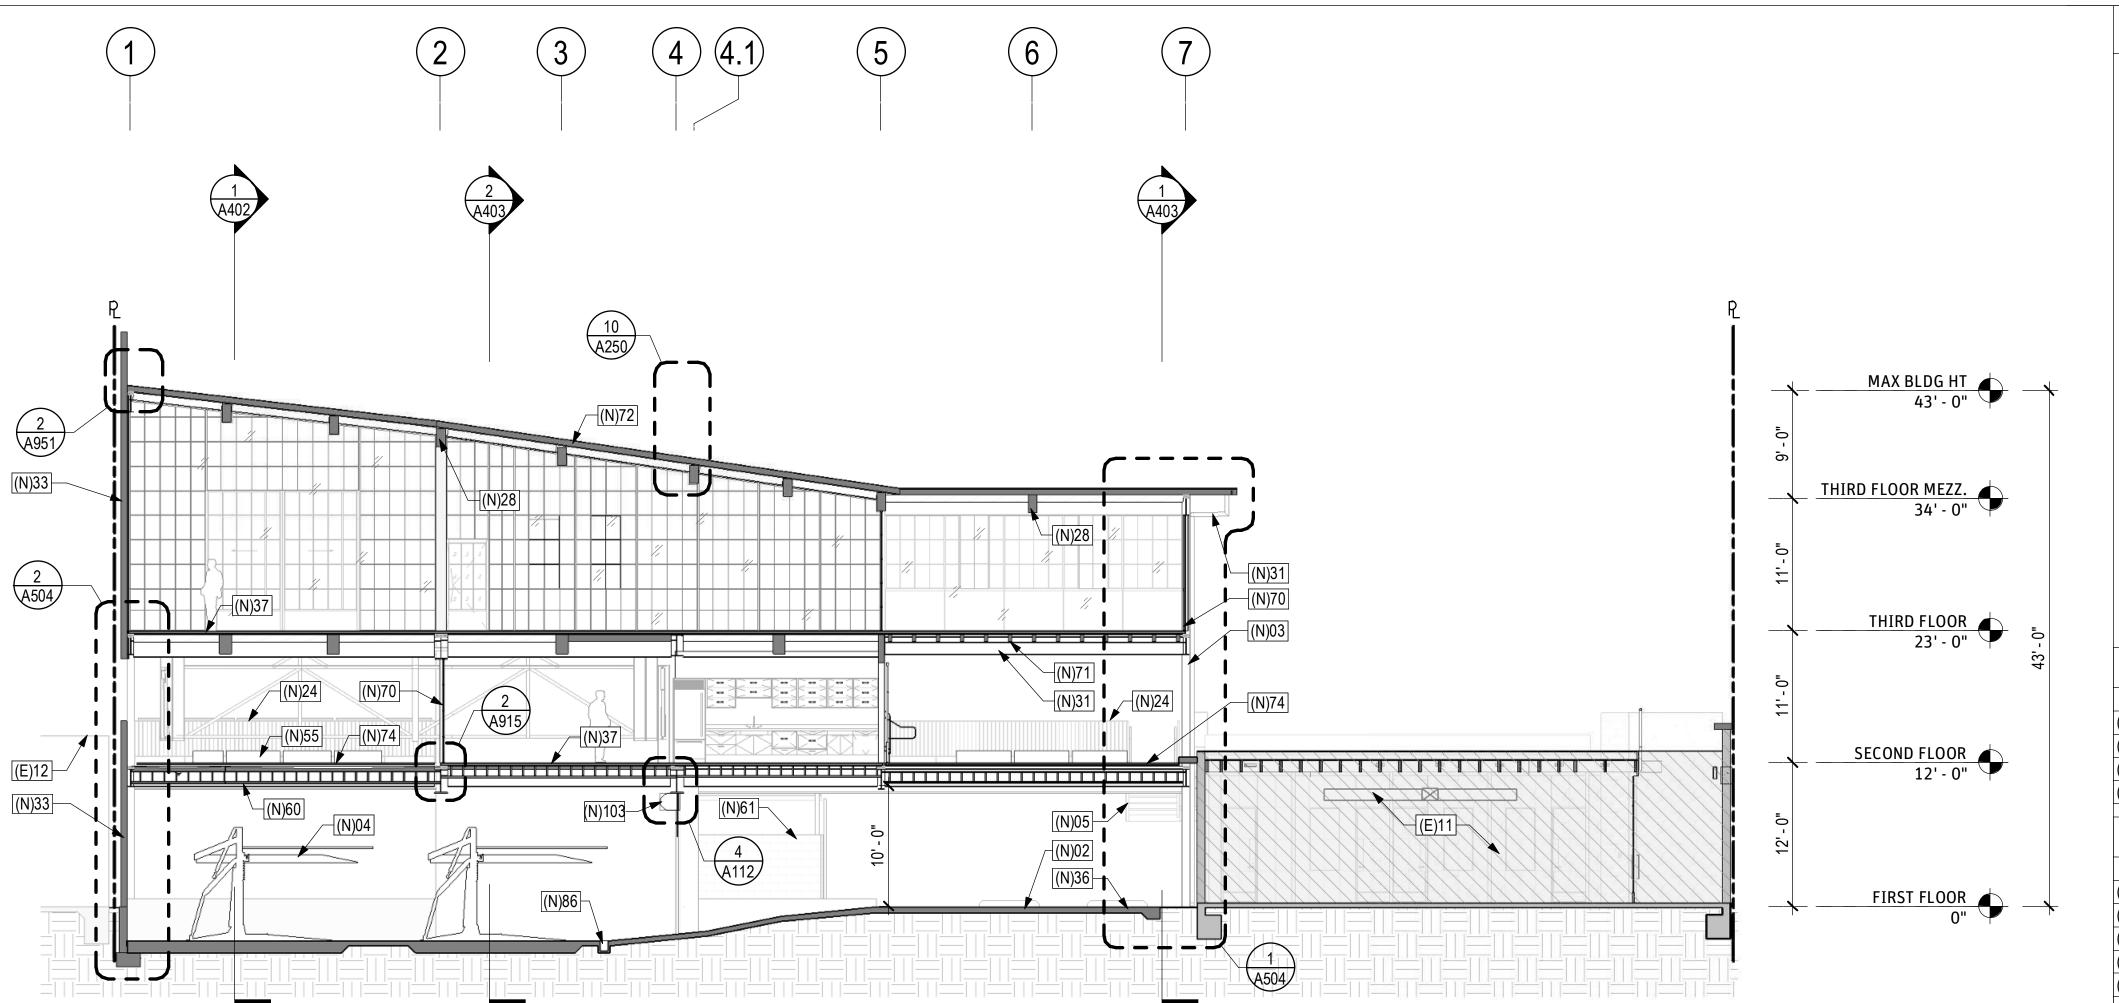

TRANSVERSE BUILDING SECTION C 1/8" = 1'-0" 2

EW LONGITUDINAL BUILDING SECTION A- SOUTH

F E D C B A MAS SLIDG IT THEN DE TOOK METZ. THEN DE TOOK METZ.

NOTES

CCMC 17.300.025

IN NON-RESIDENTIAL ZONES, ARCHITECTURAL FEATURES THAT ARE NON-HABITABLE DESIGN ELEMENTS, SUCH AS SPIRES, TURRETS, BELL TOWERS, CLOCK TOWERS, CUPOLAS AND SIMILAR DESIGN ELEMENTS AS DETERMINED BY THE DIRECTOR, SHALL BE ALLOWED, UP TO A MAXIMUM 13' - 6" ABOVE THE HEIGHT OF THE BUILDING, AND ARE LIMITED TO 15% OF THE TOTAL ROOF AREA. IN MULTIPLE-FAMILY RESIDENTIAL ZONES AND NON-RESIDENTIAL ZONES, ROOF MOUNTED STRUCTURES FOR THE HOUSING OF MECHANICAL EQUIPMENT, ANTENNAS, ELEVATORS, STAIRWAYS, TANKS, TOWERS, VENTILATING FANS, OR SIMILAR EQUIPMENT REQUIRED TO OPERATE AND MAINTAIN THE STRUCTURE, SHALL BE ALLOWED, UP TO A MAXIMUM OF 13' - 6" ABOVE THE HEIGHT OF THE BUILDING. ANY ROOF-MOUNTED STRUCTURE SHALL BE SET BACK FROM THE EDGE OF THE STRUCTURE A MINIMUM OF 1 FOOT FOR EVERY FOOT IN HEIGHT ABOVE THE ROOF OF WHICH THEY ARE SITUATED.

KEYNOTE - (E)XISTING

(E)02	(E) CRANEWAY TO REMAIN, TYP.
(E)06	(E) CHAINLINK FENCE
(E)11	(E) BLDG. TO REMAIN (SCHAEFER I). REFER TO PERMIT # B16-0850.
(E)12	ADJACENT BLDG. N.I.C.

KEYNOTE - (N)EW

(N)02	(N) CONC. SLAB.
(N)03	(N) COLUMN, TYP. SEE STRUCT.

(N)04 (N) STACKER PARKING (N)05 (N) EXT. STAIR

(N)10 (N) CONC. ELEVATOR SHAFT
(N)13 (N) RAISED MECHANICAL PLATFORM W/ SCREEN

(N)13 (N) RAISED MECHANICAL PLATFORM W/ SCREENING (N)17 (N) MTL. STAIR, SEE ENLARGED PLANS AND DETAILS

(N)24 (N) STL. GUARDRAIL

(N)28 (N) GLULAM BEAM, SEE STRUCT.

(N)31 (N) STL. BEAM, SEE STRUCT.
(N)33 (N) INSULATED MTL. PANEL WALL

(N)35 (N) CANE DAIL

(N)35 (N) CANE RAIL (N)36 (N) PARKING STALL, WHEEL STOP

(N)37 (N) 2.5" THK. CONC. OVER 3/4" THK. PLYWD.

(N)38 (N) CUSTOM STL. GLASS SLIDING DOOR

(N)47 (N) CONC. STEPS & LANDING

(N)50 (N) 2" THK. CONC. PAVER

(N)55 (N) PLANTER (N)60 (N) 2 HR RATED FLOOR

(N)61 (N) TRASH ENCLOSURE

(N)70 (N) EXT. STL. & GLASS ASSEMBLY

(N)71 (N) EXT. PLYWOOD CLADDING & SOFFIT


(N)72 (N) COOL ROOF TOPPING SHT. OVER RIGID INSULATION

(N)74 (N) ROOF TERRACE, RAISED PEDESTAL PAVERS OVER WP (N)76 (N) EXT. PLASTER & SOFFIT

(N)81 (N) PROPOSED PARKWAY, UNDER SEPARATE PERMIT

(N)86 (N) TRENCH DRAIN

(N)103 (N) OVERHEAD ROLLING DOOR

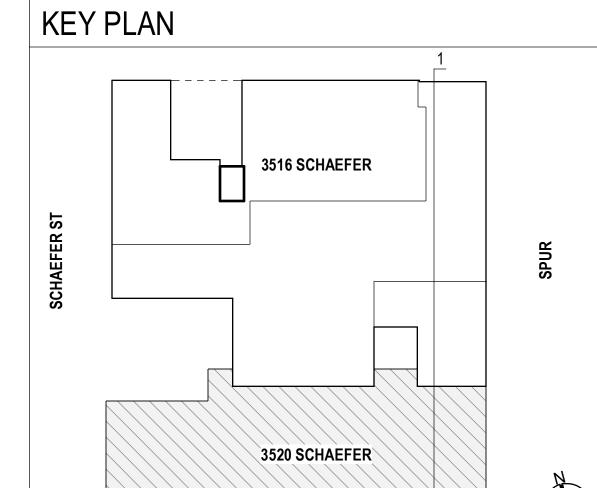

SCHAEFER 3516
CORE & SHELL

3516 SCHAEFER STREET

CULVER CITY, CA 90232

OWNER:

REDCAR PROPERTIES LTD

2341 MICHIGAN AVE SANTA MONICA, CA 90404

ARCHITECT:



RAC 3048 N COOLIDGE AVE LOS ANGELES, CA 90039 T: 323-663-9898 F: 323-663-9899 WWW.RACDB.COM

RAC DESIGN BUILD ARCHITECTS - DISCLAIMER

THIS DRAWING AND/OR ELECTRONIC FILE IS COPYRIGHT AND SHALL NOT BE REPRODUCED NOR USED FOR ANY OTHER PURPOSE WITHOUT THE WRITTEN PERMISSION OF THE ARCHITECTS. THIS DRAWING MUST BE READ IN CONJUNCTION WITH ALL OTHER RELATED DRAWINGS AND DOCUMENTATION. IT IS THE CONTRACTOR'S RESPONSIBILITY TO ENSURE

FULL COMPLIANCE WITH BUILDING DEPARTMENT REGULATIONS. DO NOT SCALE FROM THIS DRAWING, USE FIGURED DIMENSIONS ONLY. IT IS THE CONTRACTOR'S RESPONSIBILITY TO CHECK AND VERIFY ALL DIMENSIONS ON SITE. ANY DISCREPANCIES TO BE REPORTED

IMMEDIATELY TO ARCHITECT & OWNER PRIOR TO INSTALLATION OF WORK.

CONSULTANTS:

STRUCTURAL ENGINEER
GLOTMAN SIMPSON
600 WILSHIRE BLVD., STE 650
LOS ANGELES, CA 90017
213.283.2513

MEP ENGINCEDS

AMA CONSULTING ENGINEERS

2101 EL SEGUNDO BLVD.

EL SEGUNDO, CA 9 2245

LANDSCAPE APONTECT
MTLA IN C.
1424 4TH STAHIP FLOOR
SANTA MONICA CA 90401

310.395.3.95

CIVIL ENGINEED

KPFF

700 SOUTH FLOWER ST. STE 2100 LOS ANGELES, CA. J0017 213.418.02


EALS OR APPHOVALS

ISSUE & REVISION RECORD.

ISSUE DITE R

DRAWING TITLE:
BUILDING SECTIONS

SCALE AT ARCH D (24 x 36): DRAWN
As indicated BY:

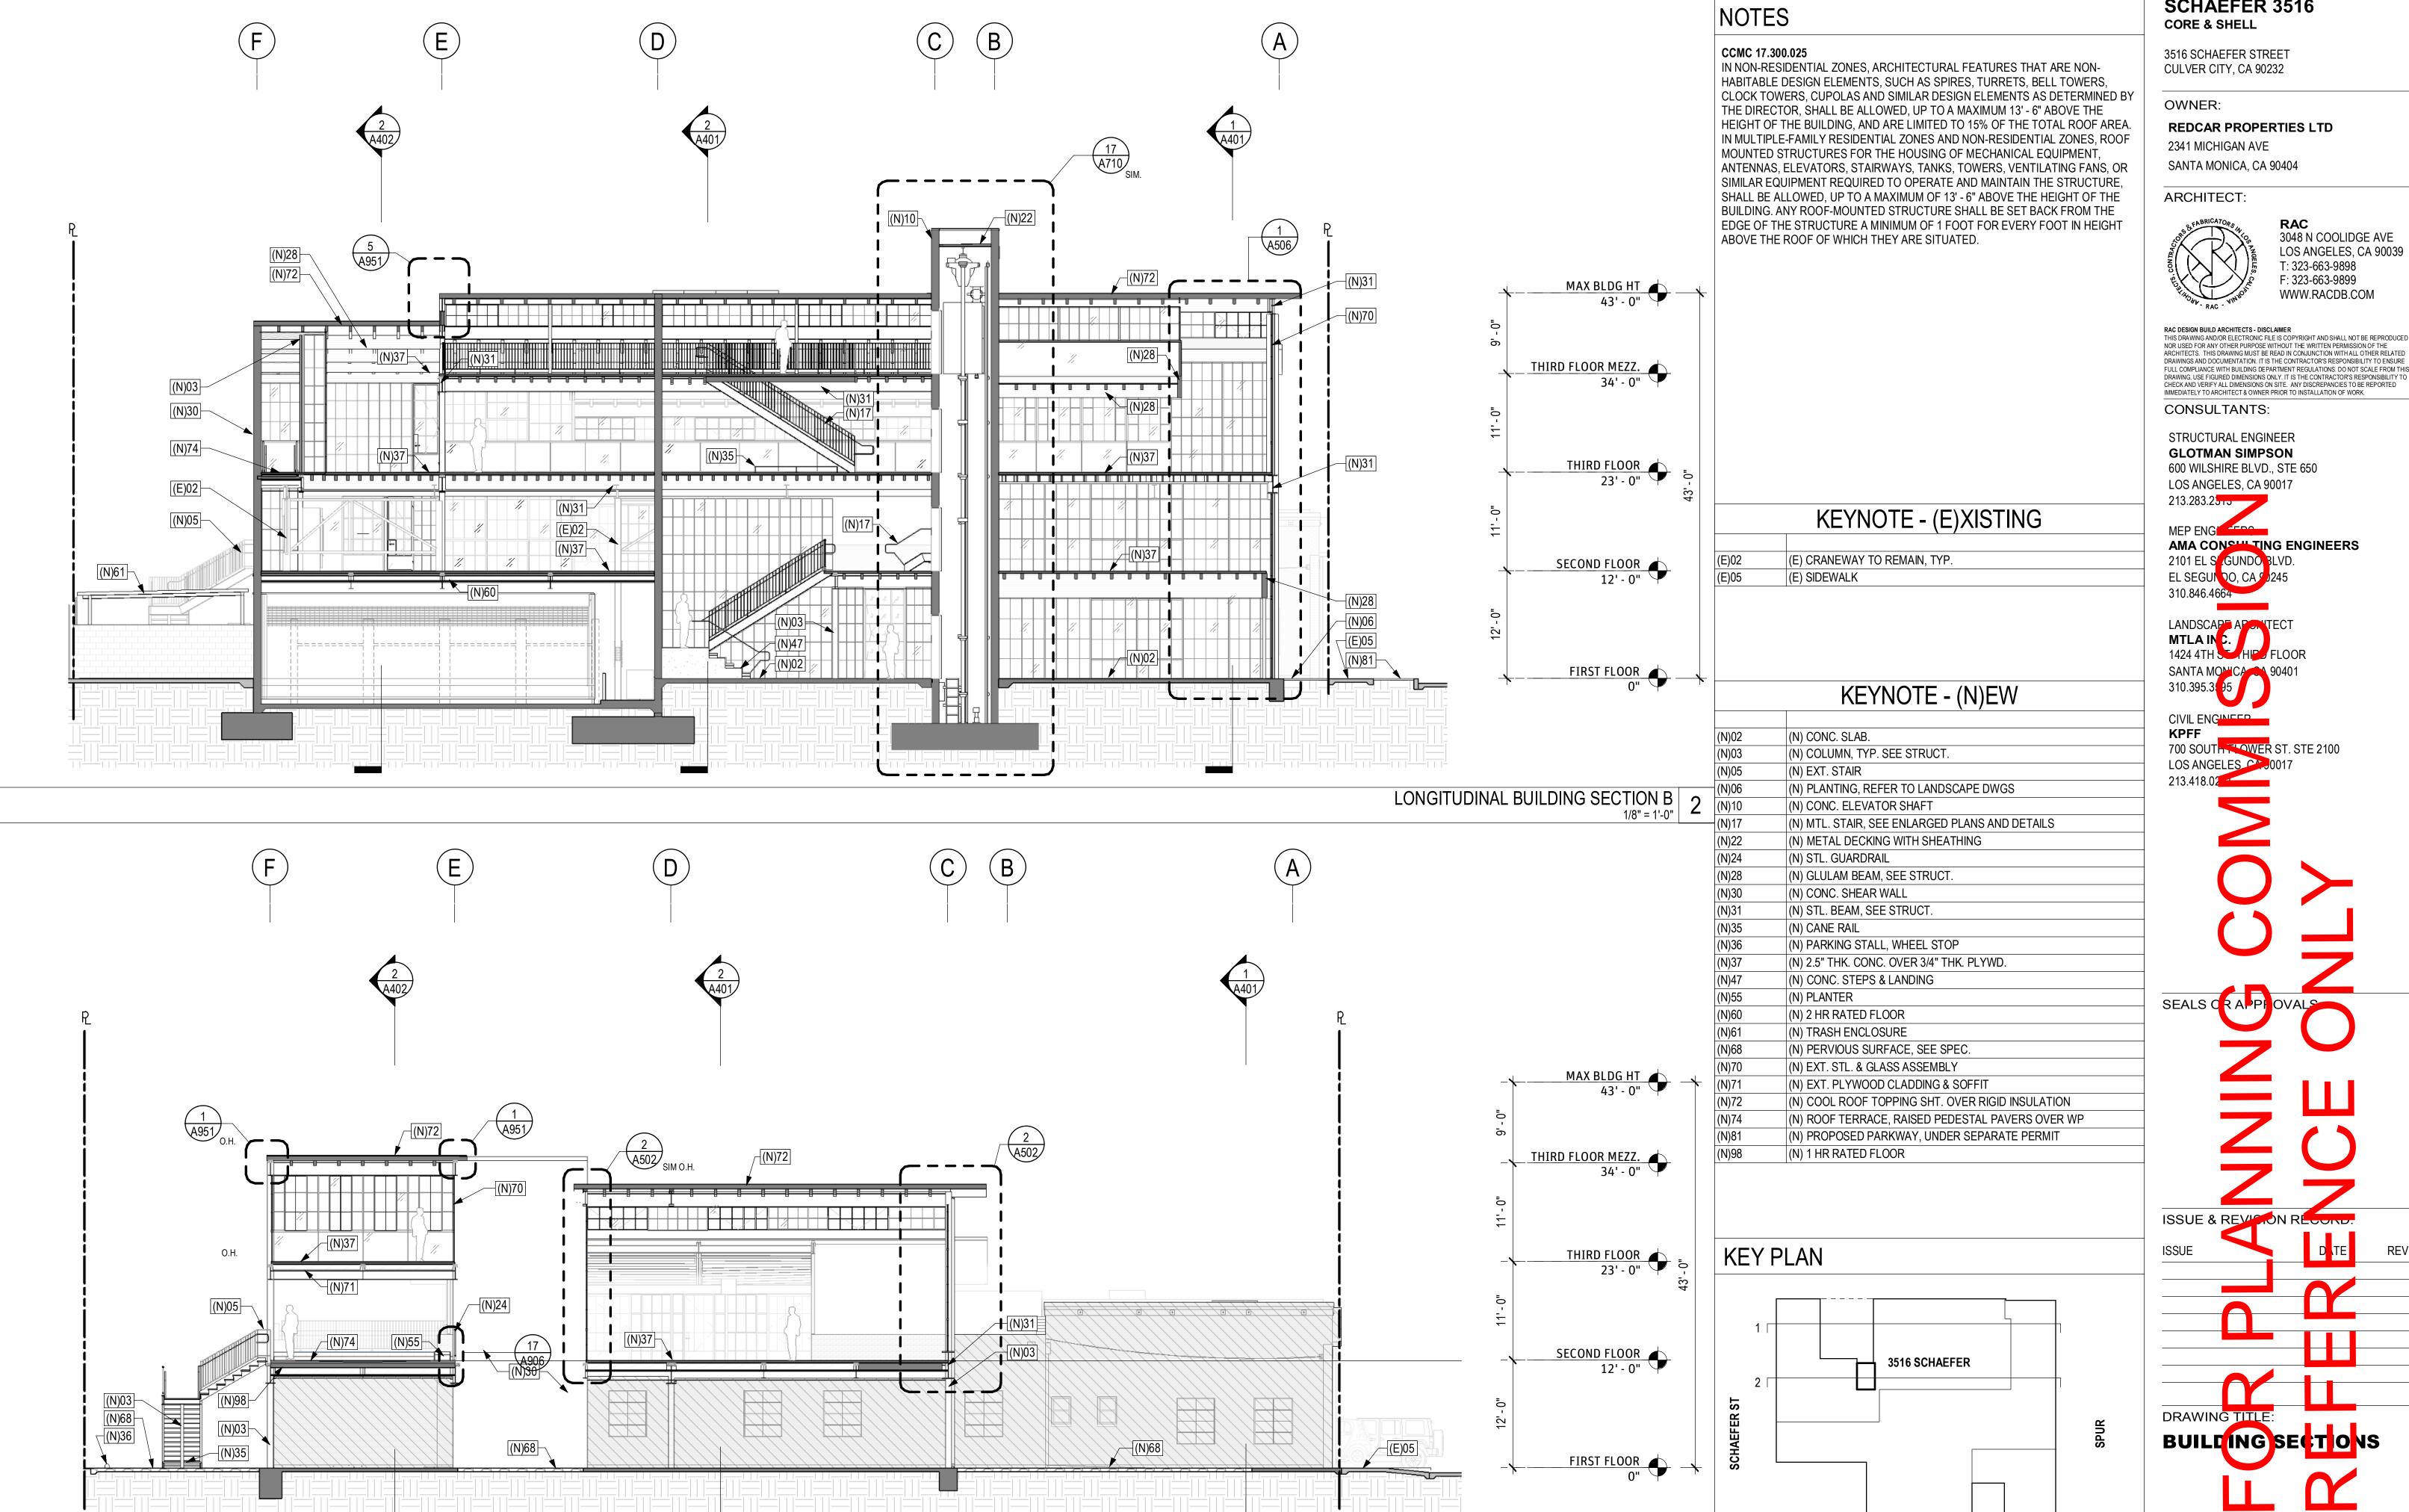

SCHAEFER 3516

3516 SCHAEFER STREET CULVER CITY, CA 90232

REDCAR PROPERTIES LTD

2341 MICHIGAN AVE SANTA MONICA, CA 90404

ARCHITECT:



3048 N COOLIDGE AVE LOS ANGELES, CA 90039 T: 323-663-9898 F: 323-663-9899 WWW.RACDB.COM

RAC DESIGN BUILD ARCHITECTS - DISCLAIMER THIS DRAWING AND/OR ELECTRONIC FILE IS COPYRIGHT AND SHALL NOT BE REPRODUCED NOR USED FOR ANY OTHER PURPOSE WITHOUT THE WRITTEN PERMISSION OF THE

IMMEDIATELY TO ARCHITECT & OWNER PRIOR TO INSTALLATION OF WORK. CONSULTANTS:

STRUCTURAL ENGINEER **GLOTMAN SIMPSON** 600 WILSHIRE BLVD., STE 650 LOS ANGELES, CA 90017

MEP ENG AMA CONSTITUTING ENGINEERS 2101 EL S. GUNDO BLVD. EL SEGUNDO, CA 90245

LANDSCAPE APONTECT

310.395.3 CIVIL ENGINEER

KPFF 700 SOUTH FLOWER ST. STE 2100 LOS ANGELES

ISSUE & REVISION RECO

DRAWING TITLE

SCALE AT ARCH D (24 x 36): DRAWN As indicated

SHEET NUMBER:

3520 SCHAEFER

LONGITUDINAL BUILDING SECTION C