


PARKING STRUCTURE WITH LANDSCAPE BUFFER 3

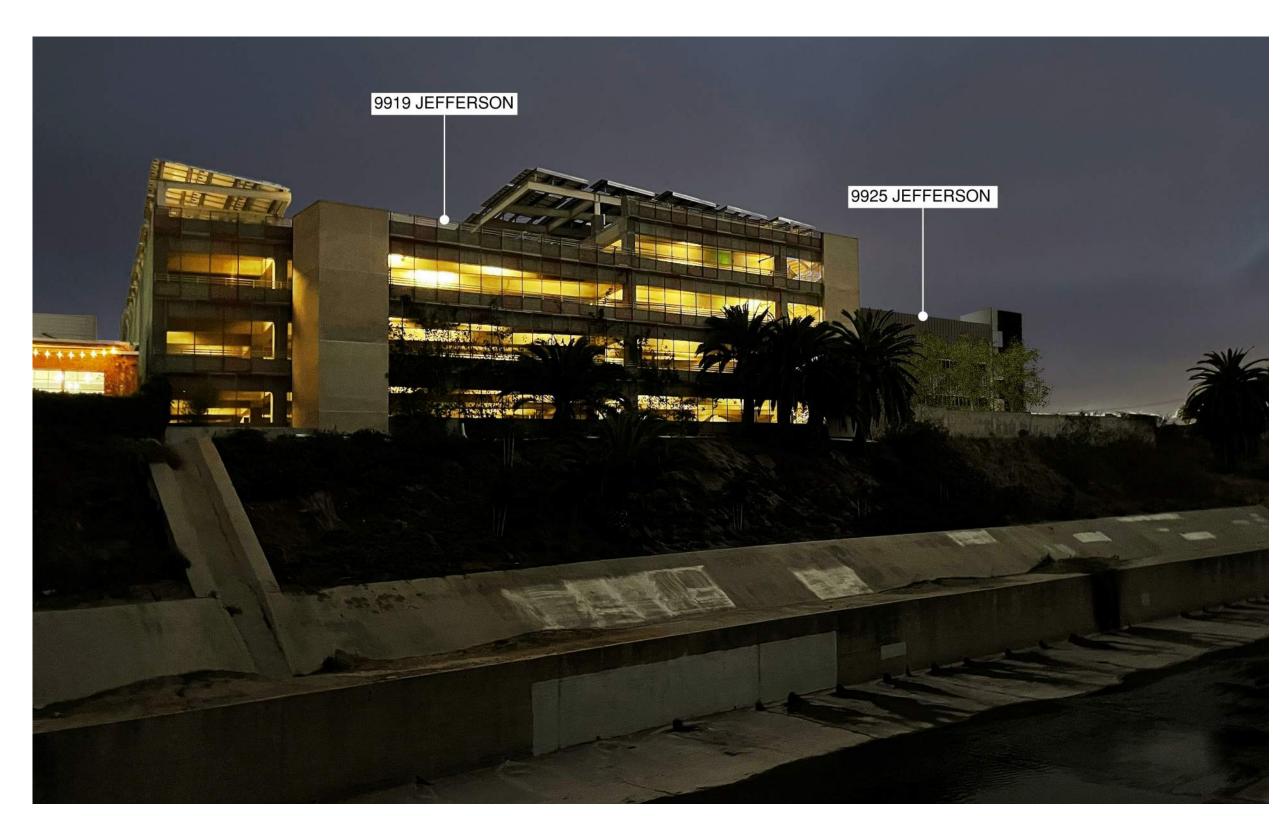

PARKING STRUCTURE WITH LANDSCAPE BUFFER 7







PARKING STRUCTURE WITH LANDSCAPE BUFFER

ATTACHMENT NO. 5

Ballona Creek facing Elevation and Landscaping Renderings



9925 JEFFERSON

Shubin Donaldson

ENTITLMENT

SCALE: As indicated

IDEAS, DESIGNS, AND PLANS INDICATED OR REPRESENTED BY THESE AWINGS ARE OWNED BY AND ARE PROPERTY OF SHUBIN + DONALDSON INC.

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CONCEPT RENDERS

EN0.08

12/1/2021 4:3

analdson Architects Inc. 19




[pakshong landscape and architectural collaborative] 3617 exposition boulevard los angeles ca 90016 310 450 8100 fax 323 737 3290


CONSULTANTS

Shubin Donaldson 3751 S. Robertson Blvd. Culver City, CA 90232 P: 310.204.0688 Mark Hershman

NAME OF ISSUE

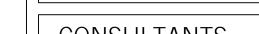

ARCHITECT

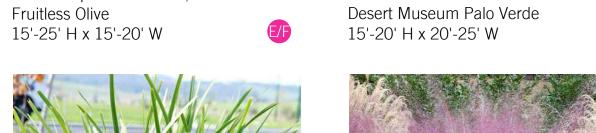



Lomandra longifolia Mat Rush 4'-5' H x 4'-6' W

STREETSCAPE PALETTE

Olea europaea 'Fruitless', OPTION A



Parkinsonia × 'Desert Museum' OPTION B



Muhlenbergia 'Pink Flamingo' Pink Flamingo Muhly 3'-4' H x 2'-3' W



KEY PLAN



9925 Jefferson Blvd. Culver City, CA 90232

Project # : 2014 Drawn by : LS Scale : As Noted	Ref.	Ref. North	
Description:	Date:	No.	
PPR	03/26/21		
PPR - Revsions	07/06/21		
PPR - Revsions	10.26.21		
PROJECT NO:		2014	
These drawings, specifications, ideas, designs, are and shall remain the property of [place]. Not to others or used in connection with any work of for which they have been prepared and develop [place]. Visual contact with these drawings or significant or the contact with the contact	p part thereof shall be co or project other than the s ped without the written c	pied, disclos specific proje onsent of	

S H E E T T I T L E: SITE PLAN

L2.00


Ulmus parvifolia Standard Chinese Evergreen Elm 40'-50' H x 25'-40' W



Olea europaea 'Montra'



AERIAL OF COURTYARD

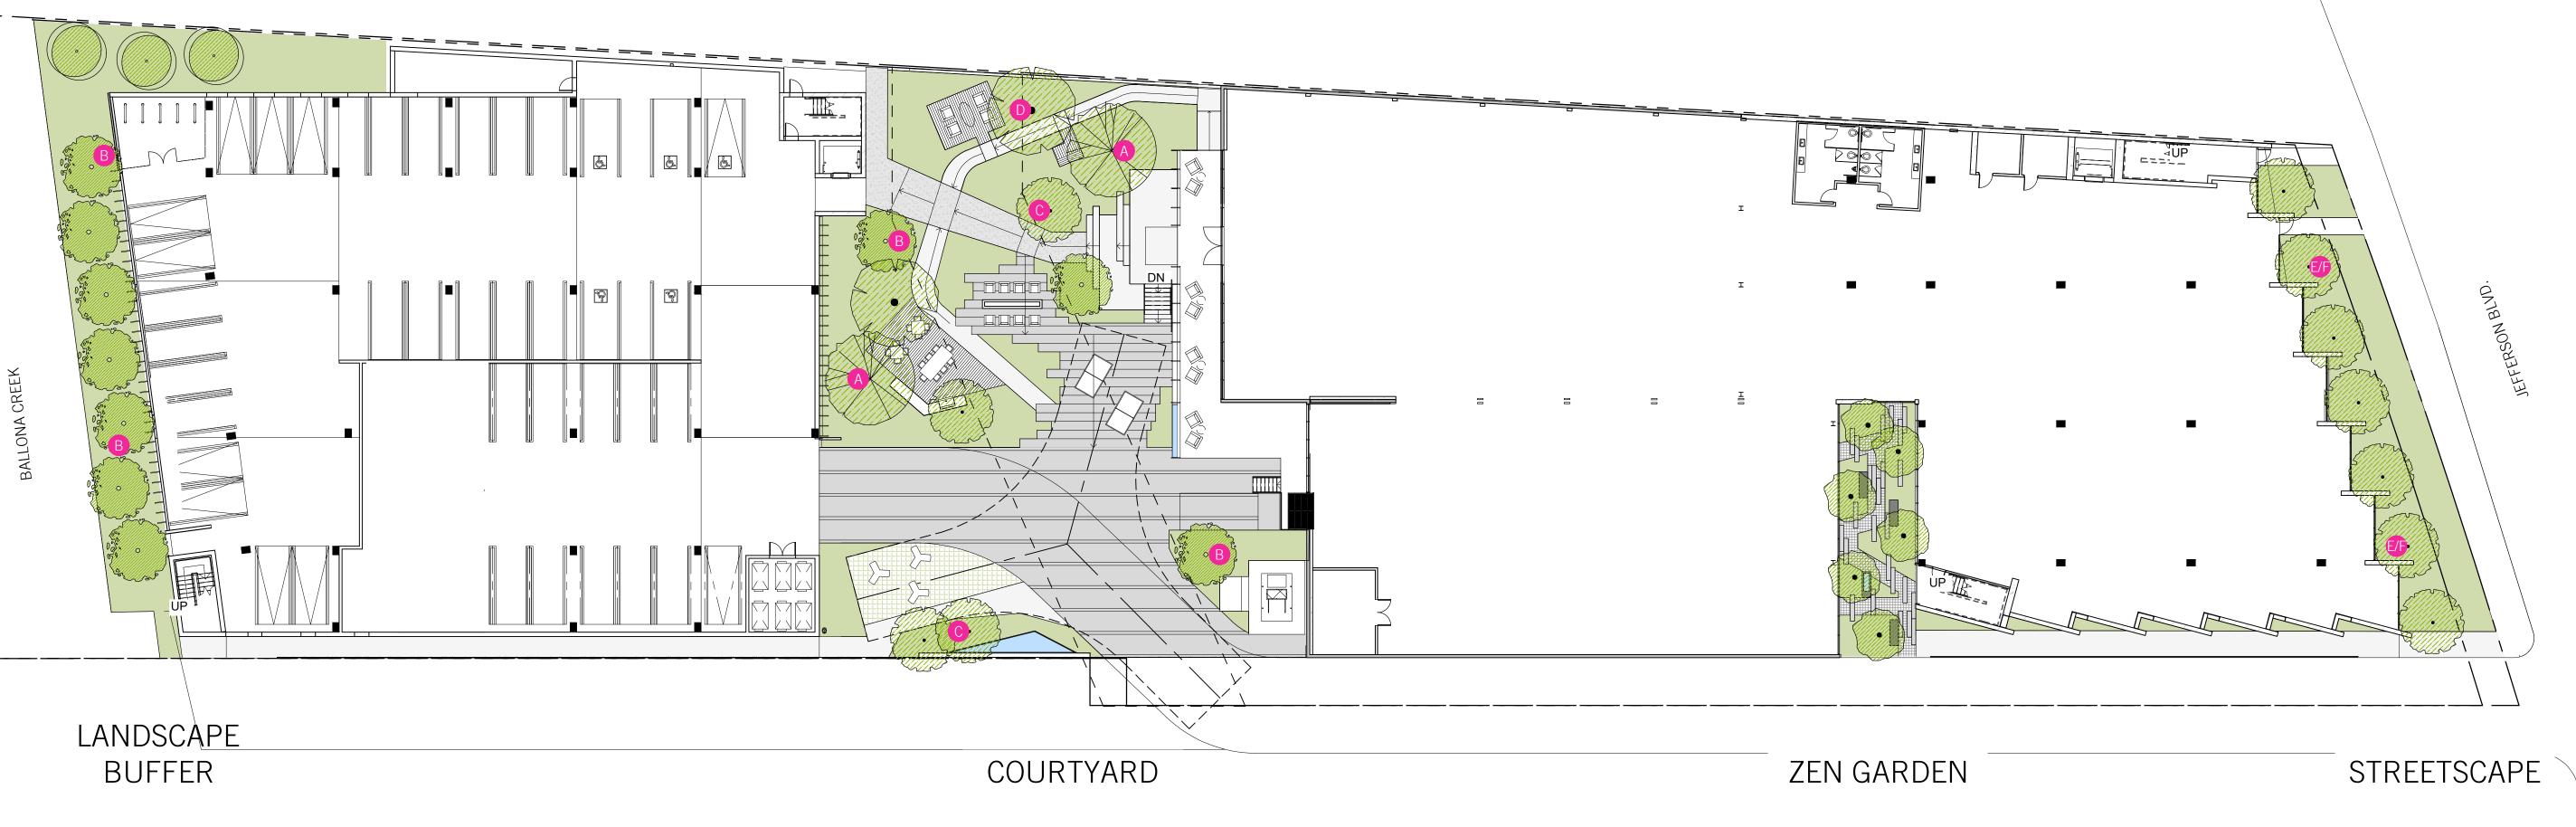

SITE PLAN SCALE: 1"=20'-0"

Lophostemon confertus

30'-50' H x 10'-30' W

Brisbane Box

Bauhinia blakeana

20'-30' H x 20'-35' W

Adenanthos sericeus

COURTYARD PALETTE

Coast Woolbush

6'-10' H x 4'-6' W

Bauhinia

Dietes grandiflora Lomandra longifolia Fortnight Lily 3'-4' H x 4'-6' W Mat Rush 4'-5' H x 4'-6' W


Olea europaea 'Fruitless'


15'-25' H x 15'-20' W

Fruitless Olive

Little Ollie 6'-8' H x 4'-5' W



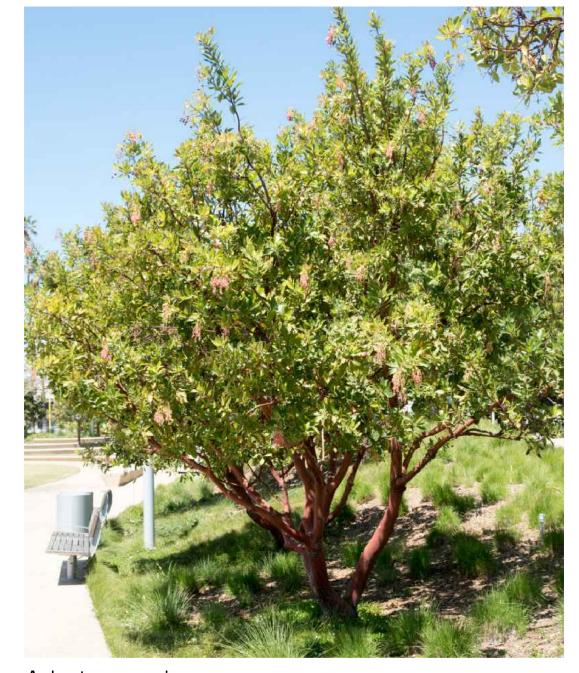

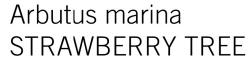




Lophostemon confertus BRISBANE BOX

- PROPOSED TREE PLANTING ALONG BALLONA CREEK TRISTANIA CONFERTA (BRISBANE BOX) PLANTED AT 15 FEET ON CENTER TO SCREEN BUILDING. 7 TREES TOTAL.
- SIZE OF TREES AT PLANTING APPROXIMATELY 18 FEET TO 22 FEET IN HEIGHT. TREE SIZE AT MATURITY APPROXIMATELY 30 FEET TO 35 FEET IN HEIGHT WITH 15 FEET TO 30 FEET WIDE CANOPY.
- ALL TRISTANIA TREES TO BE LOW-BRANCHING AND WILL BE SELECTED AND TAGGED BY PROJECT LANDSCAPE ARCHITECT FOR DELIVERY TO SITE. TAGGING WILL BE DONE FOR 18 FEET TO 22 FEET HIGH TREES PENDING AVAILABILITY. LANDSCAPE ARCHITECT TO PROVIDE PHOTO EVIDENCE OF TAGGED TREES TO CURRENT PLANNING DIVISION PRIOR TO SITE DELIVERY.
- UNDERSTORY PLANTING BELOW TREES TO BE A VARIETY OF TALL SHRUBS 6 FEET TO 10 FEET AT MATURITY INCLUDING HETEROMELES ARBUTIFOLIA (TOYON).
- E. NO TREE OR SHRUB PLANTING WILL BE DECIDUOUS.
- VINE PLANTING WILL BE FICUS PUMILIA (CREEPING FIG) AND USED TO COVER STAIR AND ELEVATOR TOWER WALLS AT REAR OF GARAGE.
- G SMALL EVERGREEN TREE ARBUTUS MARINA (MARINA STRAWBERRY TREE) TO BE PROVIDED ALONG EASTERLY PARKING STRUCTURE PROPERTY LINE AND NORTH TOWARD THE BALLONA CREEK.

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Heteromeles arbutifolia 'Davis Gold' DAVIS GOLD TOYON

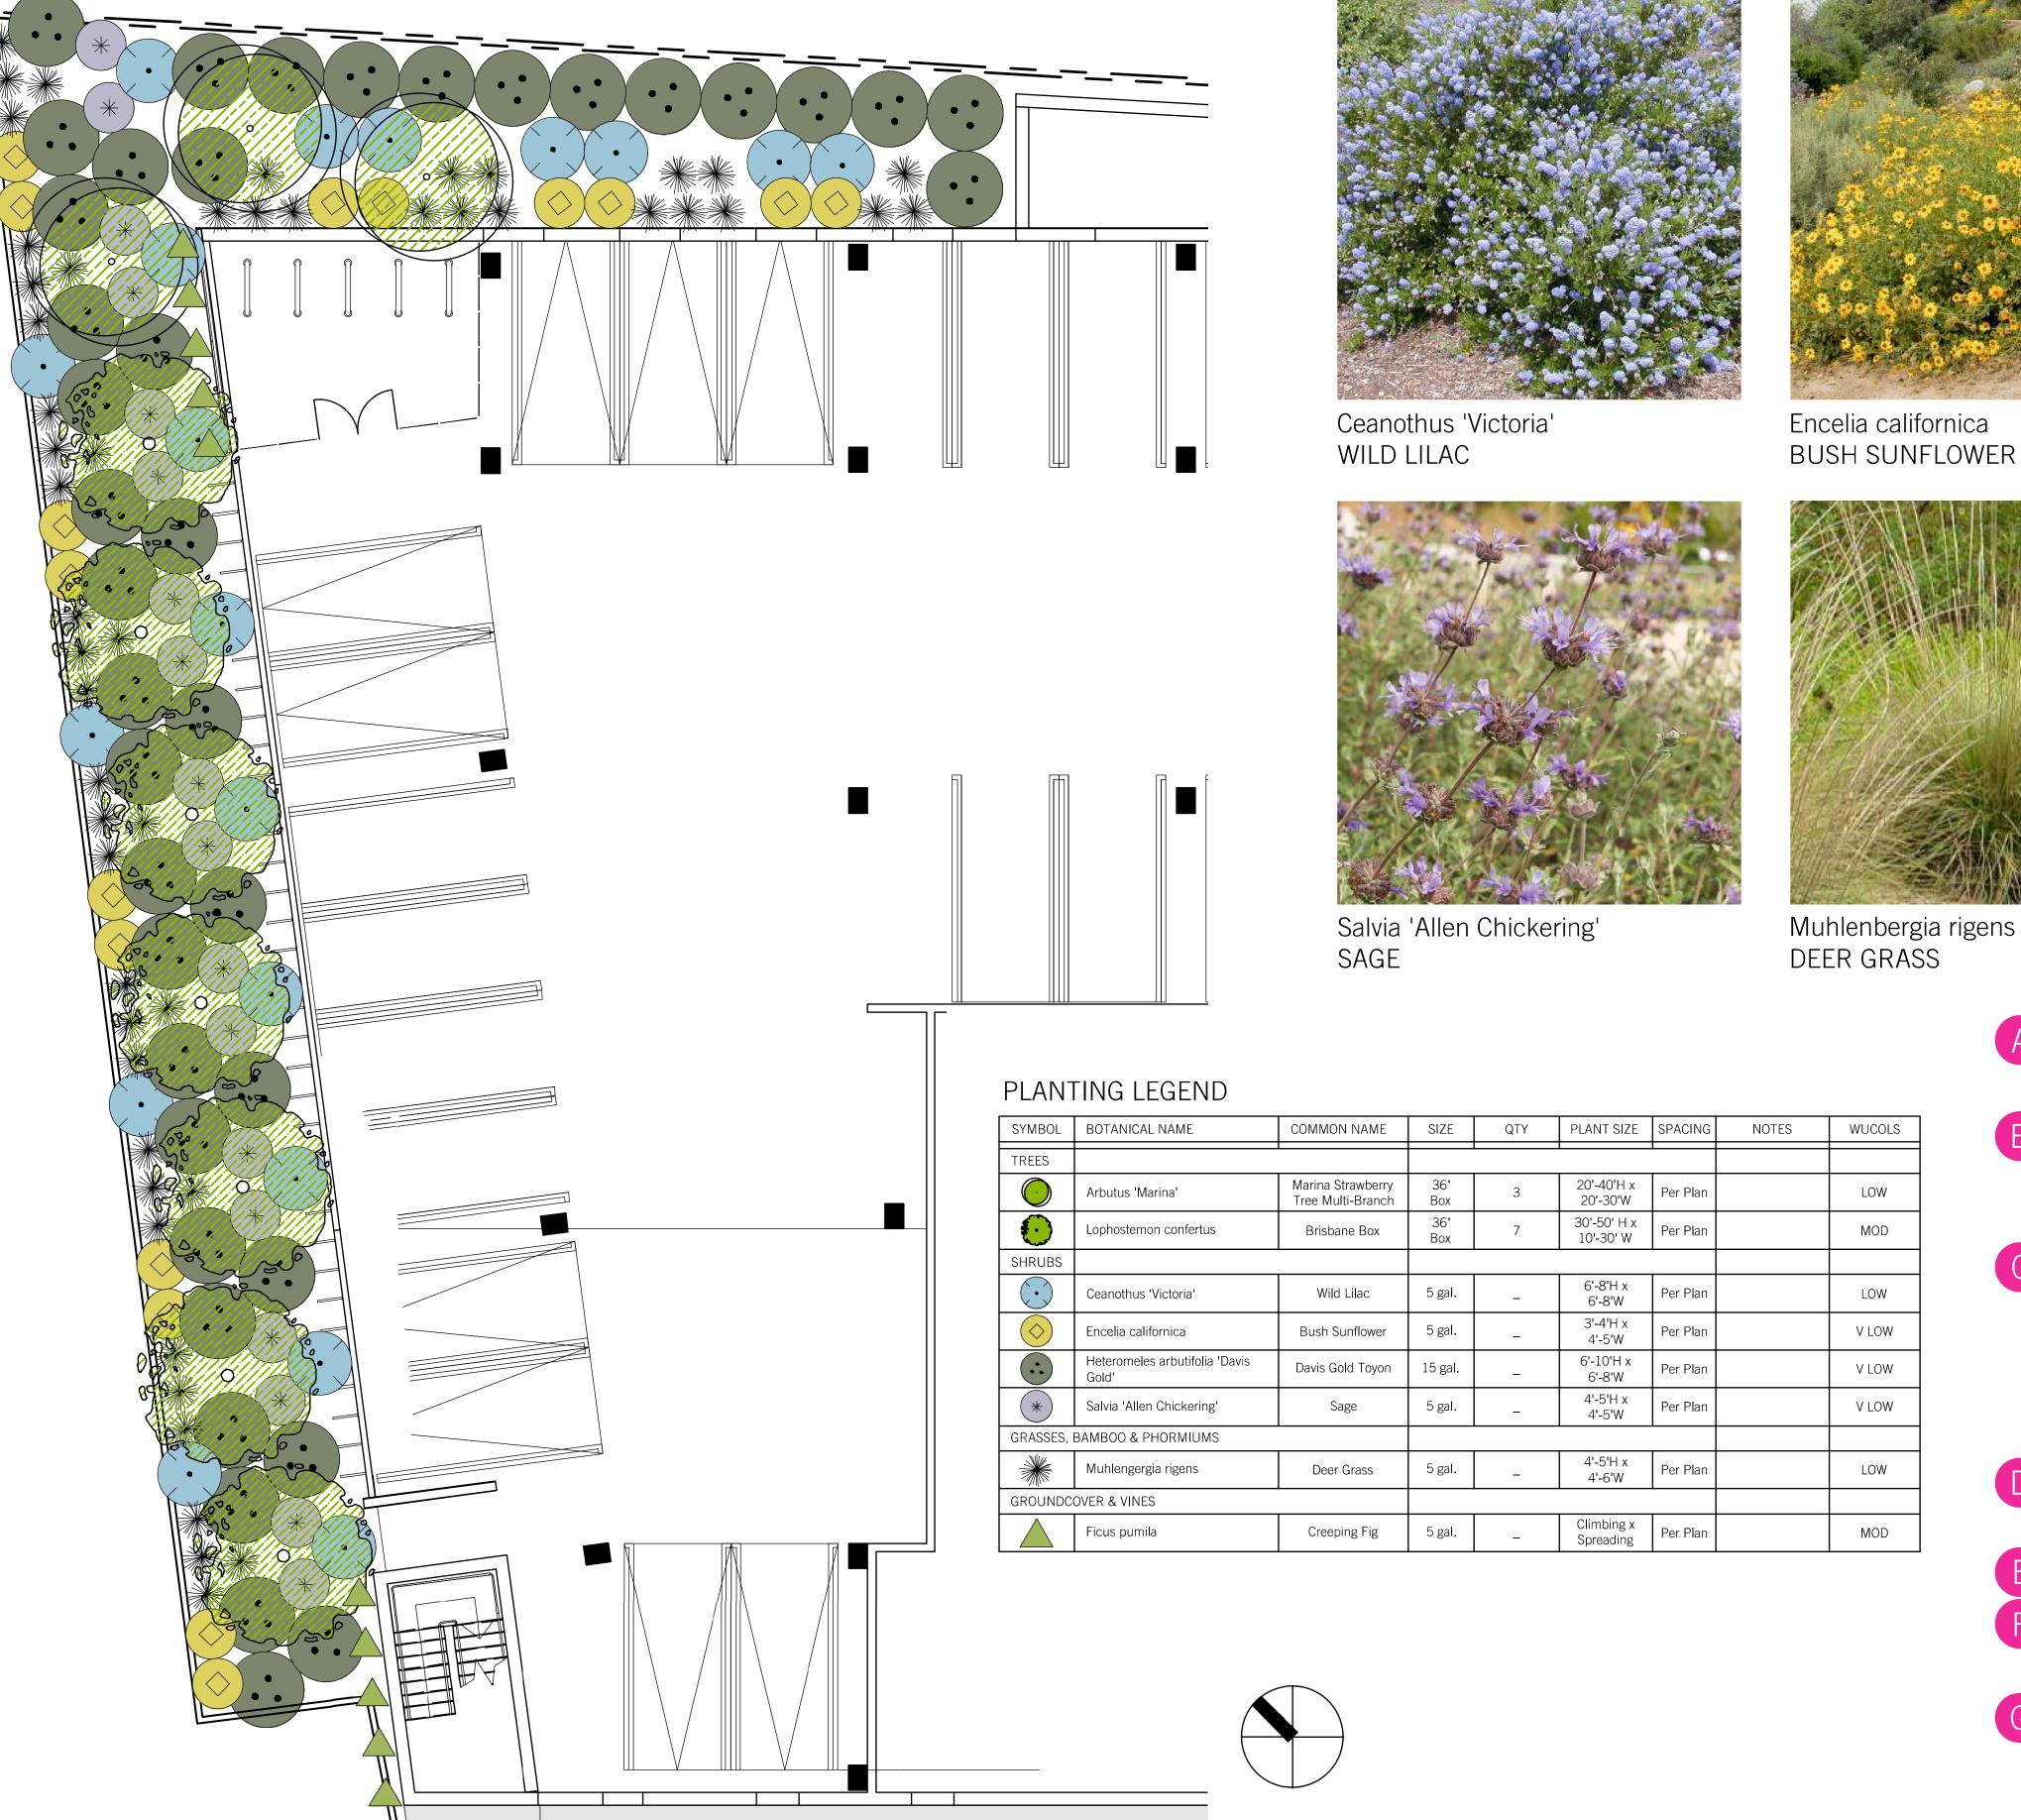

Ficus pumila CREEPING FIG

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SCALE: $\frac{1}{16}$ " = 1'-0"