PROJECT SITE Project Boundary Project Boundary Project Boundary

PARKING SUMMARY:

**PREFERRED PARKING FOR VAN POOL/CAR POOL/CLEAN AIR

USER GROUP

HOTEL (VALET)

RESIDENTIAL GUEST

Note 2: RESIDENTIAL TANDEM SPACES SHALL BE ASSIGNED TO A SINGLE UNIT

Note 4: ALTERNATE COMPACT STALL COUNT= 68 (35 HOTEL VALET + 33 OTHER USES) =5%

METRO

SHUTTLE

OFFICE

RETAIL

OFFICE

PARKING REQUIRED*

497

210

217

250

1524

USER GROUP

RESIDENTIAL

PARKING LEVEL

GROUND FLOOR

LEVEL P3

OVERALL TOTAL

****INCLUDED IN COUNTS

STD.= STANDARD STALL

COMP. = COMPACT STALL

TOTAL

RETAIL/RESTAURANT

RESIDENTIAL GUEST

*INCLUDES 2 SHUTTLE BUS SPACES

PARKING COUNT PER LEVEL

Project Boundary Commercial Commercial Residential Light Industrial Commercial Residential Retail/Residential Commercial/School School Community Commercial/School Community Commercial/School Community Commercial/School Community Co

SURROUNDING LAND USES

EV CAPABLE

VAN ACC.***

TAND. = TANDEM STALL

126

429

210

321

57

300

173

REQUIRED

40 17

18

***INCLUDES 8 PREFERRED PARKING STALLS FOR OFFICE RETAIL/RESTAURANT

PARKING PROVIDED

see Notes 1-3

32

PROVIDED

18

129

PARKING PROVIDED*

497

210

223

250

Note 4)

41

14

Note 1: TANDEM SPACES FOR OFFICE SHALL HAVE AN ATTENDANT OR VALET SERVICE AT ALL TIMES THAT THE PARKING IS ACCESSIBLE TO USERS.

VAN ACC. = VAN ACCESSIBLE PARKING STALL

ACC. = ACCESSIBLE PARKING STALL

Note 3: TANDEM SET COUNT= 88 DOUBLES (RESIDENTIAL & OFFICE) + 20 DOUBLES (HOTEL VALET), 17 TRIPLES (HOTEL VALET ONLY), 10 QUADRUPLES (HOTEL VALET ONLY).

109

241

57

156

1138



PROJECT SUMMARY TABLE:

IVY STATION: PROJECT INFO

IVY STATION IS A PROPOSED DEVELOPMENT IN CULVER CITY, BOUNDED BY VENICE BOULEVARD, NATIONAL BOULEVARD, WASHINGTON BOULEVARD, AND THE MTA EXPO LINE CULVER CITY STATION. THE DEVELOPMENT INCLUDES HOTEL, RESIDENTIAL, AND OFFICE COMPONENTS. THE DEVELOPMENT WILL CONTAIN A TOTAL OF 1,538 PARKING STALLS WITH 1,490 STALLS BELOW GRADE ON THREE LEVELS, AND 48 PARKING STALLS ABOVE GRADE ON THE GROUND LEVEL.

LEGAL DESCRIPTION:

PARCEL A:

LOTS 1 THROUGH 52, INCLUSIVE OF TRACT NO. 5461, PARTLY IN THE CITY OF CULVER CITY, COUNTY OF LOS ANGELES, STATE OF CALIFORNIA, AS PER MAP RECORDED IN BOOK 57, PAGE 76 OF MAPS, IN THE OFFICE OF THE COUNTY RECORDER OF SAID COUNTY. EXCEPTING THEREFROM ALL OIL, OIL RIGHTS, NATURAL GAS RIGHTS, MINERAL RIGHTS, ALL OTHER HYDROCARBON SUBSTANCES BY WHATSOEVER NAME KNOWN, AND ALL WATER, CLAIMS OR RIGHTS TO WATER, TOGETHER WITH APPURTENANT RIGHTS THERETO, WITHOUT HOWEVER, THE RIGHT TO ENTER UPON THE SURFACE OF SAID LAND AS RESERVED BY DEEDS OF RECORD.

DARCEL

PARCEL B:
ALL THE PARCEL OF LANDS SITUATED, LYING AND BEING IN THE COUNTY OF
LOS ANGELES, STATE OF CALIFORNIA, BEING THAT PORTION OF THAT PART
OF RANCHO RINCON DE LOS BUEYES, AS SHOWN ON A MAP RECORDED IN
BOOK 1, PAGES 207 AND 208 OF PATENTS, AS DESCRIBED IN THAT CERTAIN
DEED FROM FRANCISCO HIGUERRA TO THE LOS ANGELES AND
INDEPENDENCE RAILROAD COMPANY, RECORDED IN BOOK 47, PAGE 152 AND
IN BOOK 53, PAGE 522 BOTH OF DEEDS, IN THE OFFICE OF THE COUNTY
RECORDER OF SAID COUNTY, AND THAT PORTION OF THAT PART OF
RANCHO RINCON DE LOS BUEYES, PROPERTY OF CLEMENTE C. DE
CORONEL, AS PER MAP RECORDED IN BOOK 13, PAGE 18 OF
MISCELLANEOUS RECORDS, IN THE OFFICE OF THE COUNTY RECORDER OF
SAID COUNTY, AS DESCRIBED IN THAT CERTAIN DEED FROM CLEMENTA
CRUZ DE CORONEL, WIFE OF MANUEL CORONEL TO THE LOS ANGELES AND
INDEPENDENCE RAILROAD COMPANY, RECORDED IN BOOK 53, PAGE 535 OF
DEEDS OF THE COUNTY RECORDER OF SAID COUNTY.

EXCEPT THEREFROM THAT PORTION OF SAID LAND LYING NORTHWESTERLY OF SOUTHEASTERLY LINE OF VENICE BOULEVARD 155 FEET WIDE AND THAT PORTION OF SAID LAND LYING WESTERLY OF THE EASTERLY LINE OF ROBERTSON BOULEVARD OF VARIOUS WIDTH AS BOTH STREETS SHOWN ON PARCEL MAP NO. 16367, PARCEL MAP NO. L.A. NO. 5735 FILED IN BOOK 203, PAGES 57 AND 58 OF PARCEL MAPS.

ALSO EXCEPT THEREFROM THAT PORTION LYING SOUTHEASTERLY OF THE NORTHWESTERLY LINES OF WASHINGTON BOULEVARD 60 FEET WIDE. THE LEGAL DESCRIPTION SHOWN HEREIN IS PROFORMA ONLY AND THE REQUIREMENT THAT ALL PARTIES INVOLVED APPROVED SAID DESCRIPTION.

APN(S): 4312-014-270 THRU 4312-014-281; 4213-014-900 THRU 4213-014-920; AND 4213-031-900 AND 4213-031-901

GROSS AREAS:

OFFICE GROSS AREA: OFFICE:

 RETAIL:
 17,705 SF

 RESTAURANT:
 7,550 SF

 TOTAL:
 199,287 SF

174,032 SF

RESIDENTIAL & UTILITY

 RESIDENTIAL & UTILITY

 & EXTERIOR AREAS:
 247,996 SF

 RETAIL:
 17,296 SF

 RESTAURANT:
 5,415 SF

 TOTAL:
 270,707 SF

HOTEL GROSS AREA:

HOTEL: 113,467 SF RETAIL: 1,048 SF RESTAURANT: 3,489 SF TOTAL: 118,004 SF

TOTAL FOR ALL BUILDINGS ON SITE: 1,239,660 SF

PROJECT DIRECTORY:

CLIENT / TENANT:

LOS ANGELES ALE WORKS
ATTN: ANDREW FOWLER
E:FOWLER@LAALEWORKS.COM

TENANT SERVICES:

LOWE ENTERPRISES
11777 SAN VICENTE BL, SUITE 900
LOS ANGELES, CA 90049
CONTACT: RYAN BURTON
T: 310.571.4317
E: RBURTON@LOWE-RE.COM

ARCHITECT:

STUDIO Hamilton Tyni

OLIENT

LOS ANGILOS ALE WORKS

ROOM
JUIC BEVERAGE SALES
ION
Shington Blvd

PROJECT:
OS ANG
ASTING
ALCOHO

SHEET INDEX:

CUP-1 COVER SHEET
CUP-2 EXISTING ABOVE-GRADE
FEATURES

CUP-3 SITE PLAN
CUP-4 FLOOR PLAN

CUP-5 APPROVED BUILIDNG ELEV
CUP-6 PROPOSED BUILDING ELEV

CUP-6 PROPOSED BUILDING
CUP-7 MATERIAL BOARD
CUP-8 RENDERINGS
CUP-9 RENDERINGS

CUP-10 RENDERINGS


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KEY PLAN



SHEET TITLE:

COVER SHEET

LOS AMBRELOS ALE WORKS

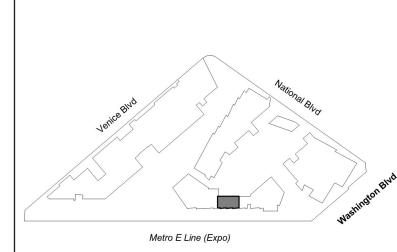CONDITIONAL USE PERMIT - SUBMITTAL

SUITE 132 & 133

JUN 2 0 2000

APPROVED

JUN 20 7018 Culver C 1/ Planning Division

OFFICE BUILDING PERMIT FROM TOP OF GROUND LEVEL STRUCTURAL SLAB AND UP

HOTEL BUILDING PERMIT FROM TOP OF GROUND LEVEL STRUCTURAL SLAB AND UP

RESIDENTIAL BUILDING PERMIT FROM TOP OF GROUND LEVEL STRUCTURAL SLAB AND UP

ADDRESS:
IVY STATION
8809 Washington Blvd
Suite 132 & 133
Culver City, CA 90232

DRAWN: SCALE:

SHEET NUMBER:





- 1. PARKING SPACES THAT SERVE A PARTICULAR BUILDING SHALL BE LOCATED ON THE SHORTEST ACCESSIBLE ROUTE FROM PARKING TO AN ENTRANCE. CBC AAB-208.3.1
 - ADDITIONAL LANGUAGE OR AN ADDITIONAL SIGN BELOW THE INTERNATIONAL SYMBOL OF ACCESSIBILITY SHALL STATE "MINIMUM FINE \$250." CBC2016 11B-502.6.2
- SLOPE OF ACCESSIBLE PARKING STALLS, UNLOADING ZONE, AND ASSOCIATED ACCESSIBLE ROUTES SHALL NOT EXCEED THE ALLOWABLE CROSS SLOPE OF 1:48
- AISLE WIDTH BASED ON LADBS P/ZC 2002-001 TABLE 3: PARKING BAY WIDTHS FOR TWO-WAYTRAFFIC AND DOUBLE LOADED AISLES - BASED ON A 90 DEGREE STALL
- 5. TYPICAL STALL WIDTH BASED ON P/ZC 2002-001 SECTION 1A LINE ITEM 2 - STANDARD STALL WIDTH.
- DRIVEWAY PROVIDED PER P/ZC 2002-001 ITEM 1G, LINE ITEM 3 FOR ZONING TYPES M & R
- FLOOR AND GROUND SURFACES SHALL BE STABLE, FIRM, AND SLIP RESISTANT
- PUBLIC ACCOMODATIONS SHALL MAINTAIN IN OPERABLE WORKING CONDITION THOSE FEATURES OF FACILITIES AND EQUIPMENT THAT ARE REQUIRED TO BE ACCESSIBLE TO AND USEABLE BY PERSONS WITH DISABILITIES. ISOLATED OR TEMPORARY INTERRUPTIONS IN SERVICE OR ACCESSIBILITY DUE TO MAINTENANCE OR REPAIRS SHALL BE PERMITTED. §11B-108

ACCESSIBLE PATH OF TRAVEL LEGEND

■ ■ ■ ■ ■ ■ ■ ■ INDICATES ACCESSIBLE PATH OF TRAVEL AS INDICATED ON PLAN. PATH IS A BARRIER FREE ACCESS ROUTE WITHOUT ANY ABRUPT LEVEL CHANGES EXCEEDING 1/2" IF BEVEL AT 1:2 MAX SLOPE, OR VERTICAL LEVEL CHANGES NOT EXCEEDING 1/4" AND AT LEAST 48" IN WIDTH. THE SURFACE IS STABLE, FIRM AND SLIP RESISTANT. CROSS SLOPE DOES NOT EXCEED 2% AND SLOPE IN THE DIRECTION OF TRAVEL IS LESS THAN 5% SLOPE, UNLESS OTHERWISE INDICATED, LANDING AT DOORWAYS

> ACCESSIBLE PATH OF TRAVEL SHALL BE MAINTAINED FREE OF OVERHANG OBSTRUCTIONS TO 84" MINIMUM HEIGHT AND PROTRUDING OBJECTS GREATER THAN 4" PROJECTING FROM WALL AND ABOVE 27" AND LESS THAN 84"



210 25TH STREET, SANTA MONICA, CA p: 310.749.1862

LOS Angeles Ale Works

LOS ANGELES ALE V TASTING ROOM

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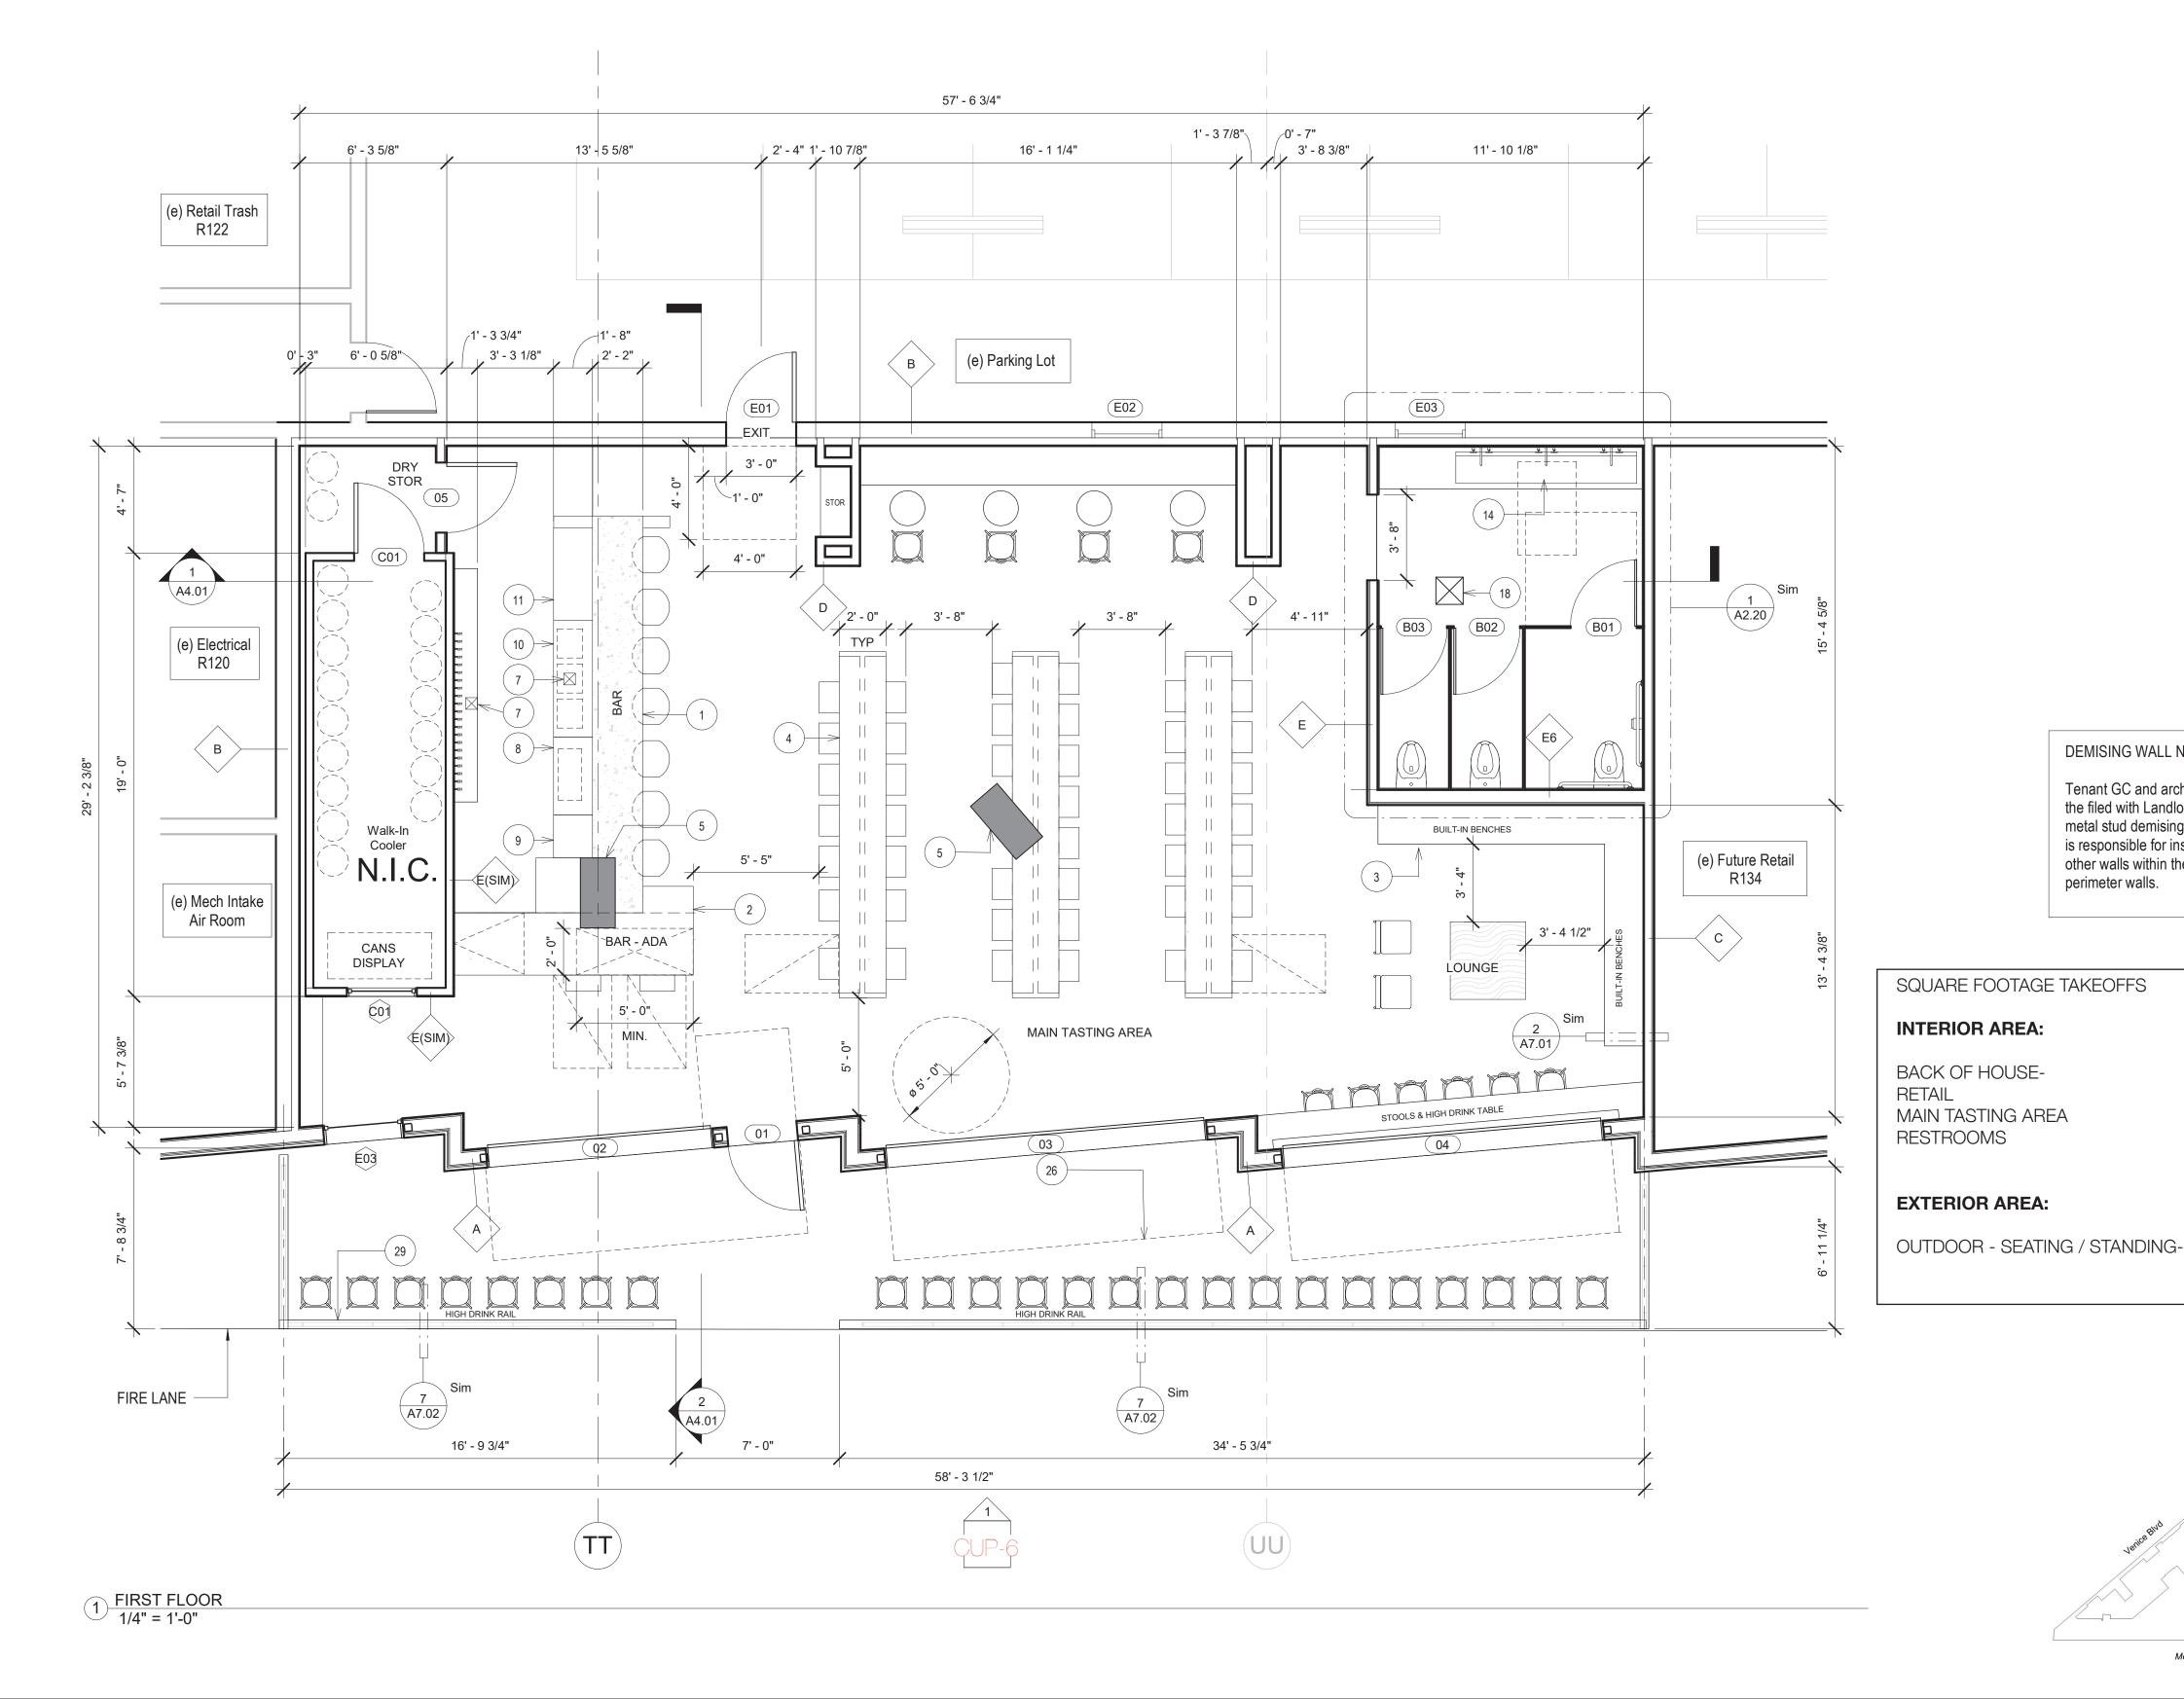
SHEET TITLE

SITE PLAN

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Author As indicated Project Number

SHEET NUMBER:



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LOS Angulas ALE WORKS


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SHEET TITLE

FLOOR PLAN

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As indicated

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PLAN NOTES

- CUSTOM BAR COUNTERTOP +42" AFF. SEE MILLWORK DETAILS
- ADA COUNTERTOP + 34" AFF. SEE MILLWORK DETAILS CUSTOM BUILT-IN BENCH, FIXED-IN-PLACE. SEE MILLWORK DETAILS
- **CUSTOM SEATING TABLES & CHAIRS**
- EXISTING CONCRETE COLUMN TO REMAIN
- FLOOR DRAIN. SEE PLUMBING DRAWINGS BAR EQUIPMENT: DUMP SINK
- BAR EQUIPMENT: DISHWASHER 10 BAR EQUIPMENT: 3-COMP SINK
- BAR EQUIPMENT: COUNTERTOP & STORAGE SHELVES
- ACCESSIBLE SINK AND FAUCET AND PIPING PROTECTION

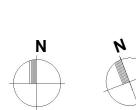KEYNOTES

- 16 GRAB BAR
- 17 ACCESSIBLE TOILET, 17" MIN AND 19" MAX MEASURED TO THE TOP OF THE SEAT
- 18 MECHANICAL EXHAUST SYSTEM FOR TOILET ROOM, MINIMUM 50 CFM. SEE MECHANICAL DRAWINGS.
- 23 EXISTING METAL CLADDING FACADE TO REMAIN. GC TO PROTECT AT ALL TIMES DURING CONSTRUCTION
- 24 (E) MECHANICAL LOUVER PANELS ABOVE STOREFRONT
- 25 (N) GARAGE ROLL UP DOOR, SEE SCHEDULE
- 26 (E) CANOPY, APPROVED IN SHELL & CORE DRAWINGS. SEE DETAIL
- 29 (N) COUNTER RAIL. SEE MILLWORK DETAILS
- 30 G.C. TO PROVIDE INTERNATIONAL SYMBOL OF ACCESSIBILITY SIGN MOUNTED AT 60 AFF. SEE SHEET G0.04
- 33 WALL HUNG ACCESSIBLE FAUCET. (REQUIRED INSTALLATION OF EXPANSION ANCHORS THAT ARE DRILLED)

- DOOR JAMB 4" AWAY FROM ADJACENT WALL, MIN. SMOKE AND FIRE DAMPERS MUST BE INSTALLED IN THE FOLLOWING LOCATIONS PER SECTIONS 717.5 DUCTS PENTRATING SMOKE BARRIERS
 - DUCTS PENETRATING HORIZONTAL ASSEMBLIES (717.6)
- BUILDING WITH FLOOR AREAS OVER 1500 SF SHALL BE SPRINKLERED WHERE 20 SF OF OPENING FOR EVERY 50 FT OF WALL LENGTH IS NOT PROVIDED.
- VERTICAL CHANGES IN LEVEL FOR FLOOR OR GROUND SURFACES MAY BE 1/4 INCH HIGH MAXIMUM AND WITHOUT EDGE TREATMENT. CHANGES IN LEVEL GREATER THAN 1/4" AND NOT EXCEEDING 1/2" IN HEIGHT SHALL BE BEVELED WITH A SLOPE NOT STEEPER THAN 1:2.
- EXIT SIGNS SHALL BE INTERNALLY OR EXTERNALLY ILLUMINATED. 8. INTERNALLY ILLUMINATED EXIT SIGNS SHALL BE LISTED AND LABELED AND SHALL BE INSTALLED IN ACCORDANCE WITH THE MANUFACTURE INSTRUCTIONS AND SECTION 2701. EXTERNALLY ILLUMINATED EXIT SIGNS SHALL COMPLY WITH THE GRAPHIC AND POWER SOURCE REQUIREMENTS IN SECTION 1013.6.1 AND 1013.6.3M RESPECTIVELY. WHEN THE FACE OF AN EXIT SIGN IS ILLUMINATED FROM AN EXTERNAL SOURCE, IT SHALL HAVE AN INTENSITY OF NOT LESS THAN 5-FOOT-CANDLES (54 LUX). (1013.3,
- 1013.5, 1013.6) ANY TIME A BUILDING OR A PORTION OF A BUILDING IS OCCUPIED, THE MEANS OF EGRESS SERVING THE OCCUPIED PORTION SHALL BE ILLUMINATED AT AN INTENSITY OF NOT LESS THAN 1 FOOT CANDLE (11 LUX) AT THE WALKING SURFACE LEVEL. (1008) THE EXIT SIGNS SHALL ALSO BE CONNECTED TO AN EMERGENCY ELECTRICAL SYSTEM WHICH IS TO BE PROVIDE CONTINUD ILLUMINATION FOR DURATION OF NOT LESS THAN 1-1/2 HR. IN CASE OF PRIMARY POWER LOSS. CONTINUED ILLUMINATION IS TO BE PROVIDED FROM STORAGE BATTERIES, UNIT EQUIPMENT, OR AN ON-SITE GENERATOR AND TEH INSTALLATION OF THE

EMERGENCY POWER SYSTEM SHALL BE INSTALLED IN

ACCORDACNE WITH SECTION 2702. (1013.6.3)

- ALL FLOOR AND GROUND SURFACES SHALL BE STABLE, FIRM, AND 15. SLIP RESISTANT ALL EXISTING INTERIOR FLOOR SURFACES ARE CONCRETE UNLESS
- ALL INTERIOR FINISHES/MATERIALS APPLIED TO WALLS AND CEILING SHALL BE TESTED AS SPECIFIED IN SECTION 803, TO MAINTAIN A CLASS B / C FLAME SPREAD AND SMOKEDEVELOPED
- INDEX. SEE TABLE 803.11 ARCHITECTURAL PAINTS AND COATINGS, ADHESIVES, CAULKS AND SEALANTS SHALL COMPLY WITH THE VOLATILE ORGANIC COMPOUND (VOC) LIMITS LISTED IN TABLES 5.504.4.1-5.504.4.3
- MATERIALS USED IN SUCH WALLS SHALL BE OF A TYPE THAT IS NOT ADVERSELY AFFECTED BY MOISTURE. (1210.2.2) PUBLIC TOILET ROOMS SHALL BE PROVIDED WITH A MECHANICAL EACH WATER CLOSET. (MC TABLE 403.7)
- ABRUPT CHANGES IN LEVEL EXCEEDING 4 INCHES IN VERTICAL DIMENSION BETWEEN WALKS, SIDEWALKS OR OTHER PEDESTRIAN WAYS AND ADJACENT SURFACES OR FEATURES NOTED OTHERWISE ON PLANS SHALL BE IDENTIFIED BY WARNING CURBS AT LEAST 6" IN HEIGHT

DEMISING WALL NOTES:

perimeter walls.

Tenant GC and architect must coordinate in the filed with Landlord for exact location of the metal stud demising wall. Additionally, Tenant

is responsible for insulation and drywall on any

Metro E Line (Expo)

ABOVE THE WALK OR SIDEWALK SURFACE OR BY GUARDS OR

RAIL CENTERED 2 IN" MIN. AND 4" MAX.ABOVE THE SURFACE OF

THE WALK OR SIDEWALK. THESE REQUIREMENTS DO NOT APPLY

BETWEEN A WALK OR SIDEWALK AND AN ADJACENT STREET OR

ALL ELECTRICAL OUTLET COVERS AND SECURITY CAMERAS MUST

IN SEAMLESSLY WITH THE SURFACE ON WHICH IT IS MOUNTED.

THE STOREFRONT ARE INTEGRATED WITHIN THE STOREFRONT

ENSURE THAT ALL SECURITY DEVICES AND SYSTEMS LOCATED AT

HAVE A COVER PLATE WHICH ALLOWS THE EQUIPMENT TO BLEND

CHANGES IN LEVEL GREATER THAN 1/2" IN HEIGHT SHALL BE

11B-405 RAMPS OR 11B-406 CURB RAMPS AS APPLICABLE.

RAMPED AND SHALL COMPLY WITH THE REQUIREMENTS OF

HANDRAILS WITH A GUIDE

DESIGN AND FINISHES

285 SQFT

110 SQFT 1110 SQFT

180 SQFT


440 SQFT

1685 SQFT

other walls within the space, including the

- TOILET AND BATHING ROOM FLOORS SHALL HAVE A SMOOTH, HARD. NONABSORBENT SURFACE THAT EXTENDS UPWATD ONTO THE WALLS AT LEAST 4-IN. (1210.2.1) WALLS WITHIN 2-FT. OF WATER CLOSETS SHALL HAVE A SMOOTH. HARD, NONABSORBENT SURFACE, TO A HEIGHT OF 4-FT. ABOVE THE FLOOR, AND EXCEPT FOR STRUCTURAL ELEMENTS, THE
- EXHAUST SYSTEM CAPABLE OF PROVIDING A MINIMUM 50 CFM FOR



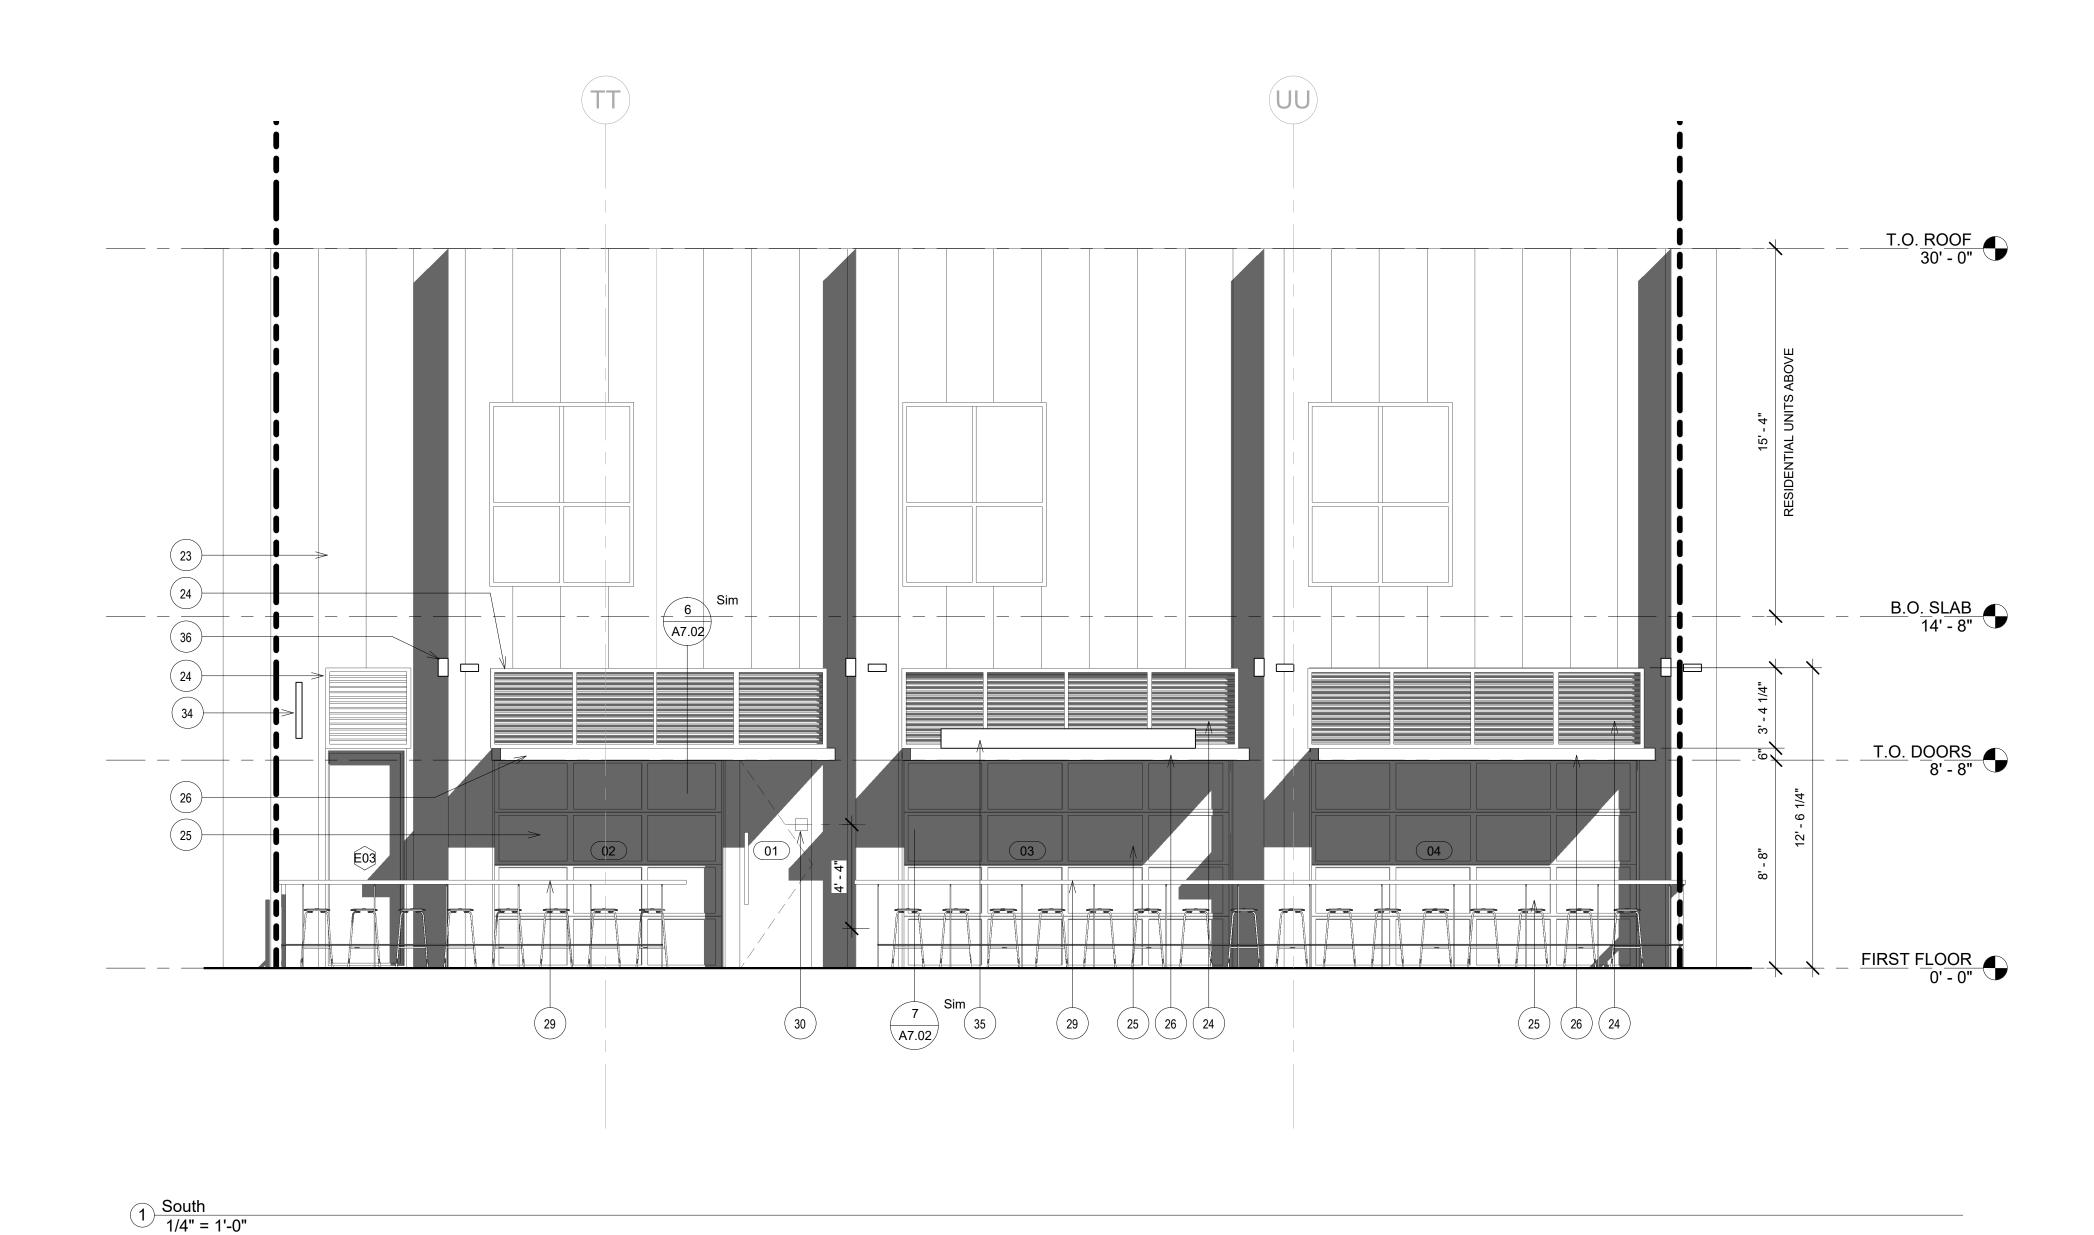

KEYNOTES

- 23 EXISTING METAL CLADDING FACADE TO REMAIN. GC TO PROTECT AT ALL TIMES DURING CONSTRUCTION
- 24 (E) MECHANICAL LOUVER PANELS ABOVE STOREFRONT
- 25 (N) GARAGE ROLL UP DOOR, SEE SCHEDULE
- 26 (E) CANOPY, APPROVED IN SHELL & CORE DRAWINGS. SEE DETAIL
- 29 (N) COUNTER RAIL. SEE MILLWORK DETAILS
- 30 G.C. TO PROVIDE INTERNATIONAL SYMBOL OF ACCESSIBILITY SIGN MOUNTED AT 60 AFF. SEE SHEET G0.04
- 34 TENANT BLADE SIGN, UNDER SEPARATE PERMIT
- 35 TENANT CANOPY SIGN, UNDER SEPARAET PERMIT
- 36 LANDLORD INSTALLED WALL SCONCES, PER CORE & SHELL DRAWINGS

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p: 310.749.1862

LOS Angulas Ale Works

PROJECT:

LOS ANGELES ALE WORKS

TASTING ROOM

ADDRESS:


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SCALE: 1/4" = 1'-0"

JOB: Project Number

SHEET NUMBER:



CANOPY_CORRUGATED METAL PAINTED TO MATCH ROLL UP DOORS

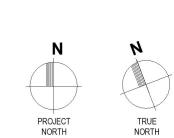

EXTERIOR DRINK RAIL _ STEEL PLATE POWDER COATED FINISH WITH TEAK TOP RAIL



ENTRY DOOR _ METAL DOOR CLAD WITH VERTICAL

TEAK WOOD STRIPS

EXTERIOR PLANTERS _ SEE RENDERINGS FOR PLACEMENT



CANOPY DOWN LIGHT





APPROVED BUILDING EXTERIOR LIGHTING (PER CORE & SHELL DRAWINGS)



ROLL UP DOORS _ Color to Match Development Storefronts (70% Kynar to match PPG CL3176N RACOON)



BENJAMIN MOORE PAINT TO MATCH (70% Kynar to match PPG CL3176N RACOON)



EXTERIOR STOOL _ MATTIAZZI _ MC16 (* EXACT SPEC / MODEL NUMBER IS DEPENDENT ON LEAD TIME / AVAILABILITY / BUDGET AND QUANTITY. SUBJECT TO CHANGE)



TEAK WOOD _ DRINK RAIL CAP

STUDIO Hamilton Tyni

Eas Angreles Ale Works

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SHEET TITLE:

MATERIAL BOARD

SCALE:

SHEET NUMBER:





STUDIO Hamilton Tyni

LOS Angeles Ale Works

LOS ANGELES ALE WORKS
TASTING ROOM
(ALCOHOLIC BEVERAGE SALES
ADDRESS:

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SHEET TITLE:

RENDERINGS

DRAWN:

SCALE:

SHEET NUMBER:





STUDIO Hamilton Tyni

Cos Angulas Ale Works

STING ROOM
COHOLIC BEVERAGE SALES)

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HAMILTON TYNI.

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RENDERINGS

DRAWN:

SCALE:

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STUDIO Hamilton Tyni

Los Angulas Ale Works

OS ANGELES ALE WORKS
STING ROOM
LCOHOLIC BEVERAGE SALES)

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DRAWN:

SCALE:

SHEET NUMBER:

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