3800 SEPULVEDA BLVD.

SCOPE OF WORK

CONSTRUCTING A 3,824 sf NEW, GROUND-UP BUILD OF A STATE-OF-THE-ART DISPENSARY WITH THE PROPOSED USE FOR RETAIL CANNABIS BUSINESS STORE-FRONT.

SHEET INDEX

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	A002	ALTA SURVEY	•	L-1.1	TREE DISPOSITION PLAN	
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C211	GRADING DETAILS
C300	STANDARD URBAN STORM WATER MITIGATION PLAN
C301	STANDARD URBAN STORM WATER MITIGATION DETAILS
C400	UTILITY PLAN

TY001

TY101 TY001 TY002

TY100 TY101 TY102 TY103 TY104

GENERAL SHEET

SYMBOLS
DEVICE PLACEMENT PLAN ACS
GENERAL SHEET
SYMBOLS
DEVICE PLACEMENT PLAN ACS

DEVICE PLACEMENT PLAN ACS DEVICE PLACEMENT PLAN CCTV DEVICE PLACEMENT PLAN IDS DEVICE PLACEMENT PLAN ADS

PROJECT INFO / LEGAL DESCRIPTION

ADDRESS: 3800 S SEPULVEDA BLVD. CULVER CITY, CA 90230-4606 PROPOSED BUILDING AREA: 3,824 sq ft LOT / PARCEL AREA: 13,001 sq ft ASSESSOR PARCEL NO. (APN): 4213-018-014

CONSTRUCTION TYPE: TYPE V-B WITH AUTOMATIC SPRINKLER SYSTEM

STORIES: 1 STORIES

BUILDING HEIGHT: 32'-3" (AT HIGHEST)

OCCUPANCY: B

LEGAL DESCRIPTION:
REAL PROPERTY IN THE CITY OF CULVER CITY, COUNTY OF LOS ANGELES, STATE OF CALIFORNIA, DESCRIBED AS FOLLOW: THAT PORTION OF LOT 15 AS SHOWN ON MAP OF THE 120.71 ACRE TRACT, BELONGING TO THE ESTATE OF PEDRO TALAMANTES, DECEASED, IN THE RANCHO LA BALLONA, IN THE CITY OF CULVER CITY, COUNTY OF LOS ANGELES, STATE OF CALIFORNIA, FILED IN CASE NO. 7078 OF THE SUPERIOR COURT, DESCRIBED AS FOLLOWS:

BEGINNING AT THE POINT OF INTERSECTION OF THE SOUTHWESTERLY LINE OF SAID LOT 15, WITH THE SOUTHEASTERLY LINE OF THE THIRTY (30) FOOT STRIP CONVEYED TO THE COUNTY OF LOS ANGELES BY DEED RECORDED IN BOOK 4224, PAGE 208 OF DEEDS, RECORDS OF SAID COUNTY: THENCE SOUTH 33 DEG 13' EAST ALONG SAID SOUTHWESTERLY LINE, A DISTANCE OF ONE HUNDRED THIRTY FEET: THENCE NORTH 55DEG 48'30" EAST, PARALLEL WITH THE SOUTHEASTERLY LINE OF 30 FOOR STRIP CONVEYED TO SAID COUNTY OF LOS ANGELES BY DEED HEREINBEFORE REFERRED TO, A DISTANCE OF ONE HUNDRED FIFTY FEET: THENCE NORTH 33DEG 13' WEST PARALLEL WITH THE SOUTHWESTERLY LINE OF SAID LOT 15, A DISTANCE OF ONE HUNDRED THIRTY FEET TO A POINT IN THE SOUTHEASTERLY LINE OF SAID 30 FOOT STRIP; THENCE SOUTH 55 DEG 48' 30" WEST ALONG SAID SOUTHEASTERLY LINE ONE HUNDRED

EXCEPTING THEREFROM THE SOUTHWESTERLY FIFTY FEET THEREOF INCLUDED WITHIN THE LINE OF SEPULVEDA BOULEVARD.

APPLICABLE CODES: 2019 LABC, LAGBC, 2019 CBC, CMC, CPC, CEC, CEnC, CFC, CEBC, CRSC, UFAS, ADA TITLE 111

PARKING SUMMARY

PARKING:
GENERAL RETAIL STORES / CANNABIS DISPENSARY, RETAIL STOREFRONT AND ANCILLARY DELIVERY SERVICE:

PARKING STALL PER 350 SF.

PER TABLE 3-3B, SECTION 17.320.020, CULVER CITY MUNICIPAL CODE.

PROVIDED TOTAL: 11 PARKING STALLS: 3 REGULAR PARKING STALLS + 2 COMPACT + 2 EV CAPABLE + 1 EV READY + 1 EV FULL + 2 ADA PARKING STALLS
TOTAL PROVIDED PARKING: 11 PARKING STALLS

NOTE:STANDARD PARKING STALL WITH A "LOADING AREA" SIGN PER CODE EXCEPTION 17.320.050, WITH SIGNAGE AS STATED IN THE CODE, THAT LIMITS THE LOADING PERIOD TO 1/2 HOUR


ATTACHMENT NO. 4



VICINITY MAP



PLOT PLAN

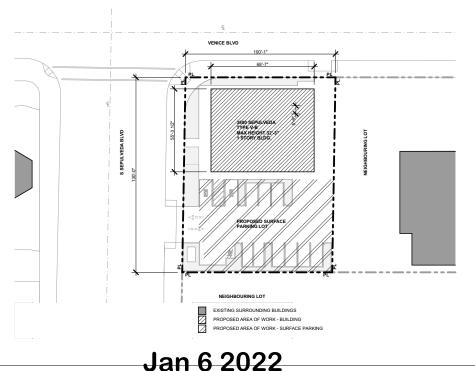

TIVITY IITECTS



3800 SEPULVEDA BLVD. CULVER CITY, CA 90230

SHEET TILE JOB NO. SCALE

SHEET

A000

TOTAL PROVIDED BICYCLE PARKING: 2 SPACES REQUIRED BICYCLE PARKING: 1 SPACE (5% REQ'D VEHICLE PARKING)

DRAWN BY JOB NO. SCALE

SHEET A001











SHEET

A002

ZONING ANALYSIS

4213.018-014

ZONING

CG, COMMERCIAL GENERAL

LAND USE

GENERAL CORRIDOR

SITE AREA

13,001 sf = 0.2977 ACRES

SITE UTILIZATION

CURRENT USE - VACANT LAND PROPOSED USE - BUSINES, CANNABIS DISPENSARY

SITE FALLS WITHIN ZERO SETBACK OVERLAY ZONE, CZ. PER CCMC 17.260.020B PROPERTY ADJACENT TO SEPULVEDA BLVD. *APPROVED MOD.

ZONING MAX HEIGHT

CG - 56'-0" PER CHAPTER 17 CCMC, 17.220.035

CBC MAX HEIGHT

TYPE V-B (S) 60', 3 STORIES

PROPOSED HEIGHT

32'-3" @ THE HIGHEST POINT

MAX ALLOWABLE BLDG AREA

TYPE V-B, 36,000 sf.

PERMEABLE SURFACES

NOT LESS THAN 20% OF (N) PARKING, WALKING OR PATIO SURFACES SHALL BE PERMEABLE. PER CCMC 15.02.1120 & CGBC 4.106.3.1

- THE PRIMARY DRIVEWAY, PRIMARY ENTRY WALKWAY AND ENTRY PORCH OR LANDING SHALL NOT BE INCLUDED WHEN CALCULATING THE AREA REQUIRED TO BE A PERMEABLE SURFACE.

- REQUIRED ACCESSIBLE ROUTES FOR PERSONS WITH DISABILITIES AS REQUIRED BY CALIFORNIA CODE OF REGULATIONS, TITLE 24, PART 2, CHAPTER 11A AND/OR CHAPTER 11B AS APPLICABLE.

REQUIRED TREES

1 TREE ALONG SEPULVEDA & 1 ALONG VENICE ACCORDING TO THE URBAN FOREST MASTER PLAN.

BUILDING STATISTICS

CONSTRUCTION TYPE

OCCUPANCY

CANNABIS DISPENSARY - B

PARKING - S2

FIRE RESISTANCE RATING FOR BUILDING ELEMENTS (CBC TABLE 601) TYPE V-B CONSTRUCTION

BUILDING ELEMENT STRUCTURAL FRAME RATING IN HOURS EXTERIOR BEARING WALLS

INTERIOR BEARING WALLS
EXTERIOR NON-BEARING WALLS (TABLE 602) INTERIOR NON-BEARING WALLS

FLOOR CONSTRUCTION ROOF CONSTRUCTION

CORRIDOR FIRE RESISTANCE RATING (CBC TABLE 1020.1)

OCCUPANT LOAD SERVED BY <u>CORRIDOR</u> IS LESS THAN 30 1HR REQUIRED FIRE RESISTANCE RATING

OCCUPANCY & LOAD

OCCUPANCY & OCCUPANT LOAD SCHEDULE					
ZONE NAME	# occ	LOAD FACTOR	AREA		
BOH CORRIDOR 01	2	150.00	155		
BOH CORRIDOR 02	2	150.00	176		
BREAK ROOM	8	150.00	116		
DELIVERY	1	300.00	236		
EXPRESS SALES	1	150.00	124		
IT ROOM	1	300.00	73		
LOBBY/LOUNGE	4	150.00	471		
OFFICE	1	150.00	111		
PROCESSING	1	300.00	71		
RESTROOM 01	1	150.00	52		
RESTROOM 02	1	150.00	55		
SALES FLOOR	8	150.00	1,162		
SECURITY VESTIBULE	1	150.00	54		
STORAGE	1	300.00	100		
STORAGE/ INVENTORY VAULT	2	300.00	564		

PARKING CALCULATION

NOTE: STANDARD PARKING STALL WITH A "LOADING AREA" SIGN PER CODE EXCEPTION 17.320.050, WITH SIGNAGE AS STATED IN THE CODE, THAT LIMITS THE LOADING PERIOD TO 1/2 HOUR

REQUIRED PARKING SPACES PER AREA	TOTAL BUILDING AREA	TOTAL REQUIRED PARKING	TOTAL PROVIDED PARKING
1 PER 350 SF	3824 SF	11 SPACES	11 SPACES + 1 LOADING ZONE

	PARKING BREAKDO	WN	
SPACE	% OR # REQUIRED	# PROVIDED	TOTAL
COMPACT	UP TO 25%	2	
ACCESSIBLE	1	2	
EV CAPABLE	20%	2	
EV READY	10%	1	
EV FULL	10%	1	
STANDARD	REMAINING REQ'D SPACES	3	11
LOADING	1 FOR 8' MAX DOOR OPENING	SHARED WITH STD	0
BIKE	EQ TO 5% REQ'D VEHICLE PARKING (1)	2	2


PLUMBING LOAD (PER TABLE CPC 2019 422.1)						
OCCUPANCY B LOAD FACTOR 200 (TABLE A) AREA 3824 SF					١	
OCCUPANCY LOAD = 10 MALES/ 10 FEMALES					3	
	WATER CLOSE		Т	URINALS	LAVATORY	
	MALE FE		M.	MALE	MALE	FEM.
REQ'D	1		1	1	1	1
PROV'D 2 1 2					2	
CPC 422.2 SEPERATE FACILITIES						

IN BUSINESS AND MERCANTILE OCCUPANCIES WITH A TOTAL OCCUPANT LOAD OF 50 OR LESS INCLUDING CUSTOMERS AND EMPLOYEES, ONE TOILET FACILITY, DESIGNED FOR USE BY NO MORE THAN ONE PERSON AT A TIME, SHALL BE PERMITTED FOR USE BY BOTH SEXES

ONE DRINKING FOUNTAIN AND SERVICE SINK ARE REQUIRED AND PROVIDED.

ZONING, SETBACK & FIRE ACCESS PLAN

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ZONING LEGEND

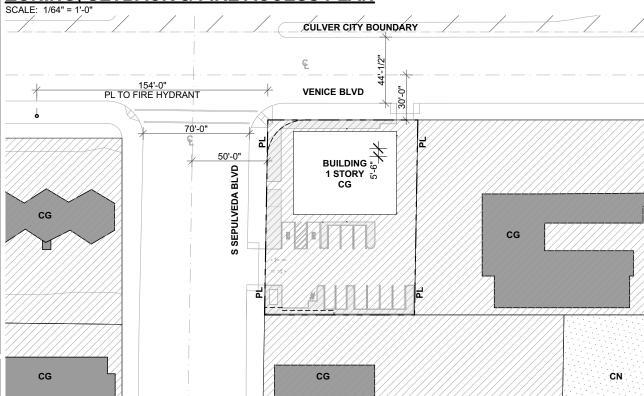CG - COMMERCIAL GENERAL

CN - COMMERCIAL NEIGHBOURHOOD

SURFACE CALCULATION (PER CULVER CITY MUNICIPAL CODE 15.02.1120 **SURFACE CALC REFERENCE PLAN** CGBC 4.106.3.1 & 5.106.3)

_	SURFACE	AREA PROVIDED	% PROVIDED	% REQUIRED
	PERMEABLE	1326 sf	55.4%	20% MIN
	IMPERMEABLE	1068 sf	44.6%	80% MAX
	TOTAL	2394 sf	100%	100%
		•		•

EXEMPT	4688 sf	-	-
LANDSCAPE	1771 sf	-	-

SURFACE LEGEND

PERMEABLE SURFACE

IMPERMEABLE SURFACE

LANDSCAPE

PRIMARY DRIVEWAY (EXEMPT)

PRIMARY ENTRY WALKWAY / PATIO (EXEMPT)

ACCESSIBLE ROUTE (EXEMPT)

BUILDING FOOTPRINT

Jan 6 2022


3800 SEPULVEDA BLVD. CULVER CITY, CA 90230

BEYOND / HELLO

JOB NO. SCALE


SHEET

A003

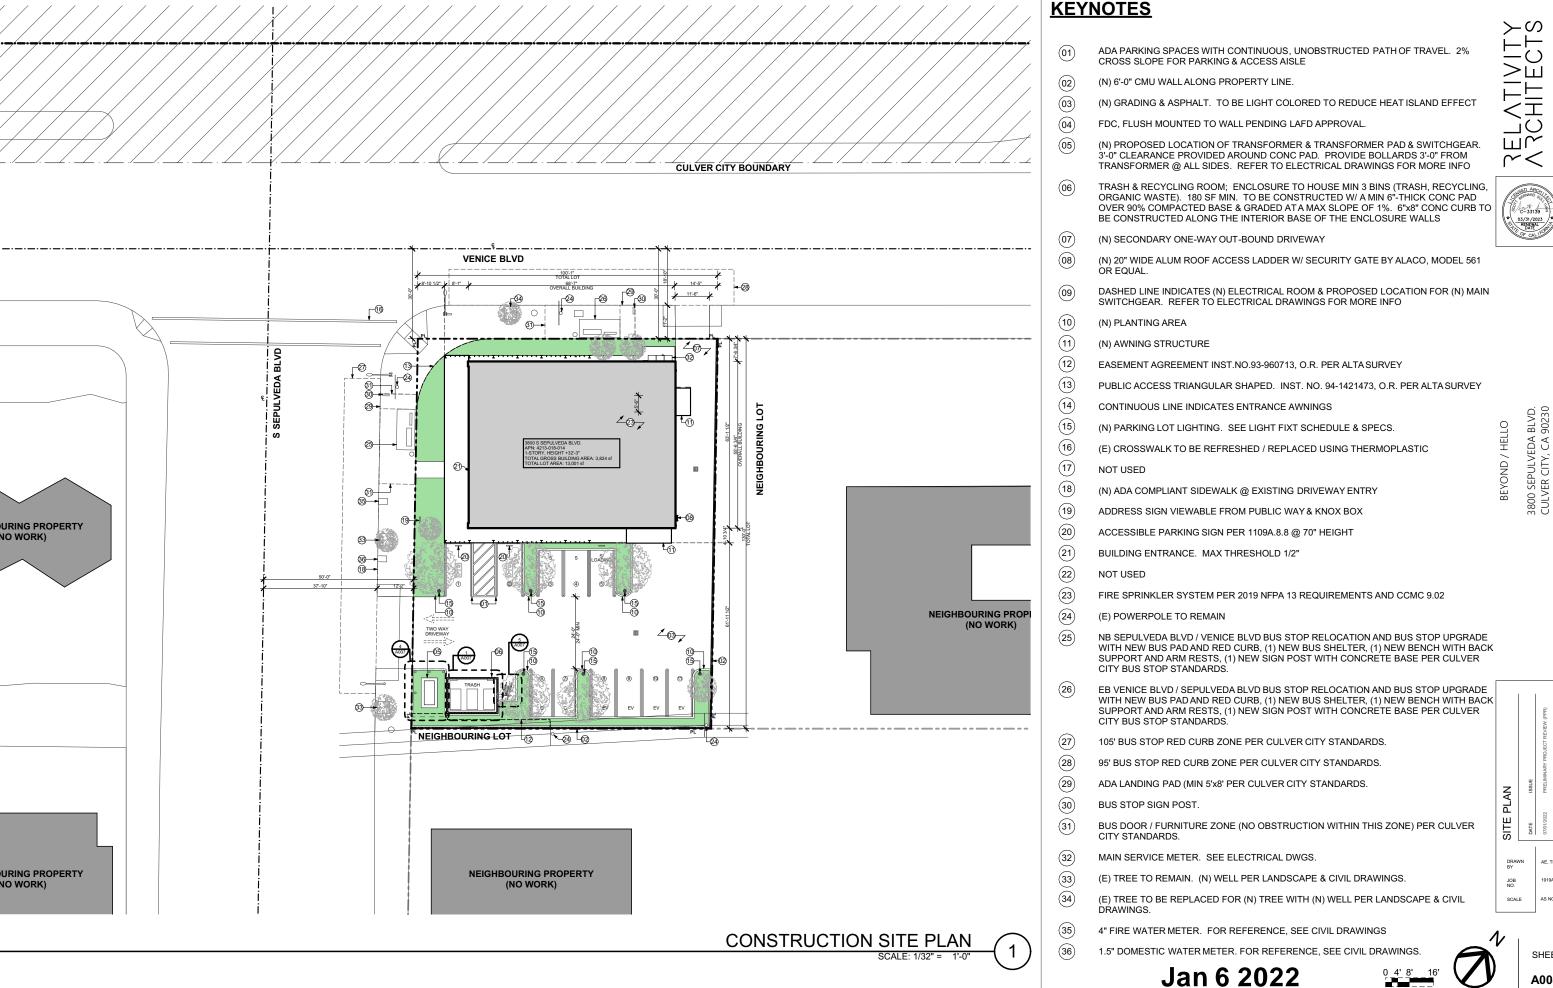

A004

SHEET

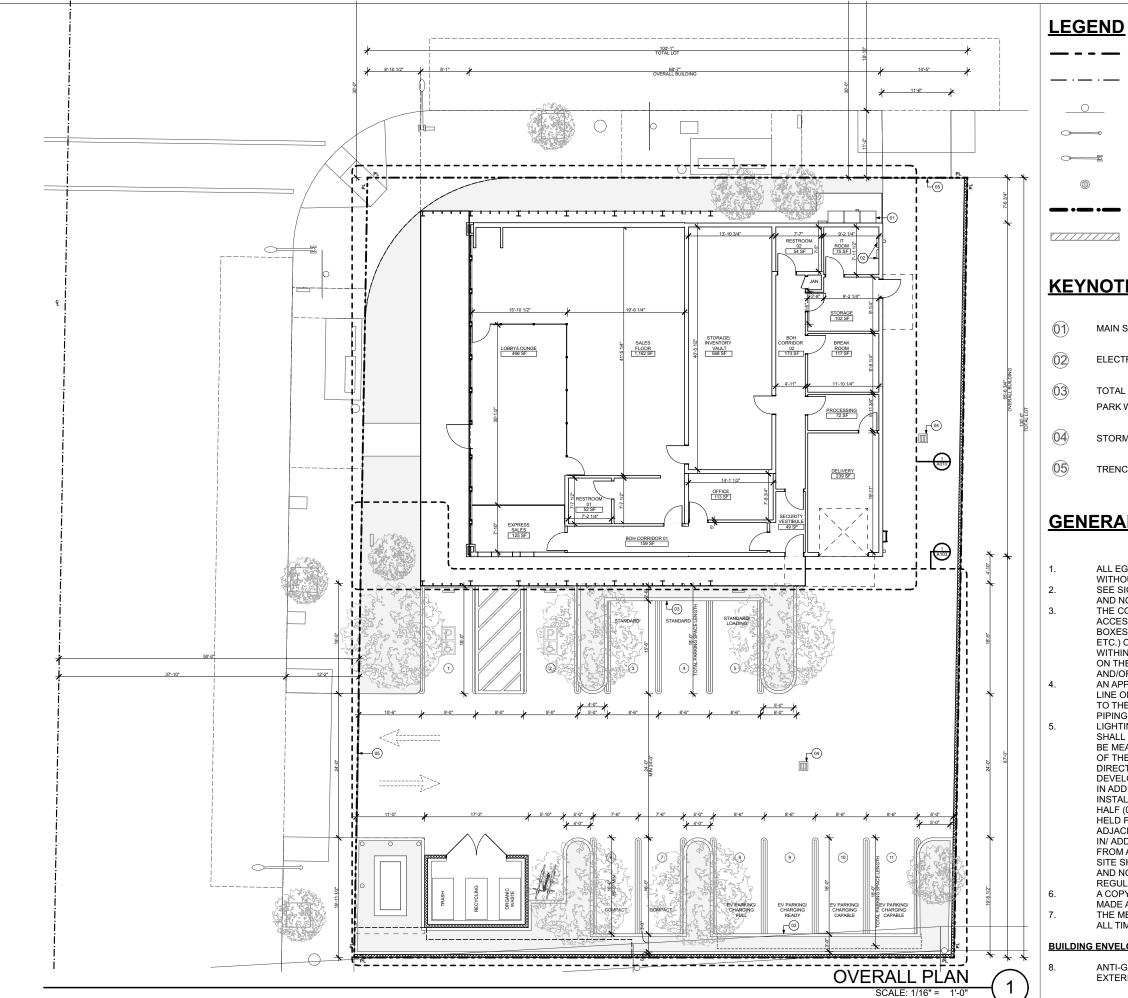

PROPERTY LINE

RIGHT OF WAY CENTERLINE

(E) POWER POLE

(E) STREET LIGHT

(E) STREET LIGHT / TRAFFIC LIGHT

PARKING LIGHT POST

1HR FIRE RATED WALL

SHEAR WALL

KEYNOTES

- MAIN SERVICE METER. SEE ELECTRICAL DWGS.
- ELECTRICAL SUBPANELS. SEE ELECTRICAL DWGS.
- TOTAL PARKING LENGTH FOR STANDARD STALLS IS 18'-0". CARS ARE INTENDED TO PARK WITH 2'-0" LANDSCAPED BUMPER OVERHANG PER CCMC REQUIREMENTS.
- STORM DRAIN INLET. SURFACE DRAIN. REFER TO CIVIL FOR ADDITIONAL INFO.
- TRENCH DRAIN WITH TRAFFIC RATED GRATE. REFER TO CIVIL FOR ADDITIONAL INFO

GENERAL NOTES

- ALL EGRESS DOORS SHOULD BE READILY OPERABLE FROM THE EGRESS SIDE WITHOUT THE USE OF A KEY OR SPECIAL KNOWLEDGE OF EFFORT.
- SEE SIGNAGE SHEETS FOR ACCESSIBLE SIGNAGE REQUIREMENTS, LOCATION
- THE CONSTRUCTION SHALL NOT RESTRICT A FIVE-FOOT CLEAR AND UNOBSTRUCTED ACCESS TO ANY WATER OR POWER DISTRIBUTION FACILITIES (POWER POLES, PULL BOXES, TRANSFORMERS, VAULTS, PUMPS, VALVES, METERS, APPURTENANCES, ETC.) OR TO THE LOCATION OF THE HOOK UP. THE CONSTRUCTION SHALL NOT BE WITHIN TEN FEET OF ANY POWER LINE - WHETHER OR NOT THE LINES ARE LOCATED ON THE PROPERTY. FAILURE TO COMPLY MAY CAUSE CONSTRUCTION DELAYS AND/OR ADDITIONAL EXPENSES.
- AN APPROVED SEISMIC GAS SHUTOFF VALVE WILL BE INSTALLED ON THE FUEL GAS LINE ON THE DOWNSTREAM SIDE OF THE UTILITY METER AND BE RIGIDLY CONNECTED TO THE EXTERIOR OF THE BUILDING OR STRUCTURE CONTAINING THE FUEL GAS PIPING. SEPERATE PLUMBING PERMIT REQ.
 - LIGHTING FOR UNCOVERED PARKING AREAS, VEHICLE ACCESSWAYS AND WALKWAYS SHALL NOT EXCEED A HEIGHT OF SIXTEEN (16) FEET. SUCH OVERALL HEIGHT SHALL BE MEASURED FROM THE PAVED PARKING AREA SURFACE TO THE UPPERMOST PART OF THE LIGHT STANDARD, INCLUDING THE LIGHT GLOBE. LIGHTING SHALL BE DIRECTED ONTO THE DRIVEWAYS, WALKWAYS AND PARKING AREAS WITHIN THE DEVELOPMENT AND AWAY FROM ADJACENT PROPERTIES AND PUBLIC RIGHT OF WAY. IN ADDITION, PARKING STRUCTURE ROOFTOP LIGHTING SHALL BE DESIGNED AND INSTALLED TO PRECLUDE LIGHT TRESPASS (LIGHTING INTENSITY EXCEEDING ONE-HALF (0.5) FOOT CANDLE MEASURED AT THE PROPERTY LINE UTILIZING A LIGHT METER HELD FOUR (4) FEET ABOVE GROUND LEVEL DIRECTED AT THE LIGHT SOURCE ONTO ADJACENT PROPERTY. FOR ADDITIONAL PARKING STRUCTURE LIGHTING STANDARDS IN/ ADDITIONALLY, IN THE OVERLAY ZONE, HEADLIGHT GLARE SHALL BE SHEILDED FROM ALL SURROUNDING RESIDENTIAL PROPERTIES. THE LEVEL OF LIGHTING ON THE SITE SHALL COMPLY WITH THE ENERGY EFFICIENCY STANDARDS FOR RESIDENTIAL AND NON-RESIDENTIAL BUILDINGS. TITLE 24, OF THE CALIFORNIA CODE OF REGULATIONS.
- A COPY OF THE EVALUATION REPORT AND/OR CONDITIONS OF THE LISTING SHALL BE MADE AVAILABLE AT THE JOB SITE.
- THE MEANS OF EGRESS. INCLUDING THE EXIT DISCHARGE. SHALL BE ILLUMINATED AT ALL TIMES THE BUILDING SPACE SERVED BY THE MEANS OF EGRESS IS OCCUPIED.


BUILDING ENVELOPE

ANTI-GRAFFITI FINISH PROVED AT THE FIRST 9 FEET, MEASURED PROM GRADE, AT EXTERIOR WALLS AND DOORS. LAMC 91.6306.

3800 SEPULVEDA BLVD. CULVER CITY, CA 90230

SCALE

SHEET A005

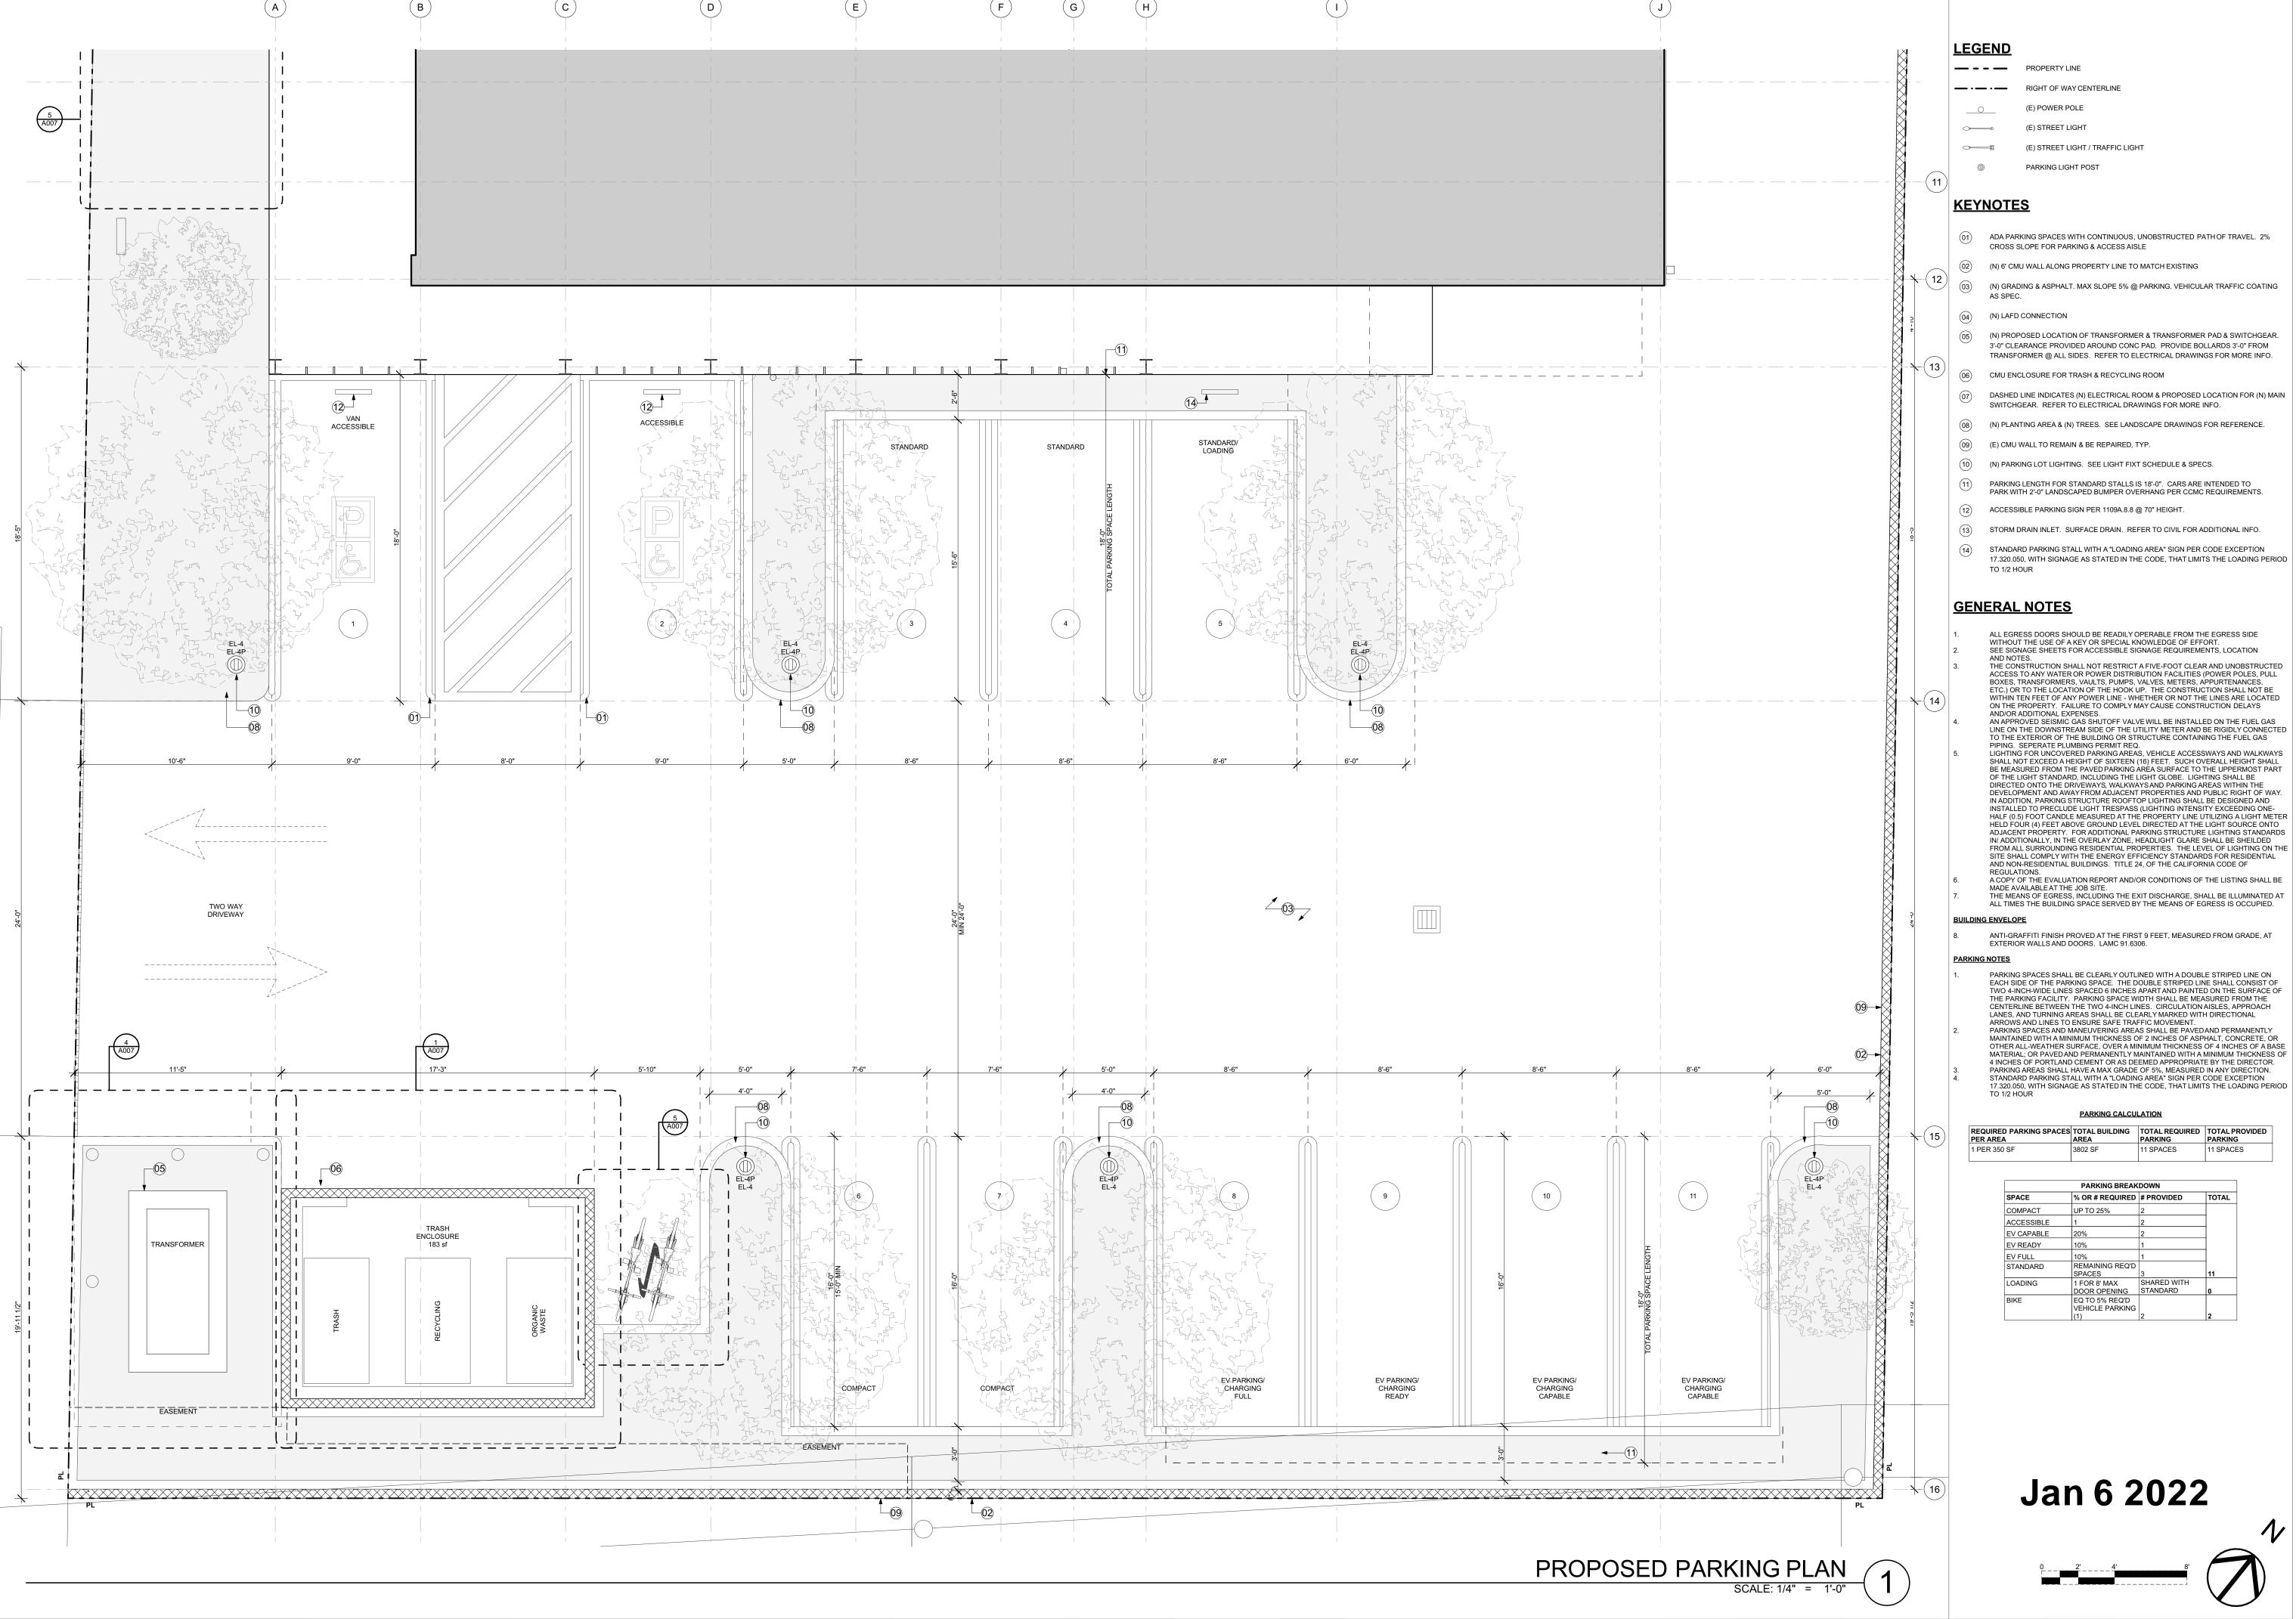



DRAWN

JOB

SCALE

AS NOTED

SHEET

ACHITECTS

CED ARCH CENTRARD SULLE ON C-33139 Z ON RENEWAL DATE

OF CALIFORNIA

PULVEDA BLVD. CULVER CITY, CA

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GENERAL NOTES

ENVIRONMENTAL PROGRAMS AND OPERATIONS NOTES

SOLD WASTE, RECYCLABLE WASTE MATERIAL, AND ORGANIC WASTE HANDLING SHALL BE PERFORMED EXCLUSIVELY BY THE CITY OR ITS AUTHORIZED AGENTS. THE CITY COUNCIL AY REGULATE, BY ORDINANCE OR RESOLUTION, ALL ASPECTS OF SOLID WASTE, RECYCLABLE WASTE MATERIAL, AND ORGANIC WASTE HANDLING, INCLUDING, BUT NOT LIITED TO, FREQUENCY OF COLLECTION, MEANS OF COLLECTION AND TRANSPORTATION, LEVEL OF SERVICES, CHARGES, FEES, AND NATURE, LOCATION, AND EXTENT OF PROVIDING SOLID WASTE HANDLING SERVICES.

THE CITY OF CULVER CITY SHALL PROVIDE WASTE DISPOSAL AND RECYCLING SERVICES FOR ALL CONSTRUCTION & DEMOLITION PROJECTS WITHIN CITY LIITS IN ACCORDANCE WITH CCMC 5.01.010



3800 SEPULVEDA BLVD. CULVER CITY, CA 90230

BEYOND / HELLO

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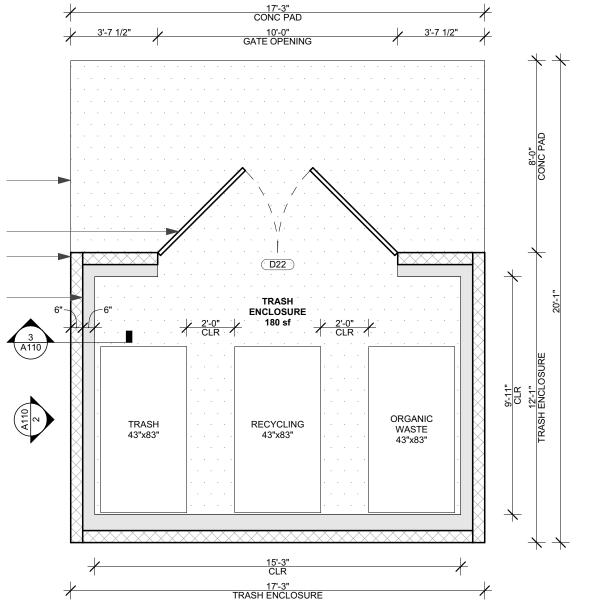
TRASH ENCLOSURE 6'-0" CMU BLOCK WALL @ PERIMETER OF TRASH ENCLOSURE. 6" THICK x8" TALL x 8" LONG CMU BLOCKS, TYP. SEE SHEET C211. CONC CURB @ INTERIOR PERIMETER OF TRASH ENCLOSURE: 6"x8". REFER TO CIVIL DWGS. SEE SHEET C210. CONC PAD; 6" THICK CONC OVER 90% COMPACTED BASE. GRADED AT 1% MAX SLOPE. REFER TO CIVIL DWGS.

HATCH INDICATES CONC PAD. 6" THICK CONC OVER 90% COMPACTED BASE. GRADED AT 1% MAX SLOPE. CONC PAD MUST EXTEND 8'-0" MIN IN FRONT OF ENCLOSURE AND MAINTAIN FULL WIDTH OF ENCLOSURE. 10'-0" WIDE (MIN) x 6'-0" HIGH DOUBLE-

LEAF OUT-SWING GATE

TRASH ENCLOSURE (180 sq.ft. MIN); 6'-0" HIGH CMU BLOCK WALLS. SEE SHEET C211. TO BE PAINTED. COLOR TBD.

HATCH INDICATES 6"x8" CONC CURB @ INTERIOR OF TRASH ENCLOSURE



ENLARGED PLAN - TRASH ENCLOSURE

SHEET

DETAIL

SITE

JOB NO. SCALE

A007

ENVIRONMENTAL PROGRAMS AND OPERATIONS NOTES

SOLD WASTE, RECYCLABLE WASTE MATERIAL, AND ORGANIC WASTE HANDLING SHALL BE PERFORMED EXCLUSIVELY BY THE CITY OR ITS AUTHORIZED AGENTS. THE CITY COUNCIL AY REGULATE, BY ORDINANCE OR RESOLUTION, ALL ASPECTS OF SOLID WASTE, RECYCLABLE WASTE MATERIAL, AND ORGANIC WASTE HANDLING, INCLUDING, BUT NOT LIITED TO, FREQUENCY OF COLLECTION, MEANS OF COLLECTION AND TRANSPORTATION, LEVEL OF SERVICES, CHARGES, FEES, AND NATURE, LOCATION, AND EXTENT OF PROVIDING SOLID WASTE HANDLING SERVICES.



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ENLARGED SECTION - BICYCLE RACK T.6" CLR 10 **ENLARGED PLAN - BICYCLE PARKING** 5

5'-5" CONC PAD / 3'-0" 3'-5" 3'-0"
TO BOLLARD TRANSFORMER TO BOLLARD 10'-0" CONC PAD 16'-0" TOTAL (N) BOLLARDS TO BE LOCATED 3'-0" FROM TRANSFORMER TRANSFORMER, SEE CIVIL DWGS. (N) TRANSFORMER PAD, 8' x 10', SEE CIVIL (N) TRANSFORMER; SEE ELECTRICAL (E) EASEMENT **ENLARGED PLAN - TRANSFORMER**

3800 SEPULVEDA BLVD. CULVER CITY, CA 90230 BEYOND / HELLO

SITE DETAILS JOB NO.

SHEET

Jan 6 2022

A007.1

SCALE



CO CALL

BEYOND / HELLO 3800 SEPULVEDA BLVD. CULVER CITY, CA 90230

ASON AND OFF-SITE DETAILS


LOATE ISSUE

DATE ISSUE


10070222 PRELAMINARY PROJECT REVEW (PPR)

SHEET A008

SCALE

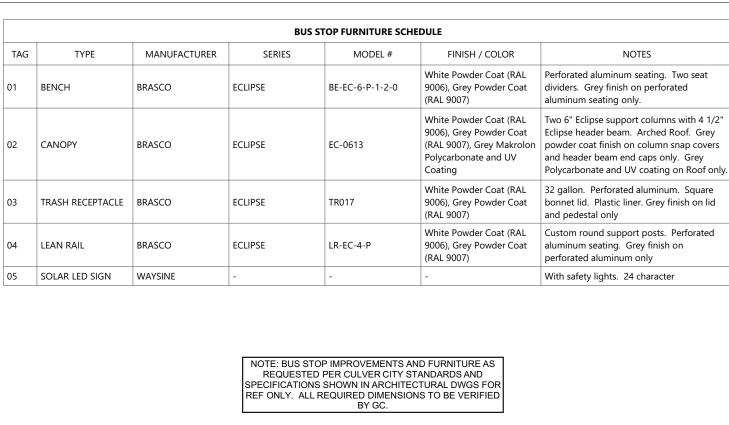

BUS STOP IMPROVEMENT - VENICE BLVD

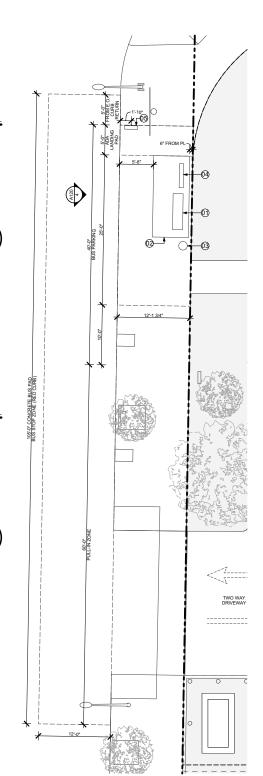

BUS STOP IMPROVEMENT - SEPULVEDA BLVD

3

40'-0" BUS PARKING

ELEVATION: BUS STOP @ SEPULVEDA BLVD

30'-0"
BUS DOOR / FURNITURE ZONE
(NO OBSTRUCTION WITHIN THIS ZONE)

ELEVATION: BUS STOP @ VENICE BLVD

—(2)

Jan 6 2022

3800 SEPULVEDA BLVD. CULVER CITY, CA 90230 BEYOND / HELLO

OFF-SITE DETAILS

SCALE


SHEET A008.1

ELEVATION: OFF-SITE BUS STOP SIGN & POLE
SCALE: 1/2" = 1'-0"

TELESPAR 20F12, PER CULVER CITY REQUIREMENTS. SEE CIVIL DRAWINGS.

CONC FOOTING CAST AGAINST EARTH. POLE CENTERED IN FOOTING. SEE CIVIL DRAWINGS.

SIDEWALK; SEE CIVIL DRAWINGS

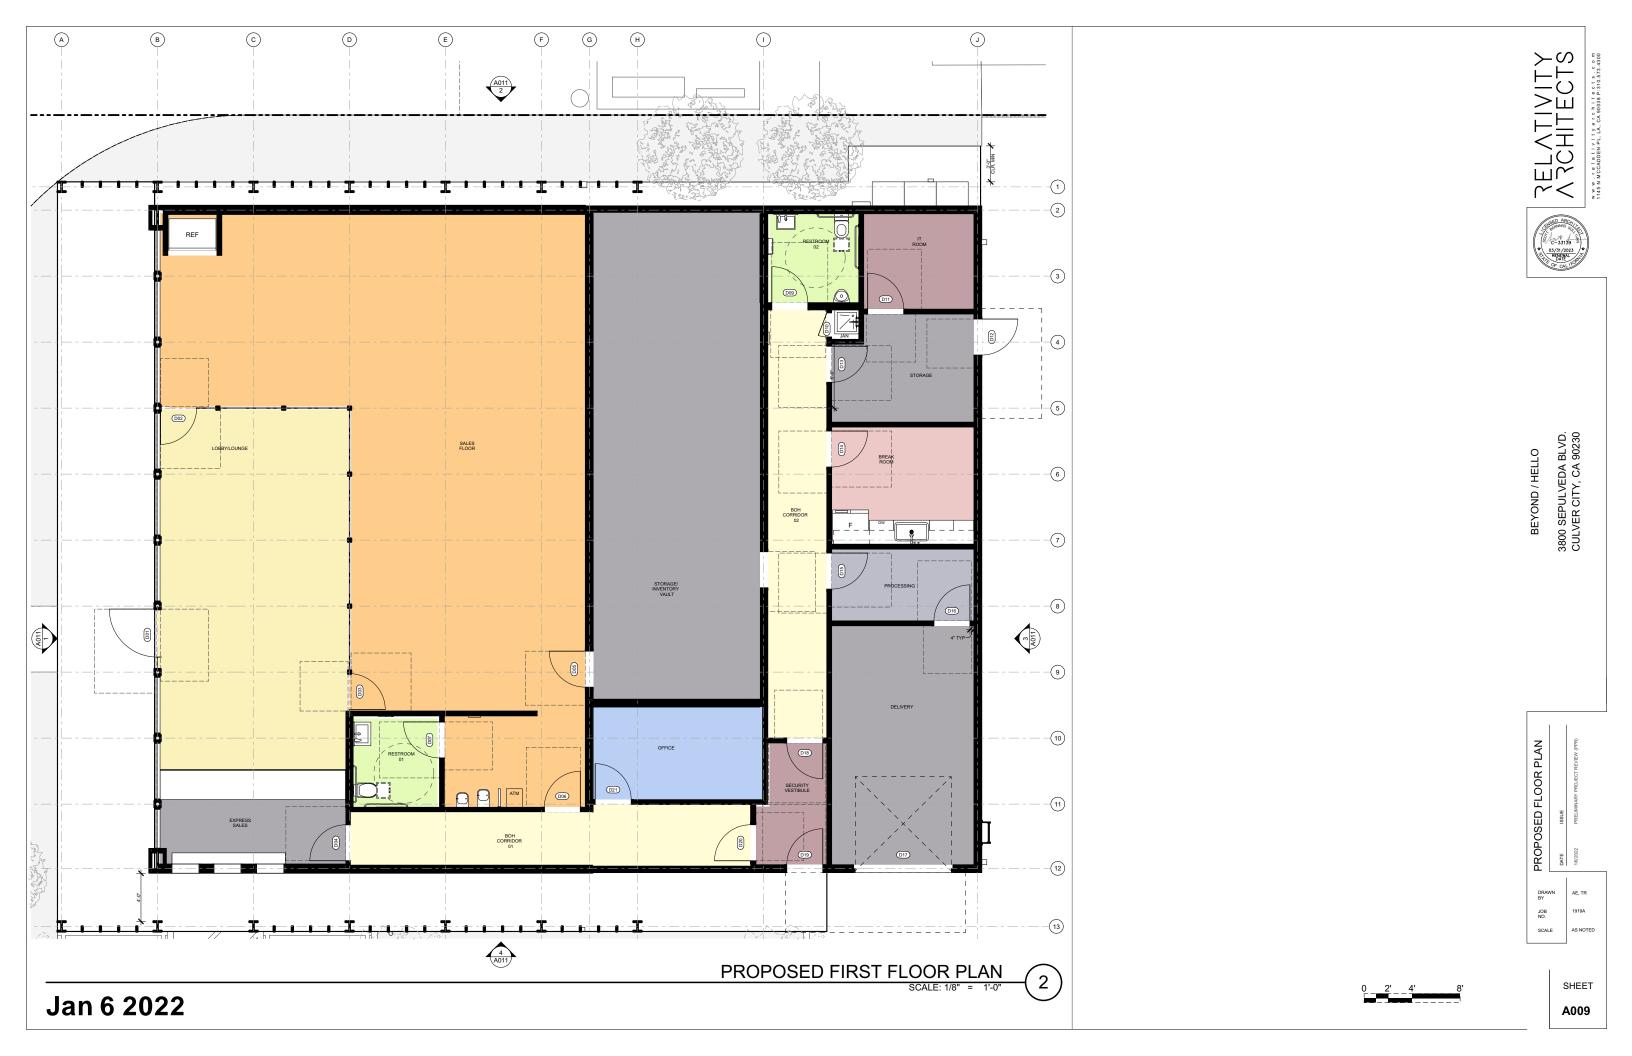

LEGEND

KEYNOTES

- BATHROOM ACCESSORIES, PLUMBING FIXTURES, CABINETS, COUNTERTOPS, GEC OUTLETS, HARD-WIRED EXHAUST FAN W/ HUMIDISTAT AND WIRE. PRIME & PAINT WALLS & CEILING. SEE INTERIOR ELEVATIONS FOR MORE INFORMATION.
- INSTALL FIXTURES WITH HIGH EFFICIENCY LED LIGHTING AT BATHROOM, TYP
- (C3) ELECTRICAL SUBPANELS.
- (C4) NEW DOORS TO COMPLY WITH ACCESSIBLILITY REQUIREMENTS, TYP. SEE DOOR SCHEDULE.
- (C5) PARTITION / WALL, TYP. SEE PARTITION / WALL TYPES.
- (C6) COLUMN, TYP. SEE STRUCTURAL DWGS. SEE LANDSCAPE DWGS FOR VINE TIE ATTACHMENT.
- (C7) PUBLIC ACCESS TRIANGULAR SHAPED. INST. NO. 94-1421473, O.R. PER ALTA SURVEY
- DEPARTMENT ACCESS. KEYS FOR REQUIRED ACCESS SHALL BE PROVIDED BY THE OWNER AND MADE READILY AVAILABLE IN THE KNOX BOX.
- DRINKING FOUNTAIN, DETAILS TBD
- MOSS WALL, DETAILS TBD.
- MAIN SERVICE METER. SEE ELECTRICAL DWGS.
- (C12) CANNABIS DISPOSAL BINS.
- AWNING ABOVE. SEE DETAILS ON A111
- ARCADIA AR450 GLAZING SYSTEM W/ HSS PER STRUCTURAL DWGS.
- DOWNSPOUT. SEE ROOF PLAN.

GENERAL NOTES

- INTERIOR FINISH MATERIALS APPLIED TO WALL AND CEILINGS SHALL BE TESTED AS
- INTERIOR FINISH MATERIALS APPLIED TO WALLAND CEILINGS SHALL BE TESTED AS SPECIFIED IN SECTION 803 AND SHOULD COMPLY WITH TABLE 803.1.1 AND SECTION 803.1. FOR FLAME SPREAD PROVISIONS SEE TABLE 803.9. ALL EGRESS DOORS SHALL BE READLY OPENABLE FROM THE EGRESS SIDE. SEE A005 FOR ACCESSIBLE SIGNAGE REQUIREMENTS, LOCATION AND NOTES. THE CONSTRUCTION SHALL NOT RESTRICT A FIVE-FOOT CLEAR AND UNOBSTRUCTED ACCESS TO ANY WATER OR POWER DISTRIBUTION FACILITIES (POWER POLES, PULL BOXES, TRANSFORMERS, VAULTS, PUMPS, VALVES, METERS, APPURTENANCES, ETC) OR TO THE LOCATION OF THE HOOK UP. THE CONSTRUCTION SHALL NOT BE WITHIN TEN FEET OF ANY POWER LINES, WHETHER OR NOT THE LINES ARE LOCATED ON THE PROPERTY. FAILURE TO COMPLY MAY CAUSE CONSTRUCTION DELAYS AND/OR ADDITIONAL EXPENSES.

 AN APPROVED SEISMIC GAS SHUTOFF VALVE WILL BE INSTALLED ON THE FLEL ASS

- AN APPROVED SEISMIC GAS SHUTOFF VALVE WILL BE INSTALLED ON THE FUEL GAS LINE ON THE DOWNSTREAM BIOE OF THE UTILITY METER AND BE RIGIDLY CONNECTED TO THE EXTERIOR OF THE BUILDING OR STRUCTURE CONTAINING THE FUEL GAS PIPING. SEPERATE PLUMBING PERMIT REC.

 PROVIDE ULTRA-LOW FLUSH CLOSETS FOR ALL NEW CONSTRUCTION. EXISTING SHOWER AND TOLIETS MUST BE ADAPTED FOR LOW WATER CONSUMPTION. A COPY OF THE EVALUATION REPORT AND/OR CONDITIONS OF LISTING SHALL BE MADE AVAILABLE AT THE JOB STE.

 THE MEANS OF EGRESS, INCLUDING THE EXIT DISCHARGE, SHALL BE ILLUMINATED AT ALL TIMES THE BUILDING SPACE SERVED BY THE MEANS OF EGRESS IS OCCUPIED. DESKS 34" HIGH KINE KAN DO TOE CLEARANCE.

 TABLES HEIGHT 28" TO 34", WITH KNEE AND TOE CLEARANCE 27" HIGH, 19" MIN TO 25" MAX DEPTH. 9" TOE CLEARANCE. 30" AS CLEAR SPACE FOR FORWARD APPROACH
- TABLES HEIGHT 28" TO 34", WITH KINEE AND TOE CLEARANCE 27" HIGH, 19" MIN TO 25" MAX DEPTH, 9" TOE CLEARANCE. 30"48" CLEAR SPACE FOR FORWARD APPROACH SEATING 11B-902.1" THE CONSTRUCTION SHALL NOT RESTRICT A FIVE-FOOT CLEAR AND UNOBSTRUCTED
- ACESS TO ANY WATER OR POWER DISTRIBUTION FACILITIES (POWER POLES, PULL-BOXES, TRANSFORMERS, VAULTS, PUMPS, VALVES, METERS, APPURTENANCES, ETC.) OR TO THE LOCATION OF THE HOOK-UP. THE CONSTRUCTION SHALL NOT BE WITHIN TEN FEET OF ANY POWER LINES-WHETHER OR NOT THE LINES ARE LOCATED ON THE PROPERTY. FAILURE TO COMPLY MAY CAUSE CONSTRUCTION DELAYS AND/OR
- PROPERTY: FAILURE TO COMPLY MAY CAUSE CONSTRUCTION DELAYS AND/OR ADDITIONAL EXPENSES.

 AN APPROVED SEISMIC GAS SHUTOFF VALVE WILL BE INSTALLED ON THE FUEL GAS.

 INFO ON THE DOWNSTREAM SIDE OF THE UTILITY METER AND BE RIGIDLY CONNECTED TO THE EXTERIOR OF THE BUILDING OR STRUCTURE CONTAINING THE FUEL GAS.

 PIPING, (PER ORDINANCE 170,158) (INCLUDES COMMERCIAL ADDITIONS AND TI WORK OVER \$ 10.000.) SEPERATE PLUMBING PERMIT IS REQUIRED.

 PROVIDE UTFALLOW FLUSH WATER CLOSETS FOR ALL NEW CONSTRUCTION.

 EXISTING SHOWER HEADS AND TOILETS MUST BE ADAPTED FOR LOW WATER CONSIMPTION.
- CONSUMPTION.
 A COPY OF THE EVALUATION REPORT AND/OR CONDITIONS OF LISTING SHALL BE

- CONSOMPTION.

 A COPY OF THE EVALUATION REPORT AND/OR CONDITIONS OF LISTING SHALL BE MADE AVAILABLE AT THE JOB SITE.

 DOUBLE-STRIPING OF STALLS SHALL BE PER SECTION 12.21A.5(1)

 IN BUILDINGS USED FOR OTHER THAN RESIDENTIAL OCCUPANCIES, DRAFT STOPS MUST BE INSTALLED IN WOOD FRAME FLOOR CONSTRUCTION CONTAINING CONCEALED SPACE SUCH DRAFT STOPS MUST BE INSTALLED SO THAT THE AREA OF THE CONCEALED SPACE DOES NOT EXCEED (1000) SOUARE FEET (718.3.3)

 IN BUILDINGS USED FOR OTHER THAN RESIDENTIAL OCCUPANCIES, DRAFT STOPS MUST BE INSTALLED SO THAT THE AREA OF THE CONCEALED SPACE DOES NOT EXCEED (1000) SOUARE FEET (718.3.1)

 FOR THE CONCEALED SPACE DOES NOT EXCEED (1000) SOUARE FEET (718.3.1)

 DRAFT STOPPING MATERIALS MUST NOT BE LIESS THAN 2-INCH GYPSUM BOARD, 38-INCH TYPE 2-M PARTICLE BOARD OR OTHER MATERIALS AUST NOT BE LESS THAN 2-INCH GYPSUM BOARD, 38-INCH TYPE 2-M PARTICLE BOARD OR OTHER MATERIALS APPROVED BY THE BUILDING DEPARTMENT. DRAFT-STOPPING MUST BE ABBOQUATELY SUPPORTED, (718.3.1).

 GENERAL NOTE! PROJECT CONDITION. GIVEN THE PROJECTED TRIPS THE PROPOSED USE IS EXPECTED TO CREATE, A PARKING MANAGEMENT PLAN IS REQUIRED. A COMPREHENSIVE PARKING MANAGEMENT PLAN IS REQUIRED.
- COMPREHENSIVE PARKING MANAGEMENT PLAN NEEDS TO ADDRESS HOW PARKING IMPACTS TO NEARBY USES,EMPLOYEES AND CLIENTS OF THE SURROUNDING BUSINESSES AND EMPLOYEES AND CUSTOMERS OF THE PROJECT SITE, WILL BE BUSINESSES AND EMPLOYEES AND CUSTOMERS OF THE PROJECT SITE, WILL BE ADDRESSED. EVEN IF REQUIRED PARINING IS PROVIDED, VAELTATIENDANT PARKING MAY BE REQUIRED. QUEUING OT STAGING OF VEHICLES DURING RETRIEVAL OR PARKING IS NOT ALLOWED ON THE PUBLIC RIGHT-OF-WAY. THIS INCLUDES TEMPORARILY PARKING CARDS ON PUBLIC STREETS.
 GENERAL NOTE! PROJECT CONDITION: MECHANICAL EQUIPMENT, ELEVATOR SHAFTS AND STAIR WELLS CAN EXCEED THE BUILDING HEIGHT BY A MAXIMUM OF 13.5 FEET. ARCHITECTURAL FEATURES CAN EXCEED THE BUILDING HEIGHT BY A MAXIMUM OF 13.5 FEET AND CANDOT EXCEED 15% OF THE TOTAL ROOF AREA. FURTHER MECHANICAL EQUIPMENT SHALL BE SCREENED.

INTERIOR ENVIRONMENT

EVERY SPACE INTENDED FOR HUMAN OCCUPANCY SHALL BE PROVIDED WITH EVEN I SPACE IN INSURED FOR THE INVENTED FOR THE PROVIDED WITH A THREE PROVIDED WITH A THREE WITH A COORDANG WITH THE SECTION 1205.2 OR SHALL BE PROVIDED WITH ARTIFICIAL LIGHT THAT IS ADEQUATE TO PROVIDE AN AVERAGE ILLUMINATION OF 10 FOOT-CANDLES OVER THE AREA OF THE ROOM AT A HEIGHT OF 30 INCHES ABOVE THE FLOOR LEVEL (1205.1 AND 1205.3).

BUILDING ENVELOPE

ANTI-GRAFFITI FINISH PROVIDED AT THE FIRST 9 FEET, MEASURED FROM GRADE, AT EXTERIOR WALLS AND DOORS. LAMC 91.6306.

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CONSTRUCTION FLOOF PLAN

SCALE

SHEET

A010



BEYOND / HELLO

3800 SEPULVEDA BLVD. CULVER CITY, CA 90230

METALAWNING WITH TIE ROD SUPPORT. FROSTED STOREFRONT GLAZING. BEYOND HELLO SIGNAGE BY OTHERS.

06 EXPOSED STEEL STRUCTURE TO HAVE WHITE POWDER COAT FINISH, TYP.

07 PURLIN, SEE STRUCTURAL DWGS. TO HAVE WHITE POWDER COAT FINISH, TYP.

08 SMOOTH STUCCO FINISH, TYP.

09 CONTROL LINES, TYP.

(01)

02

03

05)

(10) OUTDOOR WALL SCONCE, SEE RCP & LIGHTING SCHEDULE.

20" WIDE ALUMINUM ROOF ACCESS LADDER W/ SECURITY GATE BY ALACO, MODEL 561

(12) STANDING SEAM METAL ROOF W/ SEAMS EVERY 18".

(13) EAVE TRIM. SAME COLOR AS METAL ROOF. LAP OVER GUTTER.

(14) 7" GUTTER. GUTTER BRACKET FASTEN THRU EAVE TRIM 24" O.C. MAX.

(15) PATH LIGHTING, SEE LIGHTING SCHEDULE & ELECTRICAL DWGS.

+32'-3"
ROOF HIGH RIDGE POINT T.O. FLAT ROOF PARAPET +15'-3 1/2" LOW EAVE POINT

@

ELEVATION EAST


+32'-3"
ROOF HIGH RIDGE POINT


+17'-6" T.O. FLAT ROOF PARAPET +15'-3 1/2" LOW EAVE POINT

+24'-2 1/2" HIGH EAVE POINT

+12'-6" B.O. FLAT ROOF

ELEVATION WEST

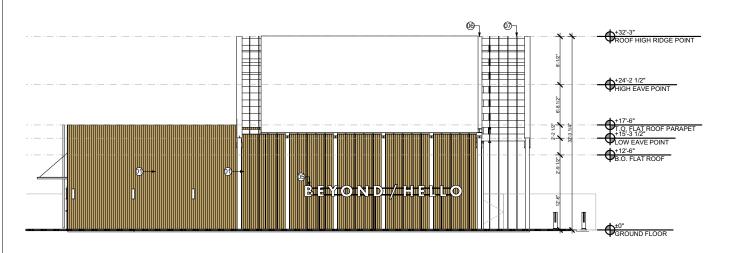

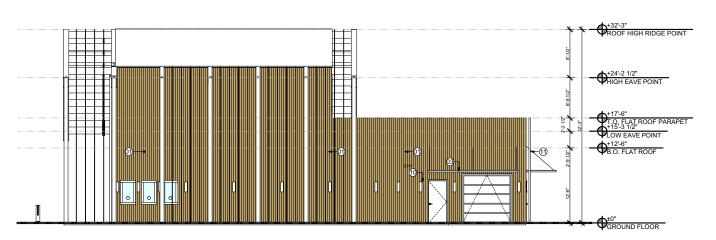

ELEVATION SOUTH

EXTERIOR ELEVATIONS JOB NO. SCALE


SHEET


A011

ELEVATION NORTH

Jan 6 2022

6

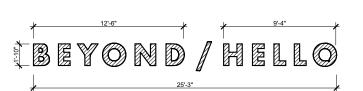

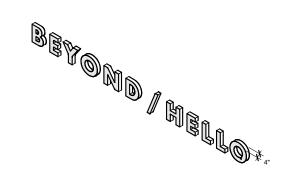




SIGN (3) - ELEVATION

SCALE: 1/8" = 1'-0"

(6)

SIGN (3) - ISOMETRIC


SCALE: 1/8" = 1'-0" 5

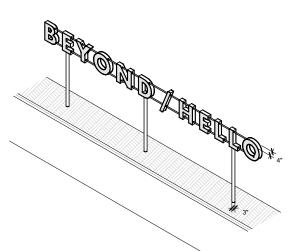

SIGN (2) - ELEVATION

SIGN (2) - ISOMETRIC

SCALE: 1/8" = 1'-0" 3

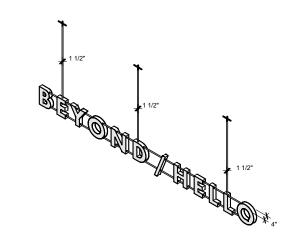

SIGN (1) - ELEVATION
SCALE: 1/8" = 1'-0"

SIGN (1) - ISOMETRIC

SCALE: 1/8" = 1'-0"

1

BEYOND / HELLO 3800 SEPULVEDA BLVD. CULVER CITY, CA 90230

SIGNAGE ELEVATIONS

DATE ISSUE

180/2022 PRELIMINARY PROJECT REVIEW (PPR)

DRAWN AE, TR
BY

JOB 1919A
NO.


SCALE AS NOTED

SHEET **A012**

Jan 6 2022

BEYOND / HELLO LANDSCAPE PLANS

3800 SEPULVEDA BLVD CULVER CITY, CA 90230

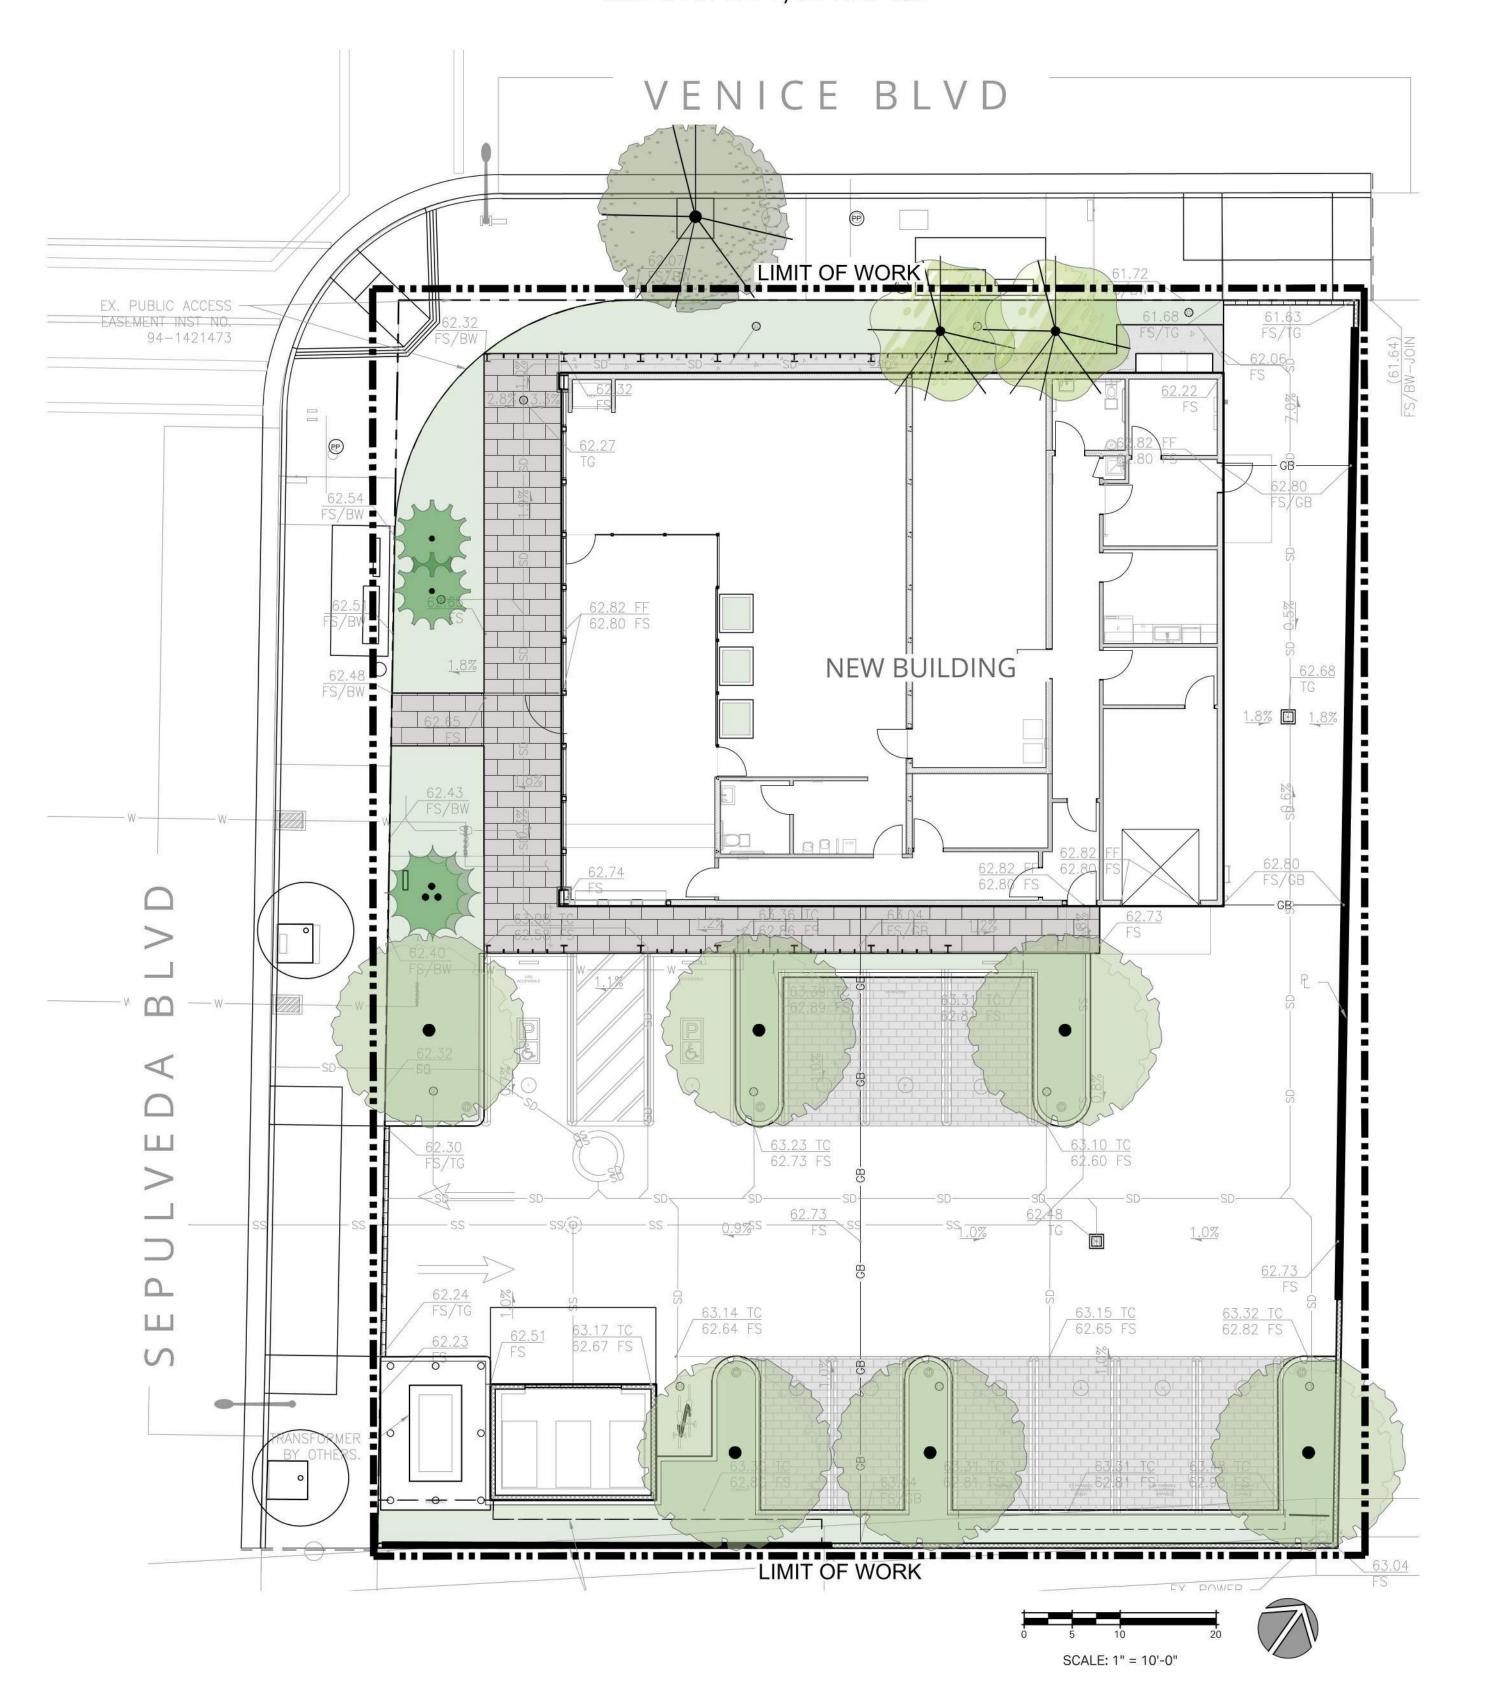

LANDSCAPE SHEET INDEX

SHEET	DESCRIPTION
L-1.0	Title Sheet
L-1.1	Tree Disposition Plan
L-2.0	Construction Notes & Materi
L-2.1	Layout Plan
L-3.0	Planting Notes & Schedule
L-3.1	Planting Plan
L-4.1	Construction Details
L-4.2	Planting Details
LI-1	Irrigation Plan
LI-2	Irrigation Notes & WELO
LI-3	Irrigation Details
LI-4	Irrigation Details

PROJECT CONTACTS

LANDSCAPE ARCHITECT CJM::LA, INC. CONTACT: NICOLE HORN 805.698.2120

nicole@cjm-la.com

ARCHITECT RELATIVITY ARCHITECTS | HC+RA CONTACT: TIMA BELL 310.573.4300 time@relativityarchitects.com

CIVIL ENGINEER
LABIB FUNK + ASSOCIATES (LFA)
CONTACT: KYLE PROUTY 213.239.9700 x119 kyle.prouty@labibfunk.com

SITE STATISTICS

TOTAL ONSITE LANDSCAPE AREA: 1,823 SF QUANTITY OF PROPOSED ONSITE TREES: 11 QUANTITY OF PROPOSED OFFSITE TREES (IN R.O.W.): 1 CJM::LA

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HEE S

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7/29/21 60% CD 8/20/21 80% CD 1/7/22 90% CD

PROJECT NUMBER

DRAWN BY DATE DRAWN 11/21/19 SCALE 1/8"=1'-0" PRINT DATE 1/7/22

SHEET NUMBER L-1.0

TREE ASSESSMENT SUMMARY

TOTAL ONSITE EXISTING TREES

TOTAL ONSITE TREES TO BE REMOVED:

TOTAL ONSITE TREES TO BE PROTECTED IN PLACE:

TOTAL OFFSITE EXISTING TREES

TOTAL OFFSITE TREES TO BE REMOVED: TOTAL OFFSITE TREES TO BE PROTECTED IN PLACE:

TREE PROTECTION GENERAL NOTES

- 1. EXISTING TREES LOCATED ON SITE SHALL BE PROTECTED TO THE MAXIMUM EXTENT FEASIBLE.
- 2. NO GRADING OR DEVELOPMENT SHALL OCCUR WITHIN THE DRIPLINES OF PROTECTED TREES WHICH OCCUR IN THE CONSTRUCTION AREA. THIS INCLUDES TREE CANOPIES WHICH OVERHANG INTO THE LIMIT OF WORK FROM ADJACENT PROPERTIES.
- ALL PROTECTED TREES WITHIN 25 FEET OF PROPOSED GROUND DISTURBANCES SHALL BE TEMPORARILY FENCED WITH CHAIN-LINK OR OTHER MATERIAL SATISFACTORY TO THE CITY OF SANTA BARBARA THROUGHOUT ALL GRADING AND CONSTRUCTION ACTIVITIES. AT A MINIMUM, THE FENCING SHALL BE INSTALLED SIX FEET OUTSIDE THE DRIPLINE OF EACH TREE WHERE FEASIBLE. THE FENCE SHALL BE STAKED EVERY SIX FEET. FENCING SHOWN ON THIS PLAN SHALL TAKE PRECEDENCE OVER THIS MINIMUM.
- 4. NO CONSTRUCTION EQUIPMENT SHALL BE PARKED, STORED, OR OPERATED WITHIN SIX FEET OF PROTECTED TREE DRIPLINES, OR WITHIN THE LIMITS OF THE TREE PROTECTION FENCING.
- 5. NO FILL SOIL, ROCKS, OR CONSTRUCTION MATERIALS SHALL BE STORED OR PLACED WITHIN SIX FEET OF PROTECTED TREE DRIPLINES, OR WITHIN THE LIMITS OF THE TREE PROTECTION FENCING.
- 6. ROOTS ENCOUNTERED THAT ARE ONE INCH IN DIAMETER OR GREATER SHALL BE CLEANLY CUT. THIS SHALL BE DONE UNDER DIRECTION OF THE PROJECT ARBORIST.
- 7. TRENCHING OR OTHER CONSTRUCTION ACTIVITY REQUIRED WITHIN THE DRIPLINE OR SENSITIVE ROOT ZONE OF PROTECTED TREES SHALL BE DONE BY HAND AND UNDER THE SUPERVISION OF THE PROJECT ARBORIST.

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B E Y 0 3800 S Culver



7/29/21 60% CD 8/20/21 80% CD 1/7/22 90% CD

PROJECT NUMBER 1950 DRAWN BY

DATE DRAWN 11/21/19 SCALE 1/8"=1'-0" PRINT DATE

1/7/22 SHEET NUMBER L-1.1

SCALE: **½**" = 1'-0"

REFERENC	CE NOTES SCHEDULE	
	AMENITIES	÷.
SYMBOL	DESCRIPTION	DETAIL
A-01	BIKE RACK MODEL: "LOOP" MFR: LANDSCAPE FORMS LOOP-BR MATERIAL: ALUMINUM CASTING WITH POWDER COAT FINISH COLOR: DUSK SUBMIT COLOR AND FINISH SAMPLE W/ CUT SHEET FOR L.A. APPROVAL PRIOR TO ORDERING	5/L-4.1
	PAVING	
SYMBOL	DESCRIPTION	DETAIL
P-01	PERMEABLE PAVER, VEHICULAR MODEL: 4.5X9 MFR: HANOVER SIZE: 4.5"X9"X3" COLOR: LIMESTONE GRAY, NATURAL FINISH SUBMIT PAVER COLOR & FINISH SAMPLE TO L.A. FOR APPROVAL PRIOR TO ORDERING.	4/L-4.1
P-02	PORCELAIN PAVER, PEDESTRIAN MODEL: ATTACHED DIPLOMACY "XTERIOR" PAVER MFR: DALTILE SIZE: 20"X40"X2CM THICK COLOR: LIGHT GRAY DP01 SUBMIT PAVER COLOR & FINISH SAMPLE TO L.A. FOR APPROVAL PRIOR TO ORDERING. PORCELAIN PAVER IS INTENDED TO MATCH INTERIOR FLOORING SPECIFIED BY ARCHITECT.	3/L-4.1
P-03	CONCRETE PAVING, TYPICAL COLOR: NATURAL GRAY W/ TOPCAST 03 FINISH	1/L-4.1
P-04	DETECTABLE WARNING PAVER MODEL: "TRUNCATED DOMES" MFR: ORCO (714) 527-2239 SIZE: 12"X12"X50MM THICK COLOR: FEDERAL YELLOW SUBMIT PAVER COLOR & FINISH SAMPLE TO L.A. FOR APPROVAL	6/L-4.1

PRIOR TO ORDERING.

CONSTRUCTION GENERAL NOTES

OWNER OR LANDSCAPE ARCHITECT.

- CONSTRUCTION SHALL CONFORM TO ALL LOCAL CITY, COUNTY, STATE AND INTERNATIONAL CODES.
- 2. CONTRACTOR SHALL NOT MAKE FIELD CHANGES UNLESS AUTHORIZED BY THE LANDSCAPE ARCHITECT. ANY UNAUTHORIZED CHANGES SHALL BE CORRECTED TO CONFORM TO THE PLANS, AT NO ADDITIONAL COST TO THE
- 3. CONTRACTOR SHALL VERIFY ALL UTILITY LOCATIONS. CONTRACTOR SHALL NOTIFY LANDSCAPE ARCHITECT IF ANY FIELD CHANGES ARE NECESSARY.
- 4. CONTRACTOR SHALL BE RESPONSIBLE FOR DAMAGE TO UNDERGROUND UTILITIES AND SHALL REPLACE OR REPAIR SAME AS REQUIRED AT HIS EXPENSE.
- 5. CONTRACTOR SHALL COORDINATE ELECTRICAL AND IRRIGATION CONDUIT SLEEVES PRIOR TO INSTALLATION OF NEW PAVEMENT.
- 6. CONTRACTOR TO REVIEW SITE FOR PROPER DRAINAGE AND REPORT APPARENT PROBLEMS TO LANDSCAPE ARCHITECT IMMEDIATELY.
- 7. CONTRACTOR SHALL VERIFY ALL MATERIALS, COLORS AND FINISHES WITH LANDSCAPE ARCHITECT PRIOR TO CONSTRUCTION. CONTRACTOR SHALL OBTAIN SAMPLES OF ALL CONCRETE COLOR & FINISHES, TILE, BRICK, PAVERS, ETC. FOR REVIEW BY LANDSCAPE ARCHITECT PRIOR TO ORDERING.
- 8. LANDSCAPE ARCHITECT SHALL REVIEW ALL FORMING AND SCORE LINE "SNAP LINES" BEFORE CONCRETE IS POURED OR CUT. ALLOW 24 HRS. LEAD TIME.
- 9. CONTRACTOR SHALL STAKE LOCATIONS FOR LAWN HEADERS FOR REVIEW BY THE LANDSCAPE ARCHITECT PRIOR TO CONSTRUCTION.
- 10. CONTRACTOR SHALL NOTIFY LANDSCAPE ARCHITECT OF ANY CONFLICTS BETWEEN TREE BOX SIZE AND HARDSCAPE. FIELD CHANGES SHALL BE MADE EXPRESSLY BY THE LANDSCAPE ARCHITECT.
- 11. CONTRACTOR SHALL PROTECT TREE ROOTS AND TRUNKS FROM COMPACTION AND DAMAGE DURING CONSTRUCTION. TRENCHING ADJACENT TO EXISTING TREE DRIPLINES SHALL BE DONE BY HAND TO AVOID ROOT DAMAGE.
- 12. ALL SCORE JOINTS, SAW CUTS AND EXPANSION JOINTS SHALL BE INSTALLED AS SHOWN ON THE PLANS.
- 13. PAVING SUB-BASE AND REINFORCEMENT SHALL BE PER THE CIVIL DRAWINGS, STRUCTURAL DETAILS, OR GEOTECHNICAL SOILS REPORT.
- 14. REFER TO THE CIVIL ENGINEER'S PLANS FOR DRAIN LOCATIONS AND DETAILS.
- 15. UNLESS OTHERWISE NOTED, DIMENSIONS ARE TO FACE FINISH OF STRUCTURE.

CONSTRUCTION LEGEND

UCTION LEGEND	DIMENSION LEGEND		
Asphaltic Concrete Beginning Curve Radius	•	Point of reference	
Back of Curb	\otimes	Radius = 2'-0"	
Cold Joint	®	Radius = 2'-6"	
Clear/Clearance	0	Radius = 3'-0"	
Concrete	0	Radius = 4'-0"	
Diameter	(E)	Radius = 5'-0"	
Decomposed Granite	(E)	Radius = 6'-0"	
Each End Curve Radius	Ğ	Radius = 18"	
	Beginning Curve Radius Back of Curb Cold Joint Center Line Clear/Clearance Concrete Continuous Diameter Decomposed Granite Each	Asphaltic Concrete Beginning Curve Radius Back of Curb Cold Joint Center Line Clear/Clearance Concrete Continuous Diameter Decomposed Granite Each	

Expansion Joint F.O.B. Face of Building F.O.W. Face of Wall F.O.C. Face of Curb Finish Grade Finish Surface Footing GALV. Galvanized HDR Header Board L.A. Landscape Architect MAX. Maximum MIN. MB Minimum Mail Box NAT. N.I.C. Natural Not In Contract N.T.S. O.C. Not To Scale On Center Planting Area Poured In Place Property Line

Radius **RDWD** Redwood S.A.D. S.A.D. SD See Architect's Drawings See Civil Engineer's Drawings Slot Drain See Interior Designer's Drawings

S.I.D. S.S.D. SHT See Structural Engineer's Drawings Score Line SQ S4S STD Square Surfaced Four Sides Standard

Top of footing Top of wall **TRANS** Transformer TYP. Typical VIF Verify In Field W.I. Wrought Iron

PAVING INSTALLATION NOTES

- 1. INSTALL BRICK, STONE & UNIT PAVERS SUCH THAT FINISH SURFACE OF PAVED AREA IS LEVEL.
- 2. NO INDIVIDUAL PAVERS OR STONES SHALL EXCEED 1/4" HIGH VERTICAL DIFFERENCE BETWEEN ADJACENT PAVERS, BRICKS OR STONES.
- 3. UNIT PAVER AREA SHALL BE FLUSH WITH ALL ADJACENT PAVED SURFACES. CHANGES IN LEVEL AT ALL ADJACENT PAVED SURFACES SHALL NOT EXCEED 1/4" HIGH MAXIMUM.
- 4. CONTRACTOR IS RESPONSIBLE FOR ACHIEVING A LEVEL SURFACE FOR ALL PAVED AREAS IN COMPLIANCE WITH CBC 11B-303.

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office 805 698 2120 email INFO@CJM-LA.COM 1221 STATE STREET SUITE 206 SANTA BARBARA CA 93101

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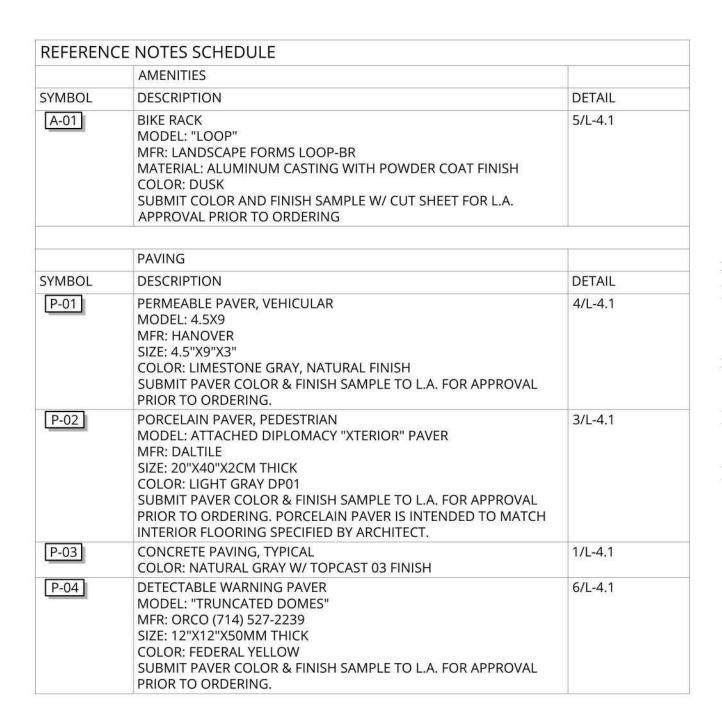
7/29/21 60% CD 8/20/21 80% CD 1/7/22 90% CD


PROJECT NUMBER DRAWN BY

DATE DRAWN 11/21/19 SCALE

PRINT DATE 1/7/22

SHEET NUMBER L-2.0



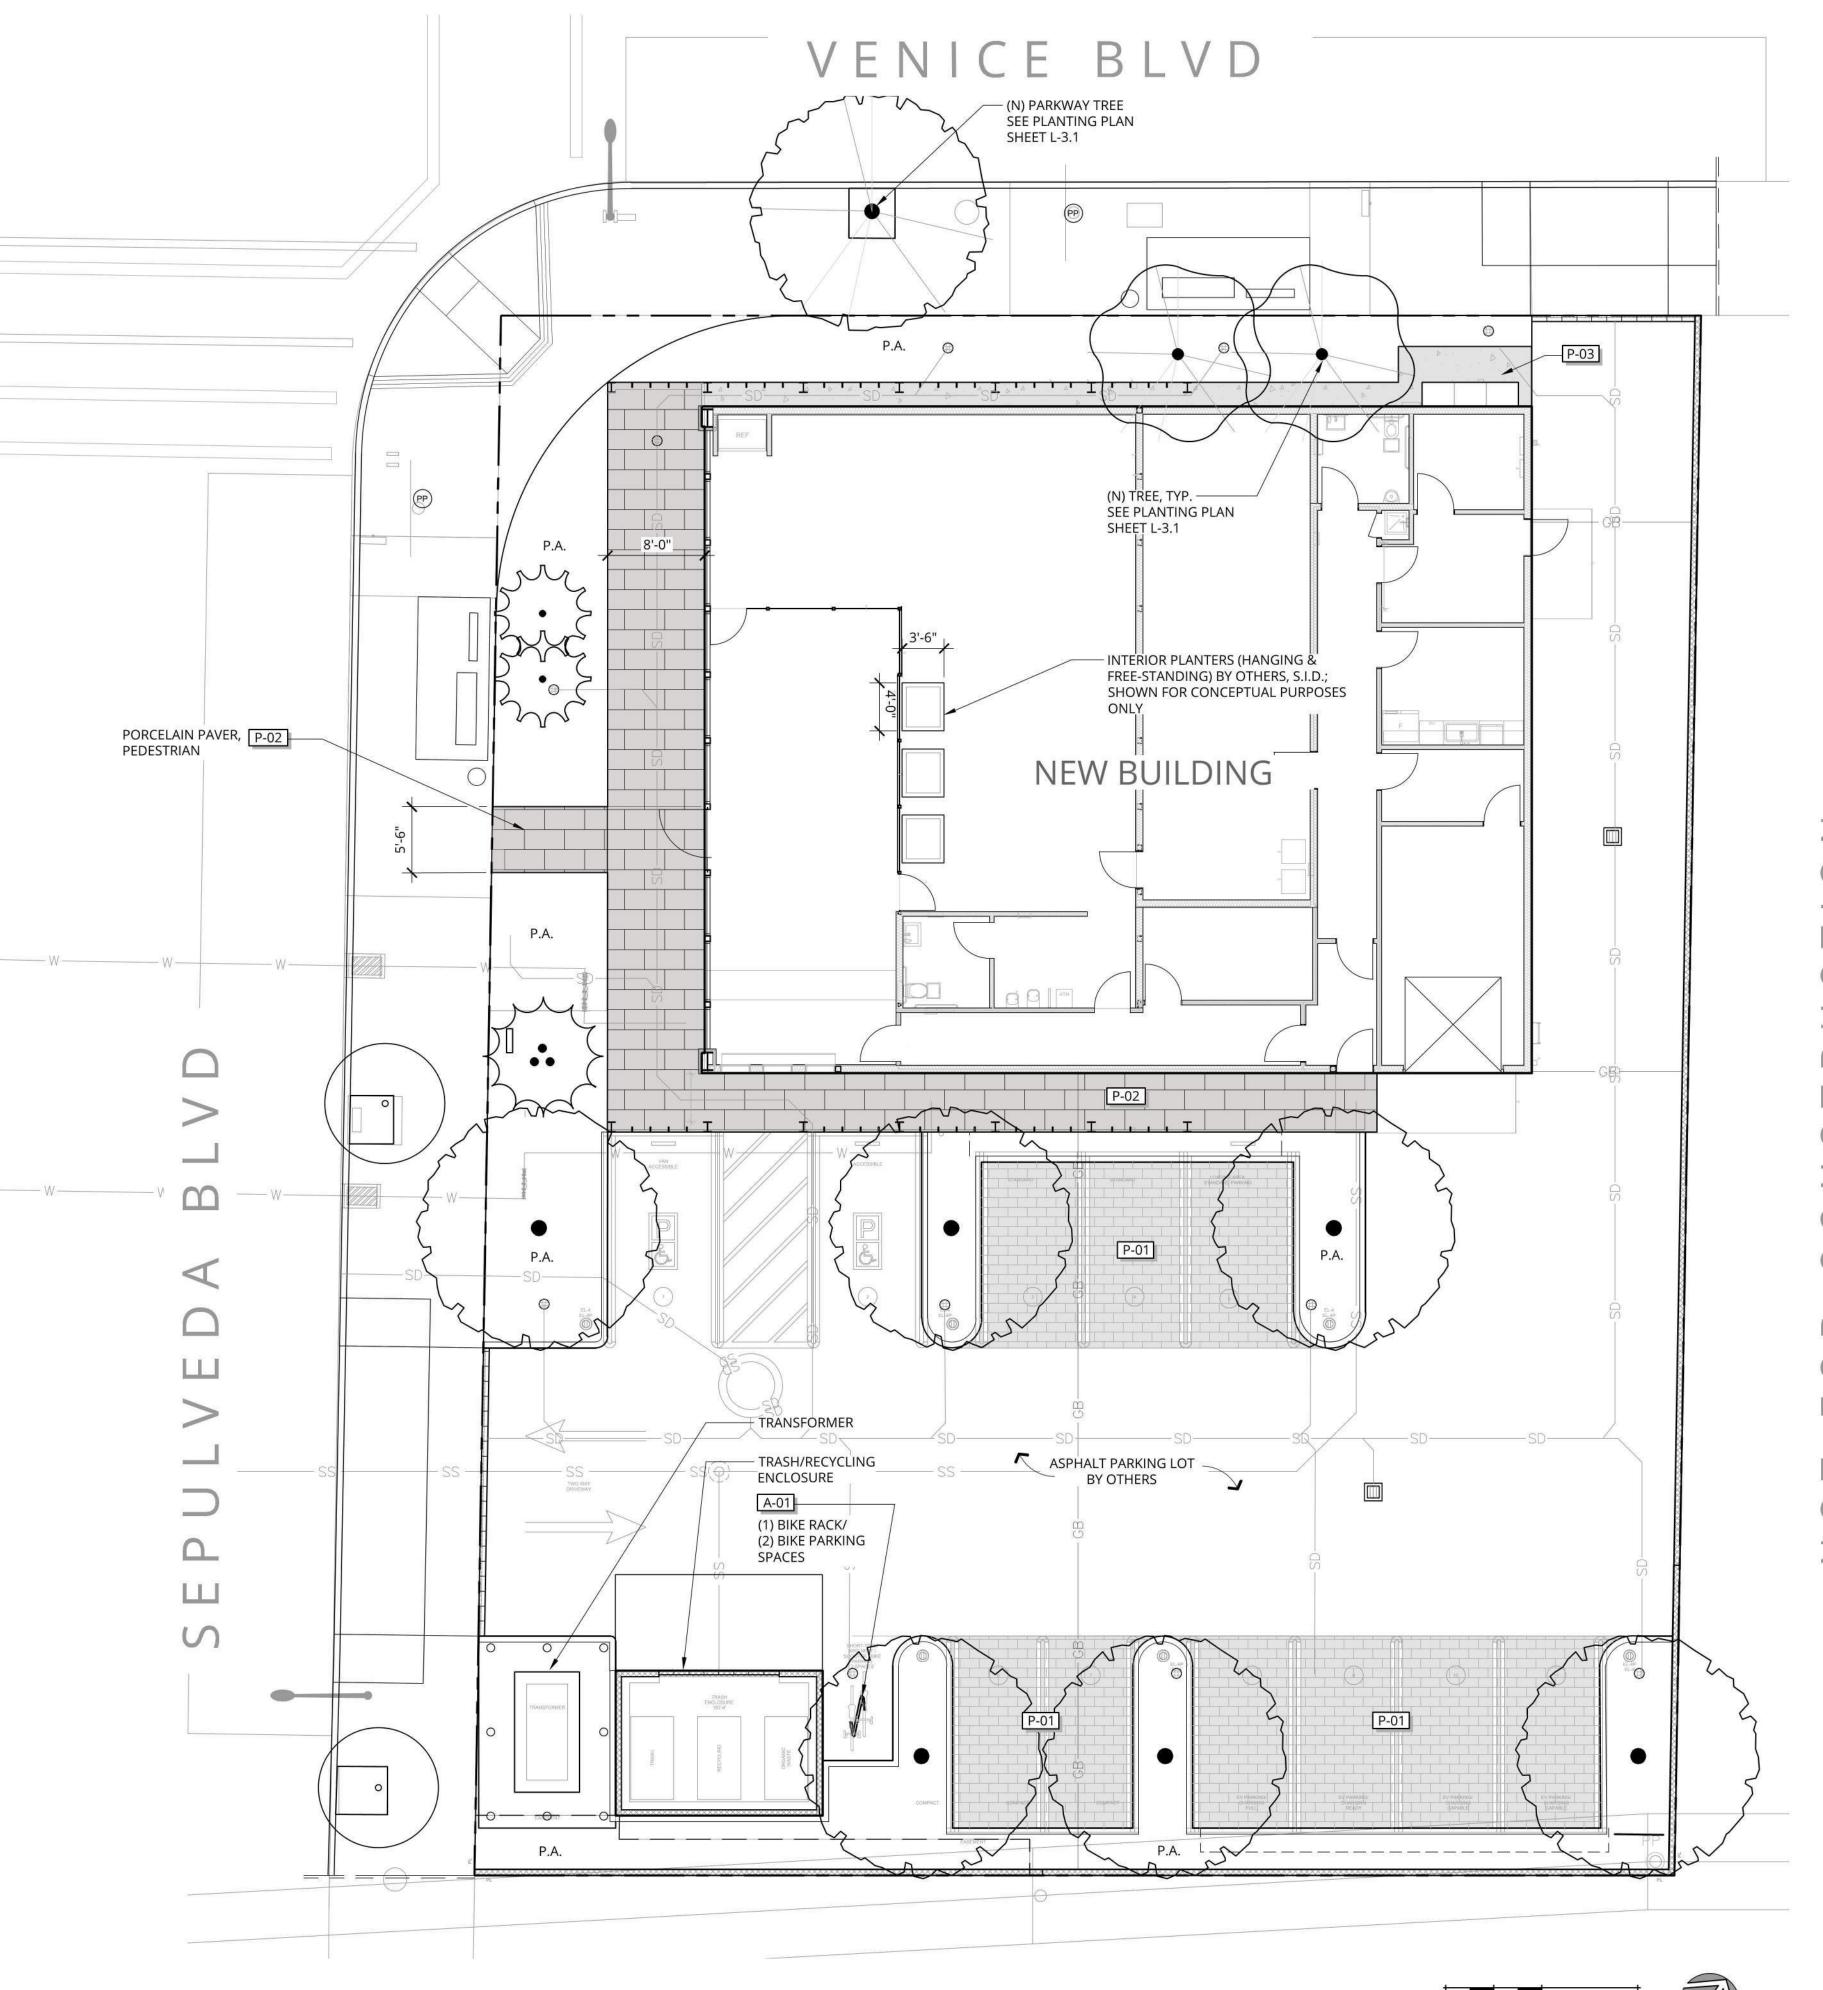



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Signature
Renewal Date
REVISIONS

7/29/21 60% CD
8/20/21 80% CD
1/7/22 90% CD

PROJECT NUMBER

1950

DRAWN BY

NH

DATE DRAWN

11/21/19

SCALE

1/8"=1'-0"

PRINT DATE

1/7/22

SHEET NUMBER

1/7/22

SCALE: ⅓" = 1'-0"

ADDITIONAL PLANT MATERIAL NOTES

- IN ADDITION TO THE PLANTS INCLUDED ON THE PLANTING PLANS, THE CONTRACTOR SHALL INCLUDE THE FOLLOWING IN HIS/HER BID: (25) 1-GAL SHRUBS (15) 5-GAL SHRUBS
- 2. ADDITIONAL PLANTS SHALL BE SPOTTED BY THE LANDSCAPE ARCHITECT IN THE FIELD AS NEEDED.
- 3. CONTRACTOR SHALL CREDIT THE OWNER FOR ANY ADDITIONAL PLANT MATERIAL THAT HAS NOT BEEN USED IN THE INSTALLATION.

ROOT BARRIER NOTES

- 1. FOR ALL TREES PLANTED WITHIN 5'-0" OF ANY CURB, WALL, HARDSCAPE ELEMENT, BUILDING, FIRE HYDRANT, UTILITY VAULT, UTILITY LINE/CONDUIT OR LIGHT FIXTURE, THE CONTRACTOR SHALL INSTALL AN 8'-0" LENGTH OF 24" DEEP ROOT BARRIER. REFER TO PLANTING DETAILS.
- 2. NO ROOT BARRIER SHALL ENCIRCLE THE ROOTBALL.

PLANT SUBSTITUTIONS & PRICING NOTES

- 1. SUBSTITUTIONS SHALL NOT BE ALLOWED WITHOUT PRIOR REVIEW AND APPROVAL BY LANDSCAPE ARCHITECT.
- 2. ANY MATERIAL ORDERED WITHOUT AUTHORIZATION BY THE LANDSCAPE ARCHITECT SHALL BE CORRECTED TO CONFORM WITH THE FINAL (PERMITTED) PLANTING PLANS AT NO ADDITIONAL COST TO THE OWNER OR LANDSCAPE ARCHITECT.
- 3. CONTRACTOR SHALL BASE BIDS AND PRICING ON THE MOST EXPENSIVE COMBINATION OF QUALITY AND OR QUANTITY OF WORK INDICATED.

VINE TIE NOTES

- 1. REFER TO PLANTING DETAILS FOR INSTRUCTIONS ON HOW TO ATTACH VINES TO STRUCTURES, WALLS, FENCES, ETC.
- 2. SELF-CLINGING VINES DO NOT REQUIRE SUPPORT.

SIGHT VISIBILITY NOTES

- 1. EXISTING TREES LOCATED WITHIN THE SIGHT VISIBILITY TRIANGLE SHALL BE PRUNED SO THAT THE LOWEST BRANCH IS A MINIMUM OF 7'-6" ABOVE THE FINISH GRADE.
- 2. NO NEW TREES SHALL BE PLANTED WITHIN THE SIGHT VISIBILITY TRIANGLE.
- . SHRUBS AND GROUND COVERS LOCATED WITHIN THE SIGHT VISIBILITY TRIANGLE SHALL BE PRUNED AND MAINTAINED SO THAT THE MAXIMUM HEIGHT DOES NOT EXCEED 2'-0" ABOVE THE FINISH GRADE.

MWELO CERTIFICATE OF COMPLETION & COMPLIANCE NOTES

A CERTIFICATE OF COMPLETION IN ACCORDANCE WITH MWELO SECTION 492.9 WILL BE SUBMITTED FOR REVIEW/APPROVAL BY THE BUILDING AND SAFETY DIVISION PRIOR TO FINAL OCCUPANCY OF THE PROJECT. THE CERTIFICATE OF COMPLETION SHALL CONTAIN, AT A MINIMUM, THE FOLLOWING:

- 1. PROJECT INFORMATION
- 2. CERTIFICATION BY EITHER THE SIGNER OF THE LANDSCAPE DESIGN PLAN, THE SINGER OF THE IRRIGATION DESIGN PLAN, OR THE LICENSED LANDSCAPE CONTRACTOR THAT THE LANDSCAPE PROJECT HAS BEEN INSTALLED PER THE APPROVED LANDSCAPE
- DOCUMENTATION PACKAGE

 3. IRRIGATION SCHEDULING PARAMETERS USED TO SET THE
- CONTROLLER (SEE MWELO SECTION 492.10)
- 4. LANDSCAPE AND IRRIGATION MAINTENANCE SCHEDULE (SEE MWELO SECTION 492.11)

 5. IRRIGATION ALDIT REPORT (SEE MWELO SECTION 492.12)
- 5. IRRIGATION AUDIT REPORT (SEE MWELO SECTION 492.12)
 6. SOIL ANALYSIS REPORT

NOTES: WHERE SIGNIFICANT CHANGES HAVE BEEN MADE IN THE FIELD DURING INSTALLATION, AN "AS-BUILT" PLAN SHALL BE INCLUDED WITH THE CERTIFICATION. A DIAGRAM OF THE IRRIGATION PLAN SHOWING HYDROZONES SHALL BE KEPT WITH THE IRRIGATION CONTROLLER FOR SUBSEQUENT MANAGEMENT PURPOSES.

WATER EFFICIENT LANDSCAPE ORDINANCE COMPLIANCE STATEMENT

I HAVE COMPLIED WITH THE CRITERIA IN MWELO AND APPLIED THEM FOR THE EFFICIENT USE OF WATER IN THE LANDSCAPE

SIGNATURE:

DESIGN PLAN

PLANTING GENERAL NOTES

- PLANT MATERIAL SHALL MEET THE HIGHEST QUALITY INDUSTRY STANDARD.
- 2. PLANT MATERIAL SHALL BE SOURCED WITHIN TWO WEEKS OF AWARD OF CONTRACT. CONTRACTOR SHALL NOTIFY LANDSCAPE ARCHITECT IMMEDIATELY OF ANY SOURCING DIFFICULTY.
- 3. CONTRACTOR SHALL VERIFY PLANTING INSTALLATION DATE WITH LANDSCAPE ARCHITECT A MINIMUM OF FOUR (4) WEEKS PRIOR TO INSTALLATION.
- 4. LANDSCAPE ARCHITECT RESERVES THE RIGHT TO REFUSE PLANT MATERIAL DELIVERED TO THE SITE THAT IS SUBSTANDARD. CONTRACTOR SHALL SUPPLY REPLACEMENT PLANT MATERIAL AT NO ADDITIONAL COST TO OWNER.
- 5. CONTRACTOR SHALL CHALK OUT LOCATIONS OF VINE TIE CONNECTORS FOR REVIEW BY THE LANDSCAPE ARCHITECT PRIOR TO INSTALLATION.
- 6. CONTRACTOR SHALL PLACE ALL PLANT MATERIAL IN LOCATIONS AS INDICATED ON THE PLANS FOR REVIEW AND APPROVAL BY LANDSCAPE ARCHITECT PRIOR TO PLANTING.
- 7. CONTRACTOR SHALL VERIFY QUANTITY OF PLANTS GRAPHICALLY INDICATED ON THE PLAN. IF DISCREPANCIES BETWEEN QUANTITIES INDICATED ON PLAN AND PLANT SCHEDULE OCCUR, CONSULT LANDSCAPE ARCHITECT FOR CLARIFICATION.
- 8. PLANT MATERIAL SHALL BE PLANTED PER DETAILS AND SPECIFICATIONS. SOIL PREPARATION, WEED REMOVAL AND AMENDMENTS SHALL BE PER THE PLANTING SPECIFICATIONS OR RECOMMENDATIONS OF THE AGRONOMIC SOILS REPORT (AS AVAILABLE).
- CONTRACTOR SHALL PROVIDE AND INSTALL 3" MIN. DEPTH WOOD MULCH OR GRAVEL IN PLANTED AREAS PER SPECIFICATIONS AND AS SHOWN ON THE PLANTING PLANS & DETAILS. CONTRACTOR SHALL PROVIDE WOOD MULCH AND/OR GRAVEL SAMPLES FOR REVIEW AND APPROVAL BY LANDSCAPE ARCHITECT PRIOR TO PURCHASE.
- 10. CONTRACTOR SHALL BE RESPONSIBLE FOR FINISH GRADES AND FINE GRADING REQUIRED FOR SURFACE DRAINAGE AND UNIFORMITY TO THE SATISFACTION OF THE LANDSCAPE ARCHITECT. CONTRACTOR SHALL ADVISE LANDSCAPE ARCHITECT OF DRAINAGE PROBLEMS IMMEDIATELY AND MAKE RECOMMENDATIONS FOR SOLUTION.
- 11. PLANT WARRANTY SHRUBS: CONTRACTOR SHALL GUARANTEE PLANT MATERIAL 5-GALLON OR SMALLER FOR A PERIOD OF NINETY (90) DAYS FROM DATE OF SUBSTANTIAL COMPLETION DETERMINATION.
- 12. PLANT WARRANTY TREES & SPECIMENS: CONTRACTOR SHALL GUARANTEE TREES AND SPECIMEN PLANT MATERIAL 15-GALLON AND LARGER FOR A PERIOD OF ONE (1) YEAR FROM DATE OF SUBSTANTIAL COMPLETION DETERMINATION.
- 13. CONTRACTOR SHALL REPLACE DEAD PLANTS AND PLANTS NOT IN VIGOROUS CONDITION, WITHOUT COST TO OWNER, AS DETERMINED BY LANDSCAPE ARCHITECT AT THE END OF THE WARRANTY PERIOD.

PLANT SCHEDULE NOTES

- 1. ALL TREES & SPECIMEN PLANTS 15-GAL AND LARGER ARE TO BE SELECTED AND TAGGED BY THE LANDSCAPE ARCHITECT.

 2. CONTRACTOR SHALL NOTICY LANDSCAPE ARCHITECT A MINIMUM FOLIR (A).
- CONTRACTOR SHALL NOTIFY LANDSCAPE ARCHITECT A MINIMUM FOUR (4) WEEKS IN ADVANCE OF PLANTING TIME.
- 3. ABOVE-GRADE UTILITIES SHALL BE SCREENED TO THE MAXIMUM EXTENT FEASIBLE.
- 4. PLANTS LISTED AS 'ALERT' STATUS BY THE CALIFORNIA INVASIVE PLANT COUNCIL (CAL-IPC) SHALL NOT BE USED FOR LANDSCAPING, REFER TO INVENTORY AT: WWW.CAL-IPC.ORG/PLANTS/INVENTORY

DEFINITIONS

B.T.H. BROWN TRUNK HEIGHT
L.B. LOW BRANCHED
NTRL. NATURAL HABIT, FIELD-GROWN
MULTI MULTI-BRANCHED

STD. STANDARD FORM
OR EQ. CONTRACTOR TO LOCATE VARIETY LISTED OR EQUIVALENT VARIETY
WITHIN SAME SPECIES WITH SIMILAR MATURE SIZE, GROWTH HABIT,
COLOR OF FOLIAGE AND FLOWERS.

WATER USE

CATEGORIES OF WATER USE ARE DEFINED BY WUCOLS IV. WATER USE

CLASSIFICATION OF LANDSCAPE SPECIES. COSTELLO & JONES,

UNIVERSITY OF CALIFORNIA COOPERATIVE EXTENSION. 4TH EDITION,

2014. AND AS AMENDED IN THE CITY OF SANTA BARBARA

ADDENDUM TO THE WUCOLS PLANT LIST, 2019.

SOIL AMENDMENT NOTES

THE FOLLOWING NOTES ARE FOR BIDDING PURPOSES ONLY:

- CONTRACTOR SHALL BE RESPONSIBLE FOR OBTAINING AN AGRONOMIC SOILS REPORT PER THE PLANTING SPECIFICATIONS, AND SHALL FOLLOW THE SOIL AMENDMENT AND BACKFILL RECOMMENDATIONS PER THE REPORT.
- QUANTITIES AND MATERIALS RECOMMENDED IN THE SOILS REPORT SHALL SUPERCEDE THE FOLLOWING REQUIREMENTS AT THE DISCRETION OF THE LANDSCAPE ARCHITECT.
- 3. PRE-PLANTING SOIL PREPARATION: CULTIVATE TO A DEPTH OF 12" WITH THE FOLLOWING AMENDMENTS PER 1,000 SQUARE FEET:
 4 CY N-FORTIFIED REDWOOD SHAVINGS
 60 LBS GROW POWER PLUS
 - 1-½ LBS GROW POWER PLUS
 TRI-C ENDO 120
- CONTRACTOR SHALL PROVIDE BACKFILL MIX PER THE PLANTING SPECIFICATIONS FOR TREES AND SHRUBS, NATIVE PLANTS, PLANTER POTS AND PLANTERS ON-STRUCTURE.

COURTNEY JANE MILLER LANDSCAPE ARCHITECTURE Office 805 698 2120 email INFO@CJM-LA.COM 1221 STATE STREET SUITE 206 SANTA BARBARA CA 93101

 \Box S

CJM::LA

BEYOND / HELLO 3800 Sepulveda Blvd. Culver City, CA 90230



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1/7/22 90% CD

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PLANT SCHEDULE (ABBREVIATED)

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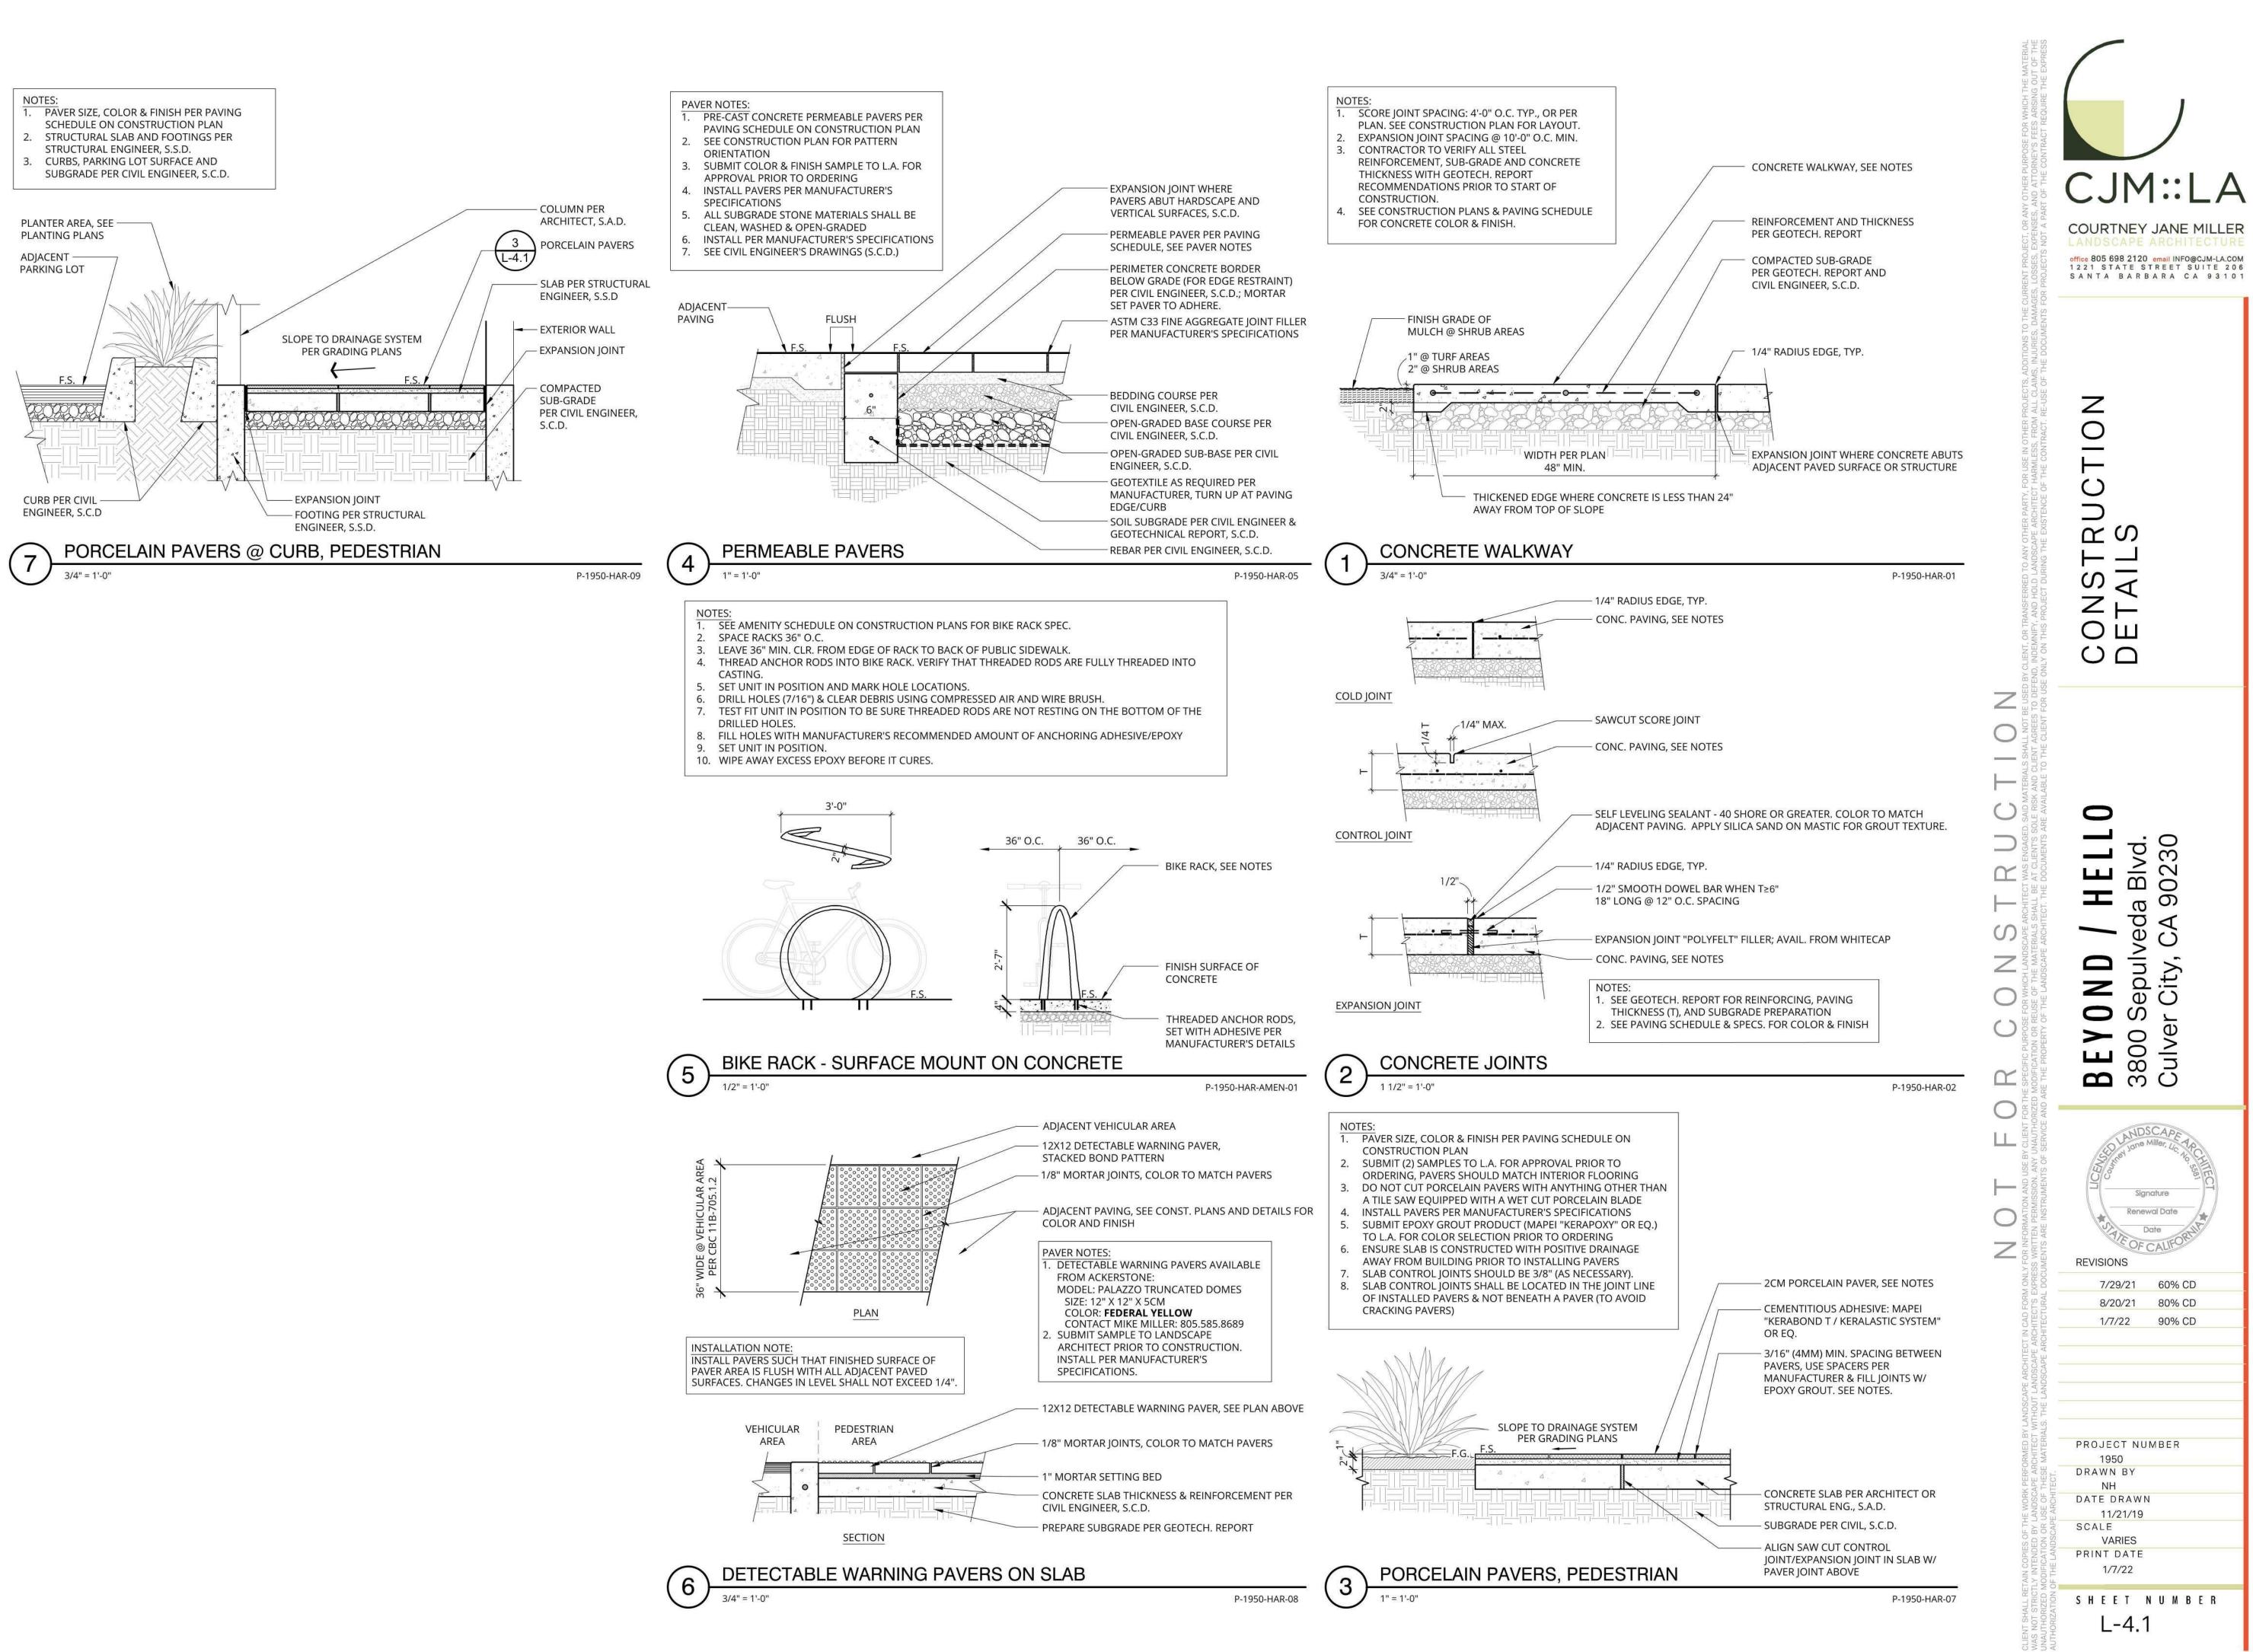
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CJM::LA COURTNEY JANE MILLER office 805 698 2120 email INFO@CJM-LA.COM 1221 STATE STREET SUITE 206 SANTA BARBARA CA 93101 Д 3lvd.)230 Sepulveda Bl City, CA 902 OND **BEY0** 3800 Se Culver (Renewal Date **REVISIONS** 7/29/21 60% CD 8/20/21 80% CD 1/7/22 90% CD PROJECT NUMBER 1950 DRAWN BY DATE DRAWN 11/21/19

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